
ENVIRONMENTAL PERMIT PLANS STATE PROJECT 999-999 ROUNDABOUT AT AN INTERSECTION ROUTE X AND ROUTE Y TOWN OF _____

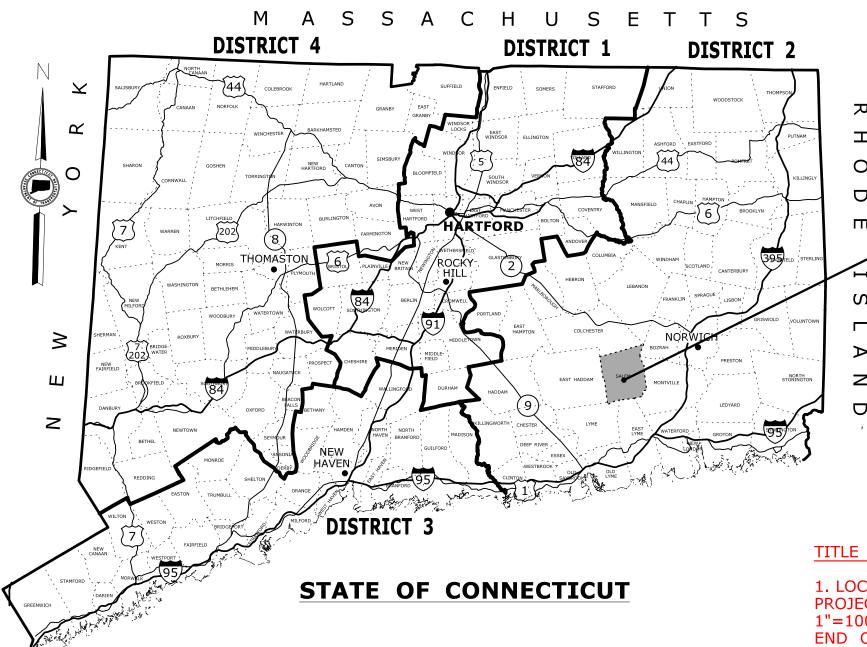

ON ALL OTHER PLAN VIEWS:

1. WETLAND LIMITS BOLD (NOT SCREENED)
2. SHOW CUT/FILL LIMITS AND SEDIMENTATION CONTROL SYSTEM (SCS). (SCS NOT NECESSARY ON PLANTING PLAN)
3. SHOW ORDINARY HIGH WATER (OHW)

4. SHOW FLOOD LIMIT LINES ON PLAN VIEWS

A) CALCULATED ELEVATION ON A FEMA MAP GOVERNS. LABEL

"FEMA 100-YR FLOOD (CALCULATED)"

B) OTHERWISE, SHOW HYDRAULIC ANALYSIS ELEVATION. LABEL
"EXISTING 100-YR FLOOD (CALCULATED)"

C) IF NO CALCULATIONS WERE PERFORMED, SHOW MAPPED FEMA LINES. LABEL "MAPPED FEMA 100-YR FLOOD LIMIT" 5. FLOW ARROWS (EXISTING AND PROPOSED)

GENERAL NOTES:

- 1. THESE PLANS ARE INTENDED ONLY FOR ENVIRONMENTAL PERMITTING PURPOSES. THESE PLANS HOLD AUTHORITY FOR ALL ACTIVITIES CONCERNING THE REGULATED AREA. FOR DETAILED PLANIMETRIC INFORMATION AND PAYMENT REFER TO THE APPLICABLE CONTRACT DOCUMENTS.
- 2. THE DEPARTMENT OF TRANSPORTATION WILL ONLY SUBMIT REVISIONS TO DEEP AND USACE FOR CHANGES TO THE DESIGN THAT WILL AFFECT REGULATED AREAS.
- 3. FOR A DESCRIPTION OF THE WATERCOURSES, WETLANDS AND WETLAND SOILS SEE RELEVANT SECTIONS OF THE PERMIT APPLICATION.
- 4. 400 FOOT GRID BASED ON CONNECTICUT COORDINATE SYSTEM N.A.D. 1927 VERTICAL DATUM BASED ON NGVD OF 1929.
- 5. ALL CONSTRUCTION ACTIVITIES WILL BE CONDUCTED IN ACCORDANCE WITH THE DEPARTMENT'S STANDARD SPECIFICATIONS FOR ROADS, BRIDGE, AND INCIDENTAL CONSTRUCTION, FORM 816, SECTION 1.10 AND WILL ALSO FOLLOW BEST MANAGEMENT PRACTICES (BMP'S) AND SEDIMENT AND EROSION CONTROL MEASURES IN ACCORDANCE WITH THE 2002 EROSION & SEDIMENTATION CONTROL GUIDELINES AND THE 2004 STORMWATER QUALITY MANUAL.

-PROJECT LOCATION

GUIDE FOR THE DEVELOPMENT OF THE PERMIT PLAN SET

TITLE SHEET:

- 1. LOCATION PLAN AT AN APPROPRIATE SCALE THAT SHOWS PROJECT LOCATION AND NEARBY CROSS STREETS (EX. 1"=500', 1"=1000'). FOR LATERAL PROJECTS, DEPICT BEGINNING AND END OF PROJECT (PROJECT LIMITS).
- 2. STATE OF CONNECTICUT MAP WITH TOWN SHADED AND CALL-OUT PROJECT LOCATION
- 3. GENERAL INDEX FOR "LIST OF DRAWINGS"
- 4. GENERAL NOTES 1-5 (ADDITIONAL NOTES MAY BE ADDED AS APPROPRIATE FOR THE PROJECT)
- 5. SIGNATURE BLOCK FOR CONSULTANT ENGINEER, IF NEEDED.
 6. PLAN DATE (LATEST REVISION DATE OF SHEET. DATES DO NOT NEED TO MATCH WITHIN PLAN SET)

NOTE: FOR ADDITIONAL ENVIRONMENTAL INFORMATION, SEE ALSO THE DEPARTMENT'S OFFICE OF ENVIRONMENTAL PLANNING'S PERMIT PLAN CHECKLIST FOUND ON THE WATER & NATURAL RESOURCES WEBPAGE UNDER "PERMITTING PROCESS"

SAMPLE PROJECT USED FOR PLANS

The following sample is an intersection improvement project. This specific project involves replacing a signalized intersection with a modern roundabout. The project includes roadway widening, storm drainage improvements, and contains wetland and floodplain impacts. The project also includes a proposed mitigation area. For this specific project, no water handling or staging plans were required.


The following permits are anticipated for this project:

DEEP Inland Water Resources Division Flood Management Certification (IWRD FMC)
General Permit for Water Resource Construction Activities (IWRD GP)
DEEP GP for Stormwater & Dewatering Wastewaters from Construction Activities (must be ezFile)
US Army Corps of Engineers Category 2 (USACE Cat 2)
Water Company Land Permit - Change in Use

The sample project falls within a mapped FEMA area with a calculated elevation provided on the FEMA map. This elevation is used in determining the floodplain impact area. An 8 1/2" x 11" FEMA map is provided within the permit application.

Environmental impact areas include ALL areas to be impacted due to the project construction and activities related to the project, both temporary and permanent. Engineering judgement should be used to determine the amount of area the contractor needs to perform the work, while trying to minimize the disturbance to the wetland resources. The designer should also evaluate utility work needed as part of the project and include any impacts due to project related utility work.

NOTE: This sample project has been altered from the actual project to produce this sample set of plans.

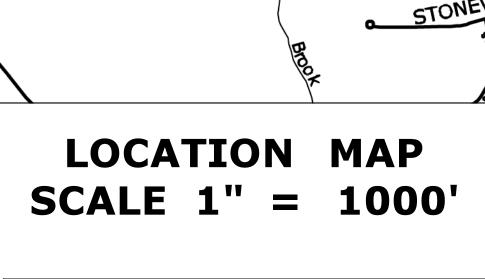

SALEM

PROJECT LOCATION

Salem

Four Corners

) Shingle Mill

Pond

Reservoir

Horse Pond

Fairy Lake

LIST OF DRAWINGS					
DRAWING NO.	DRAWING TITLE				
PMT-01	TITLE SHEET				
PMT-02-03	GENERAL SITE PLAN				
PMT-04-05	WETLAND IMPACT PLAN				
PMT-06-07	100-YR FLOOD IMPACT PLAN				
PMT-08-09	PERMIT PLANTING PLAN				
PMT-10	DETAIL SHEET				
PMT-02-03 PMT-04-05 PMT-06-07 PMT-08-09	GENERAL SITE PLAN WETLAND IMPACT PLAN 100-YR FLOOD IMPACT PLAN PERMIT PLANTING PLAN				

PLAN DATE: DECEMBER 7, 2015

				THE INFORMATION, INCLUDING ESTIMATED
				QUANTITIES OF WORK, SHOWN ON THESE SHEETS IS BASED ON LIMITED
				INVESTIGATIONS BY THE STATE AND IS IN NO WAY WARRANTED TO INDICATE
				THE CONDITIONS OF ACTUAL QUANTITIES
				OF WORK WHICH WILL BE REQUIRED.
REV.	DATE	REVISION DESCRIPTION	SHEET NO.	Plotted Date: 6/7/2016

DESIGNER/DRAFTER:

ED CHECKED BY:

S SCALE AS NOTED

STATE OF CONNECTICUT DEPARTMENT OF TRANSPORTATION

Filename: ...\HW_MSH_0120_0086_E&S_sample_Title.dgn

SIGNATURE/ BLOCK:

OFFICE OF ENGINEERING

APPROVED BY:


85


MORGAN ROAD


ROUNDABOUT AT AN INTERSECTION ROUTE X AND ROUTE Y


	PROJECT NO.
TOWN	999-999
TOWN	DRAWING NO.
G TITLE:	— PMT-01
	SHEET NO.


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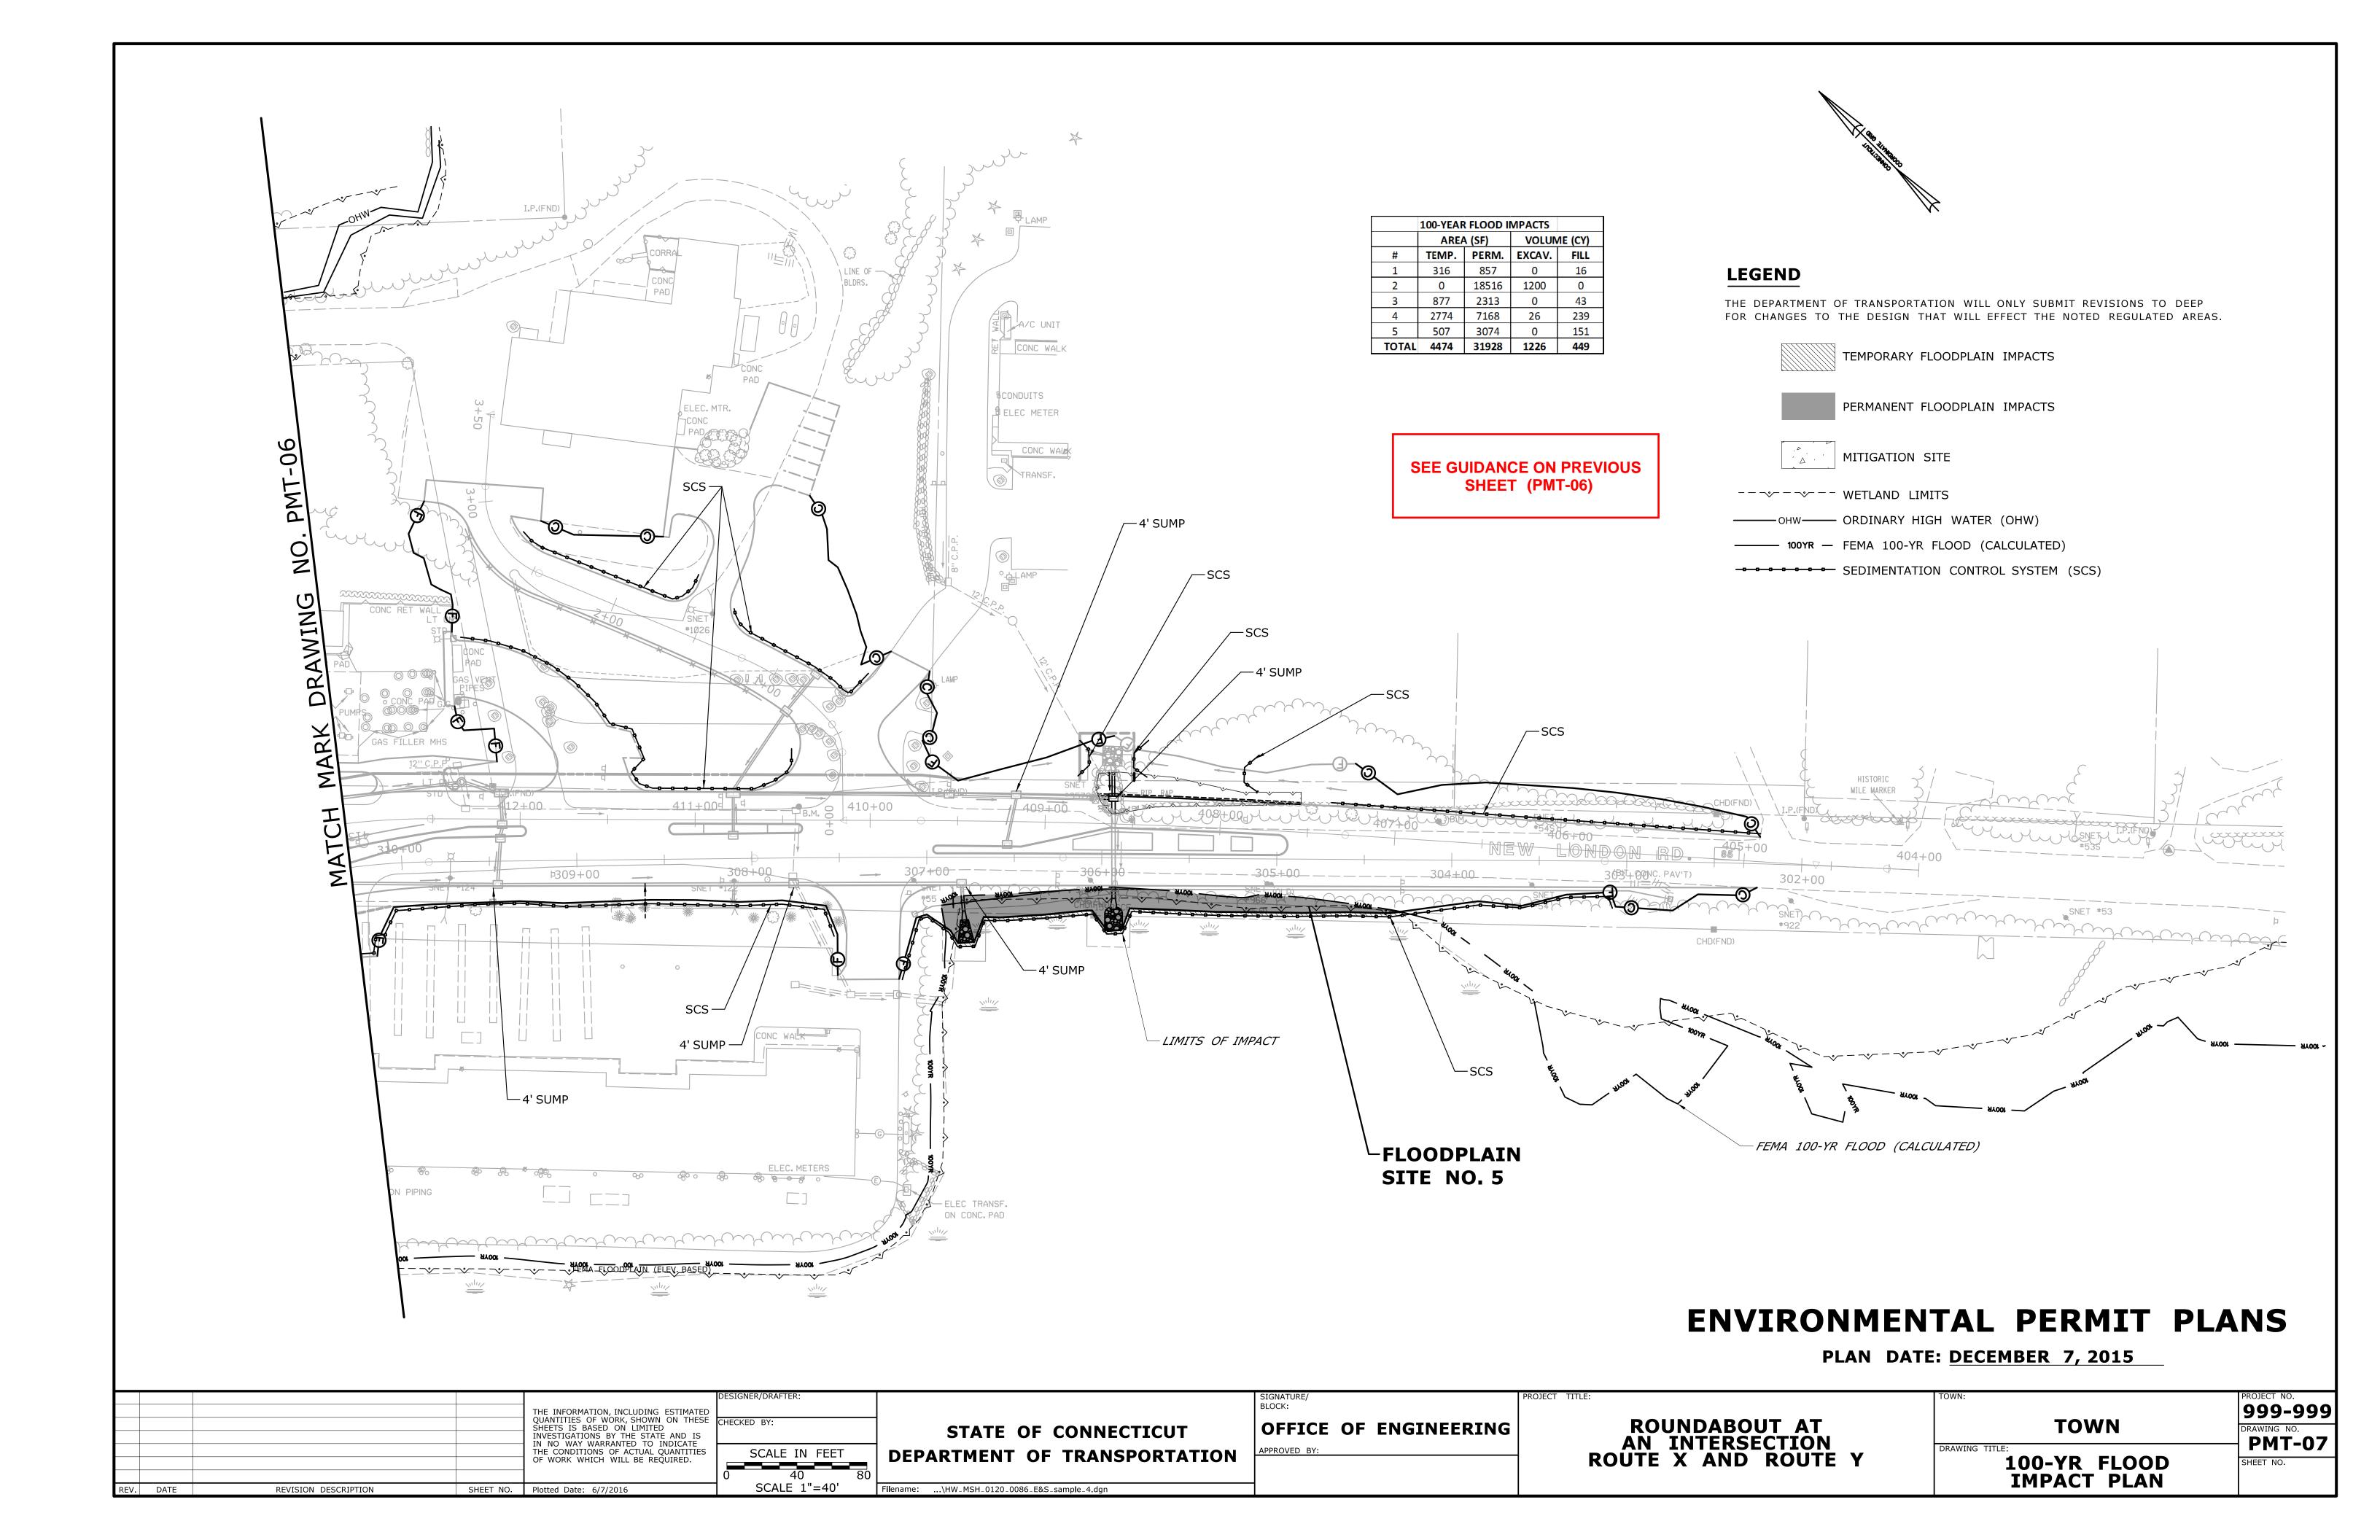


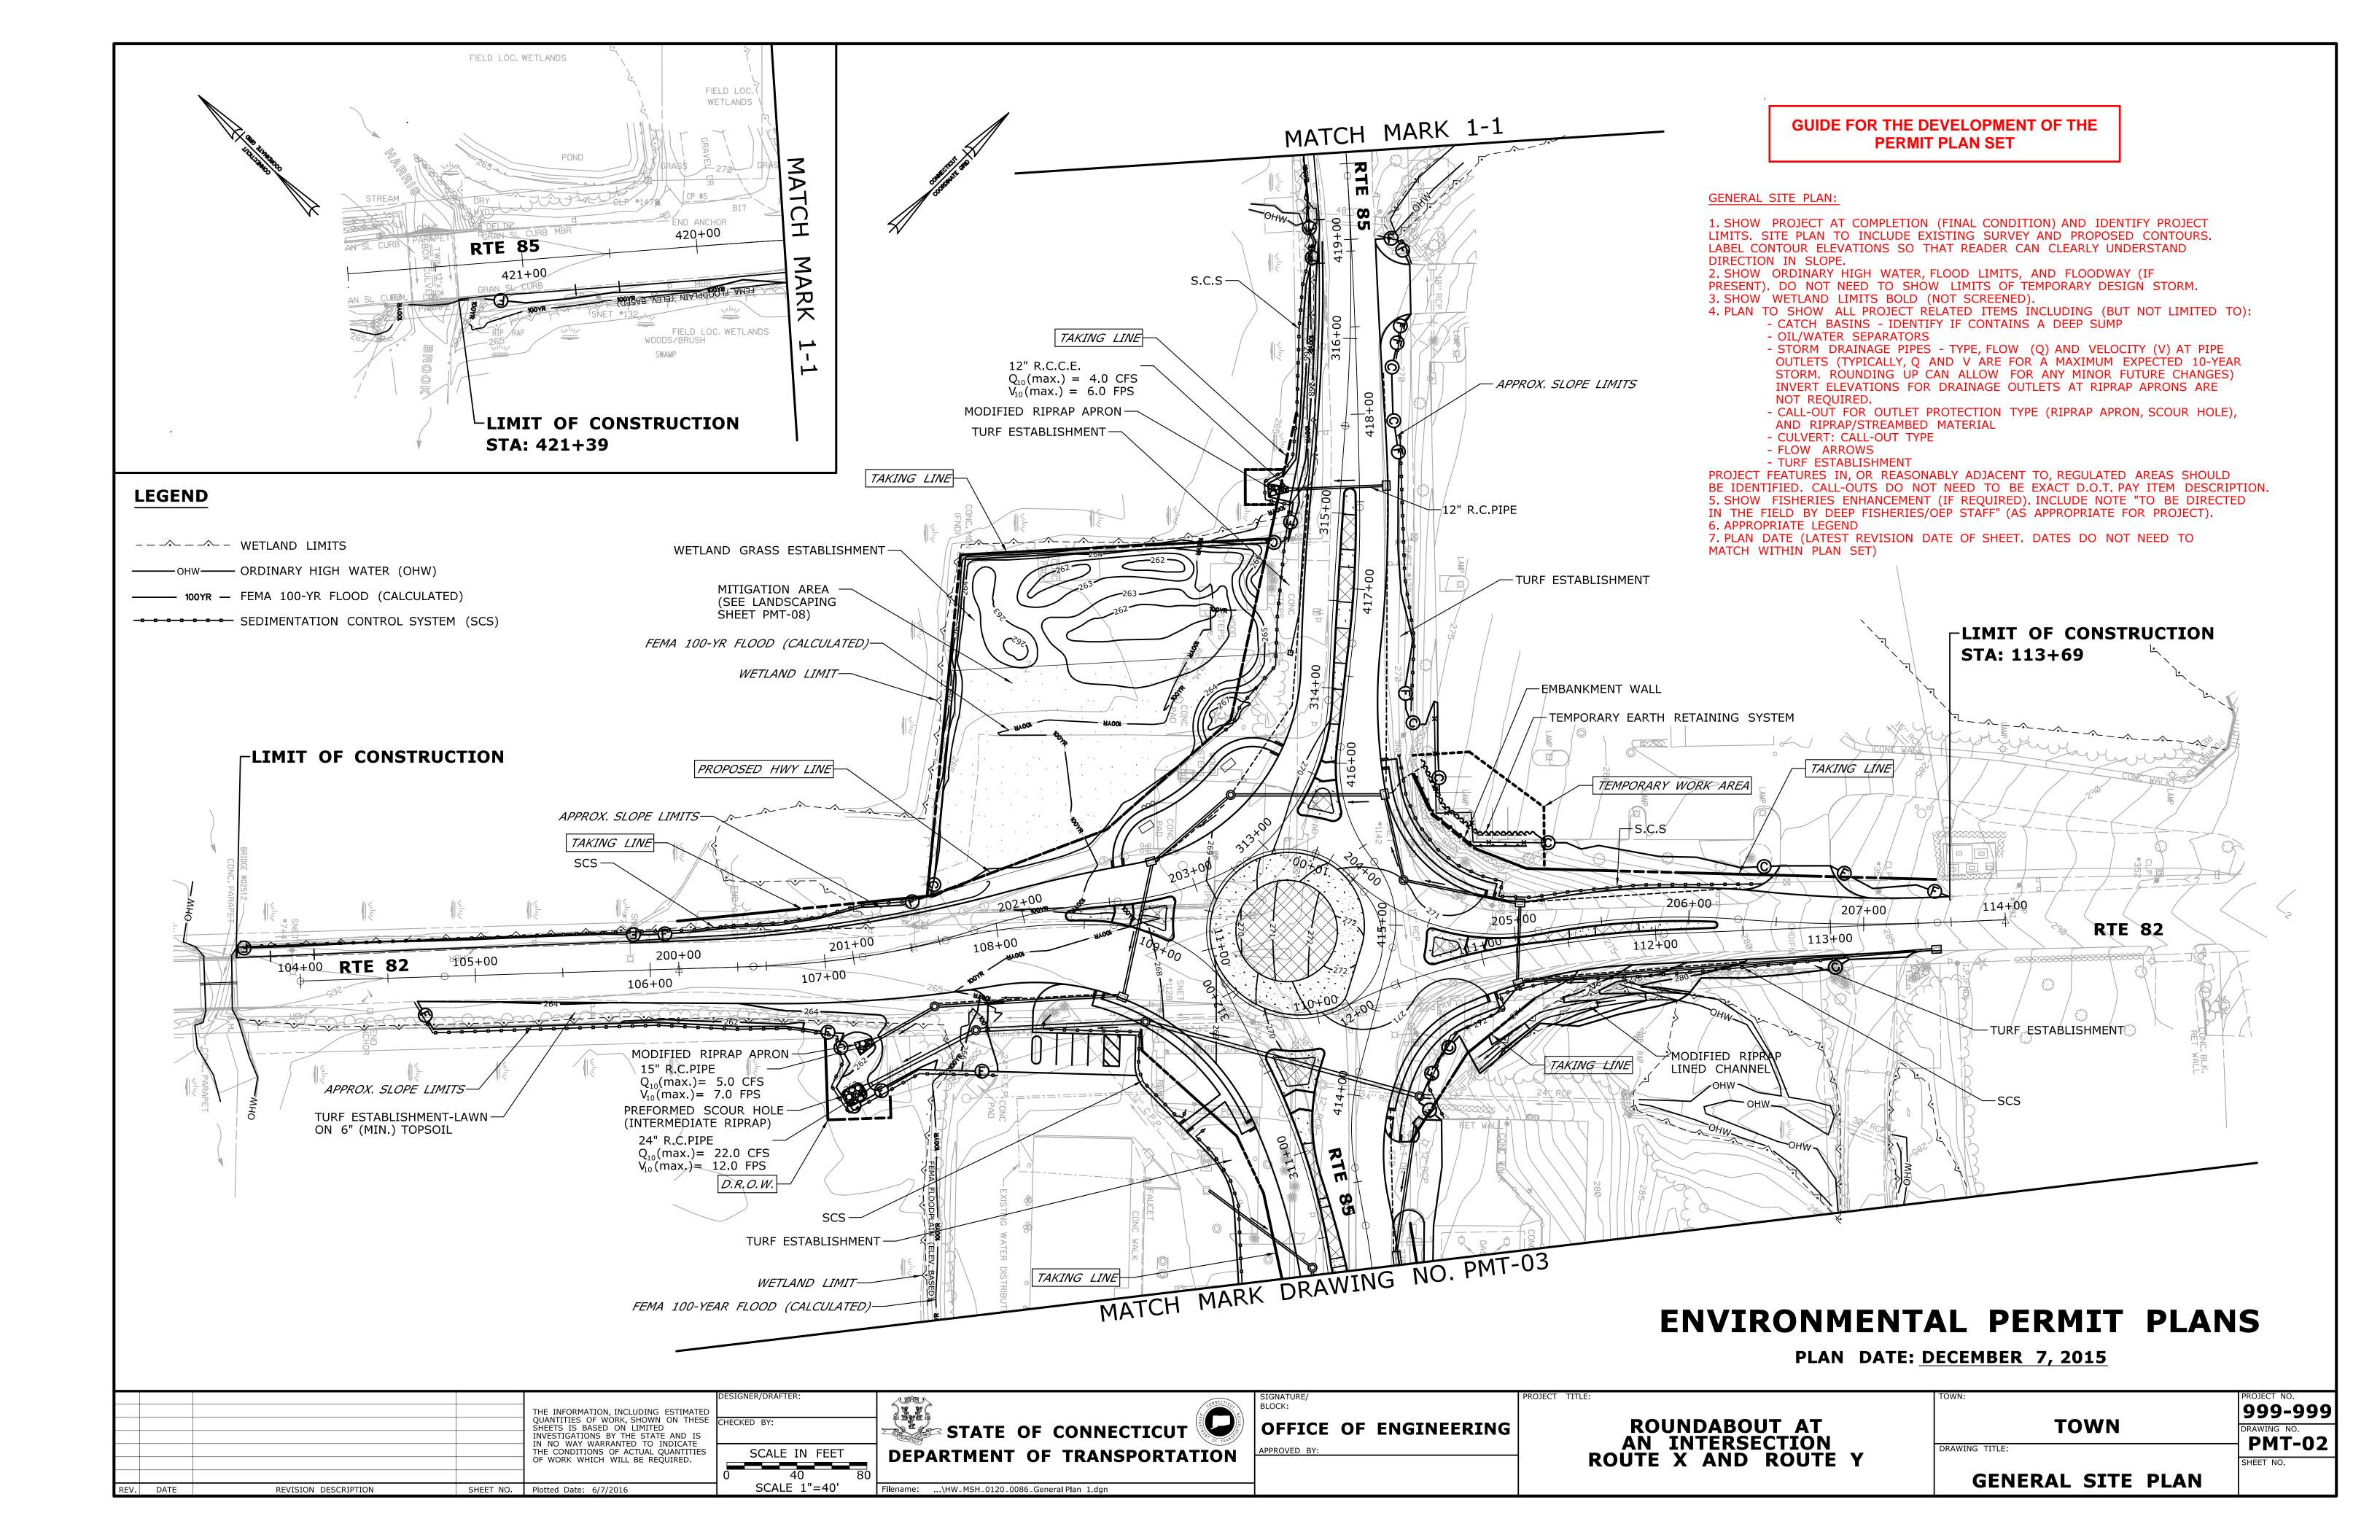


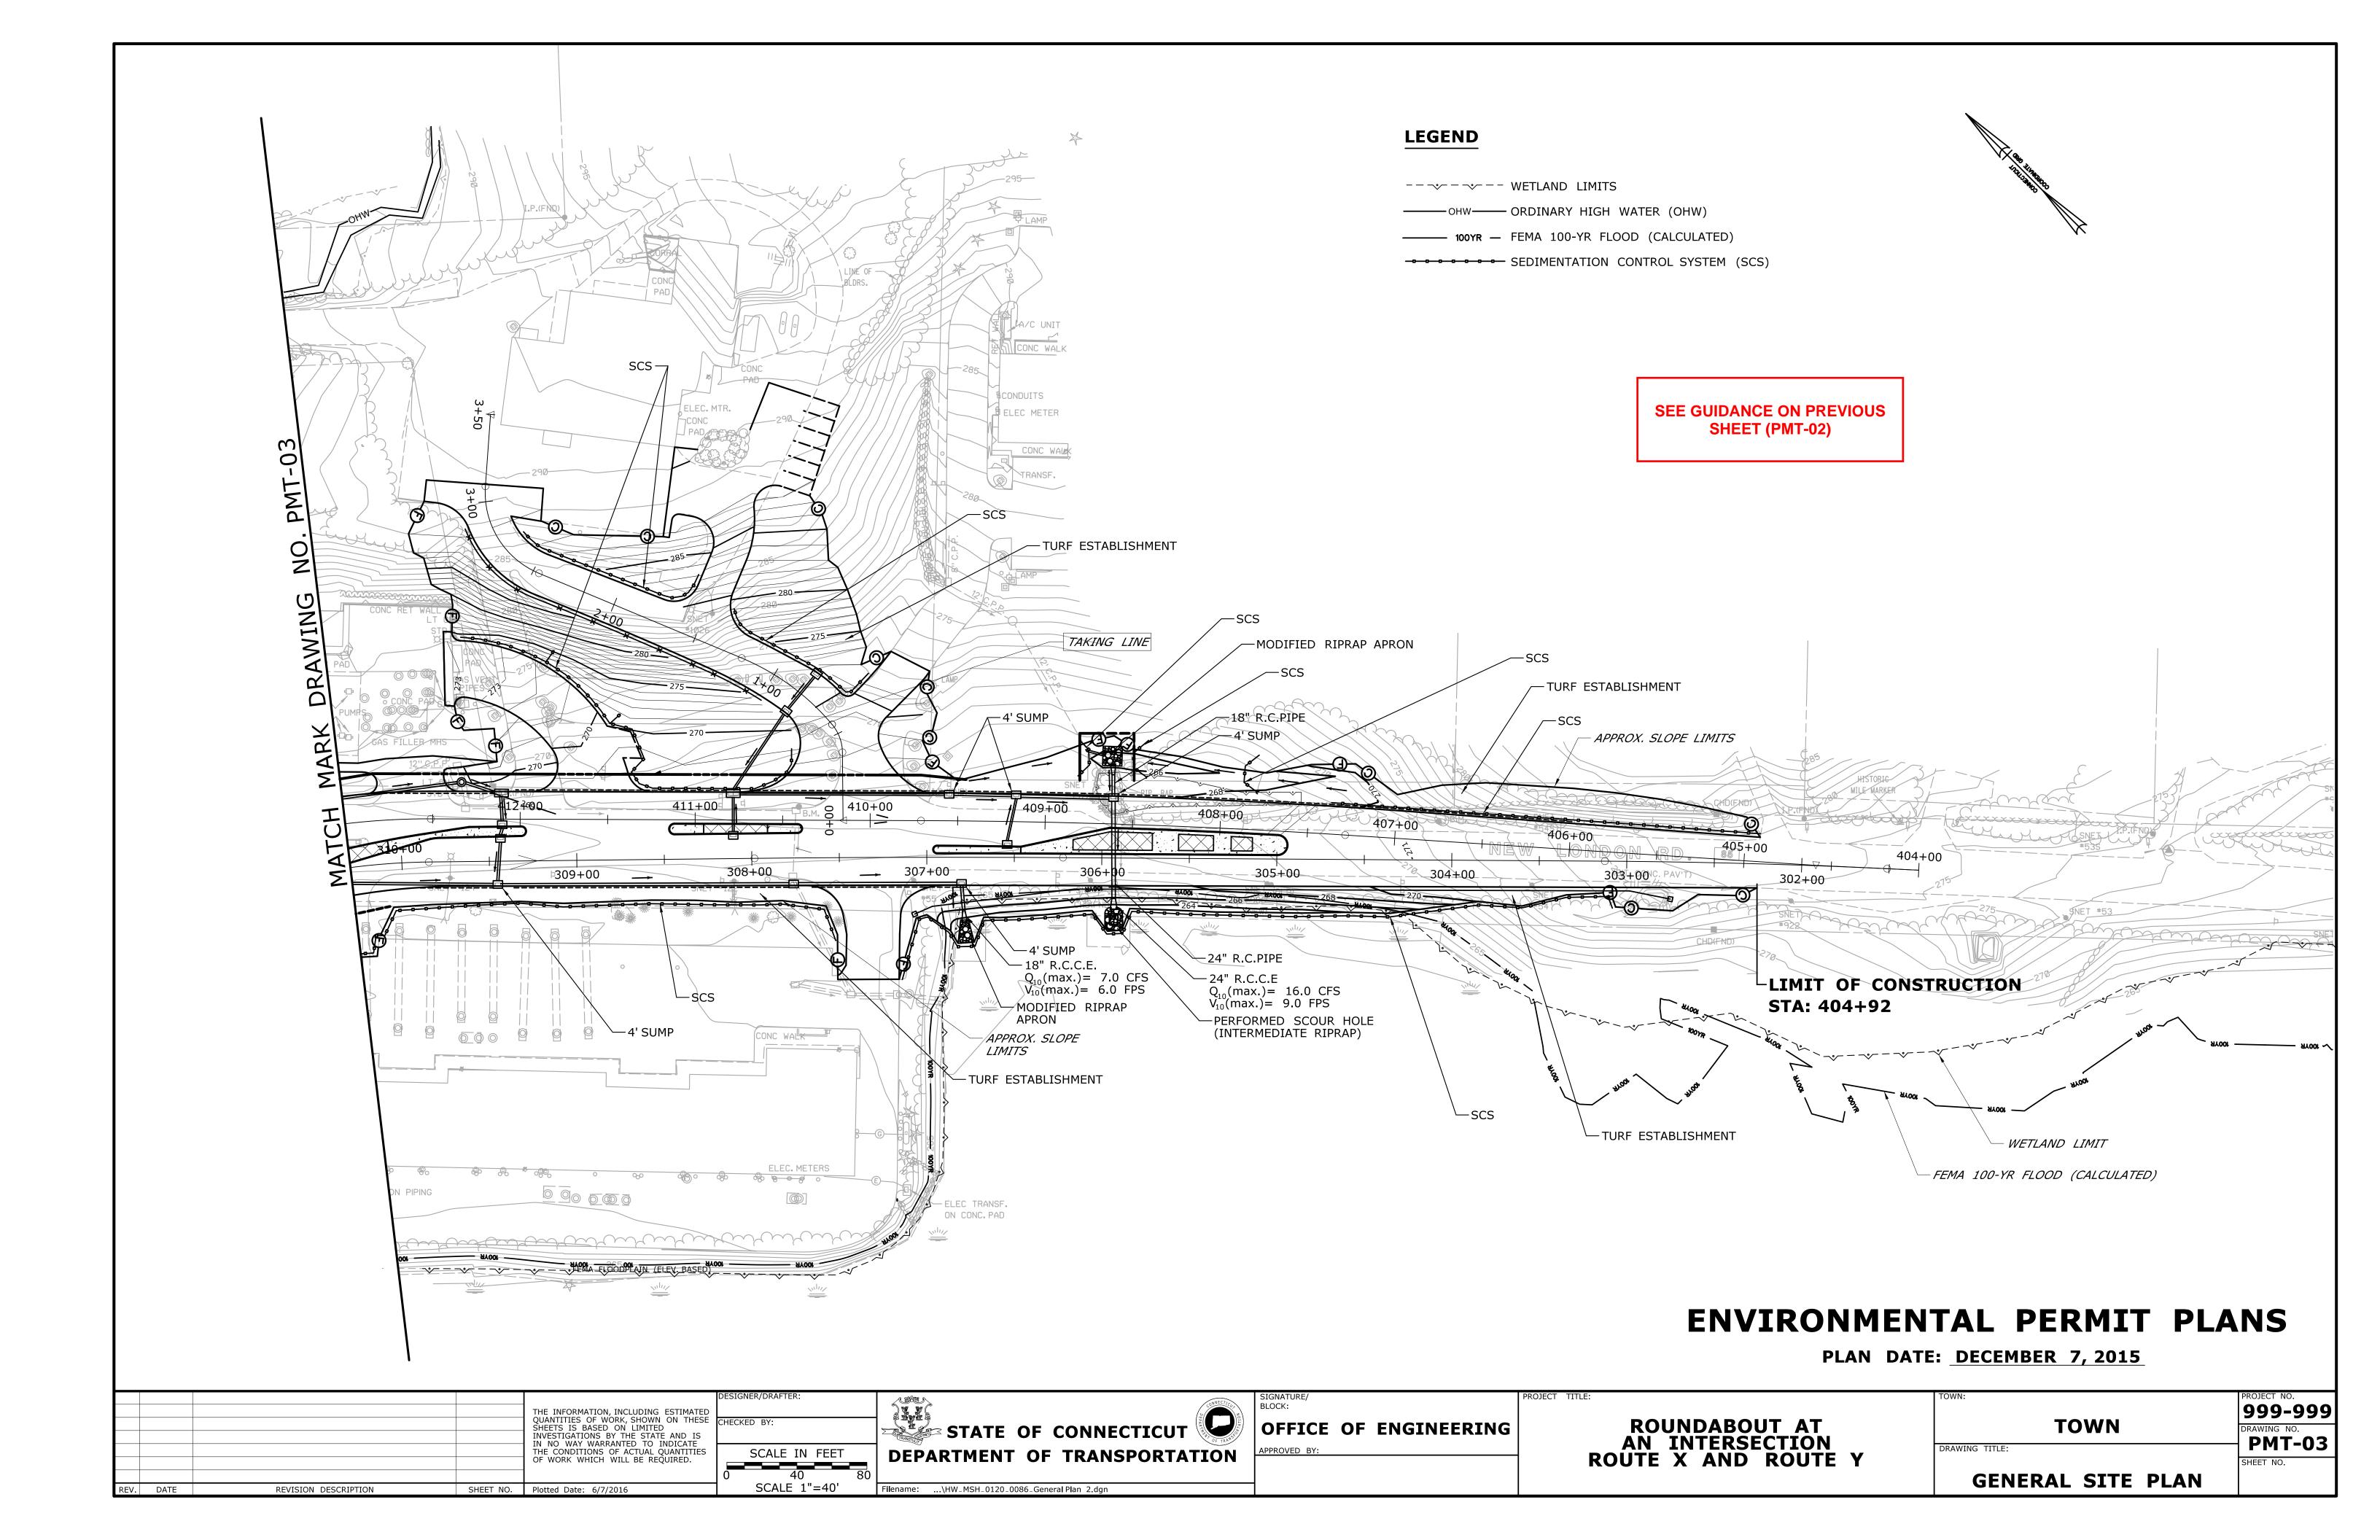


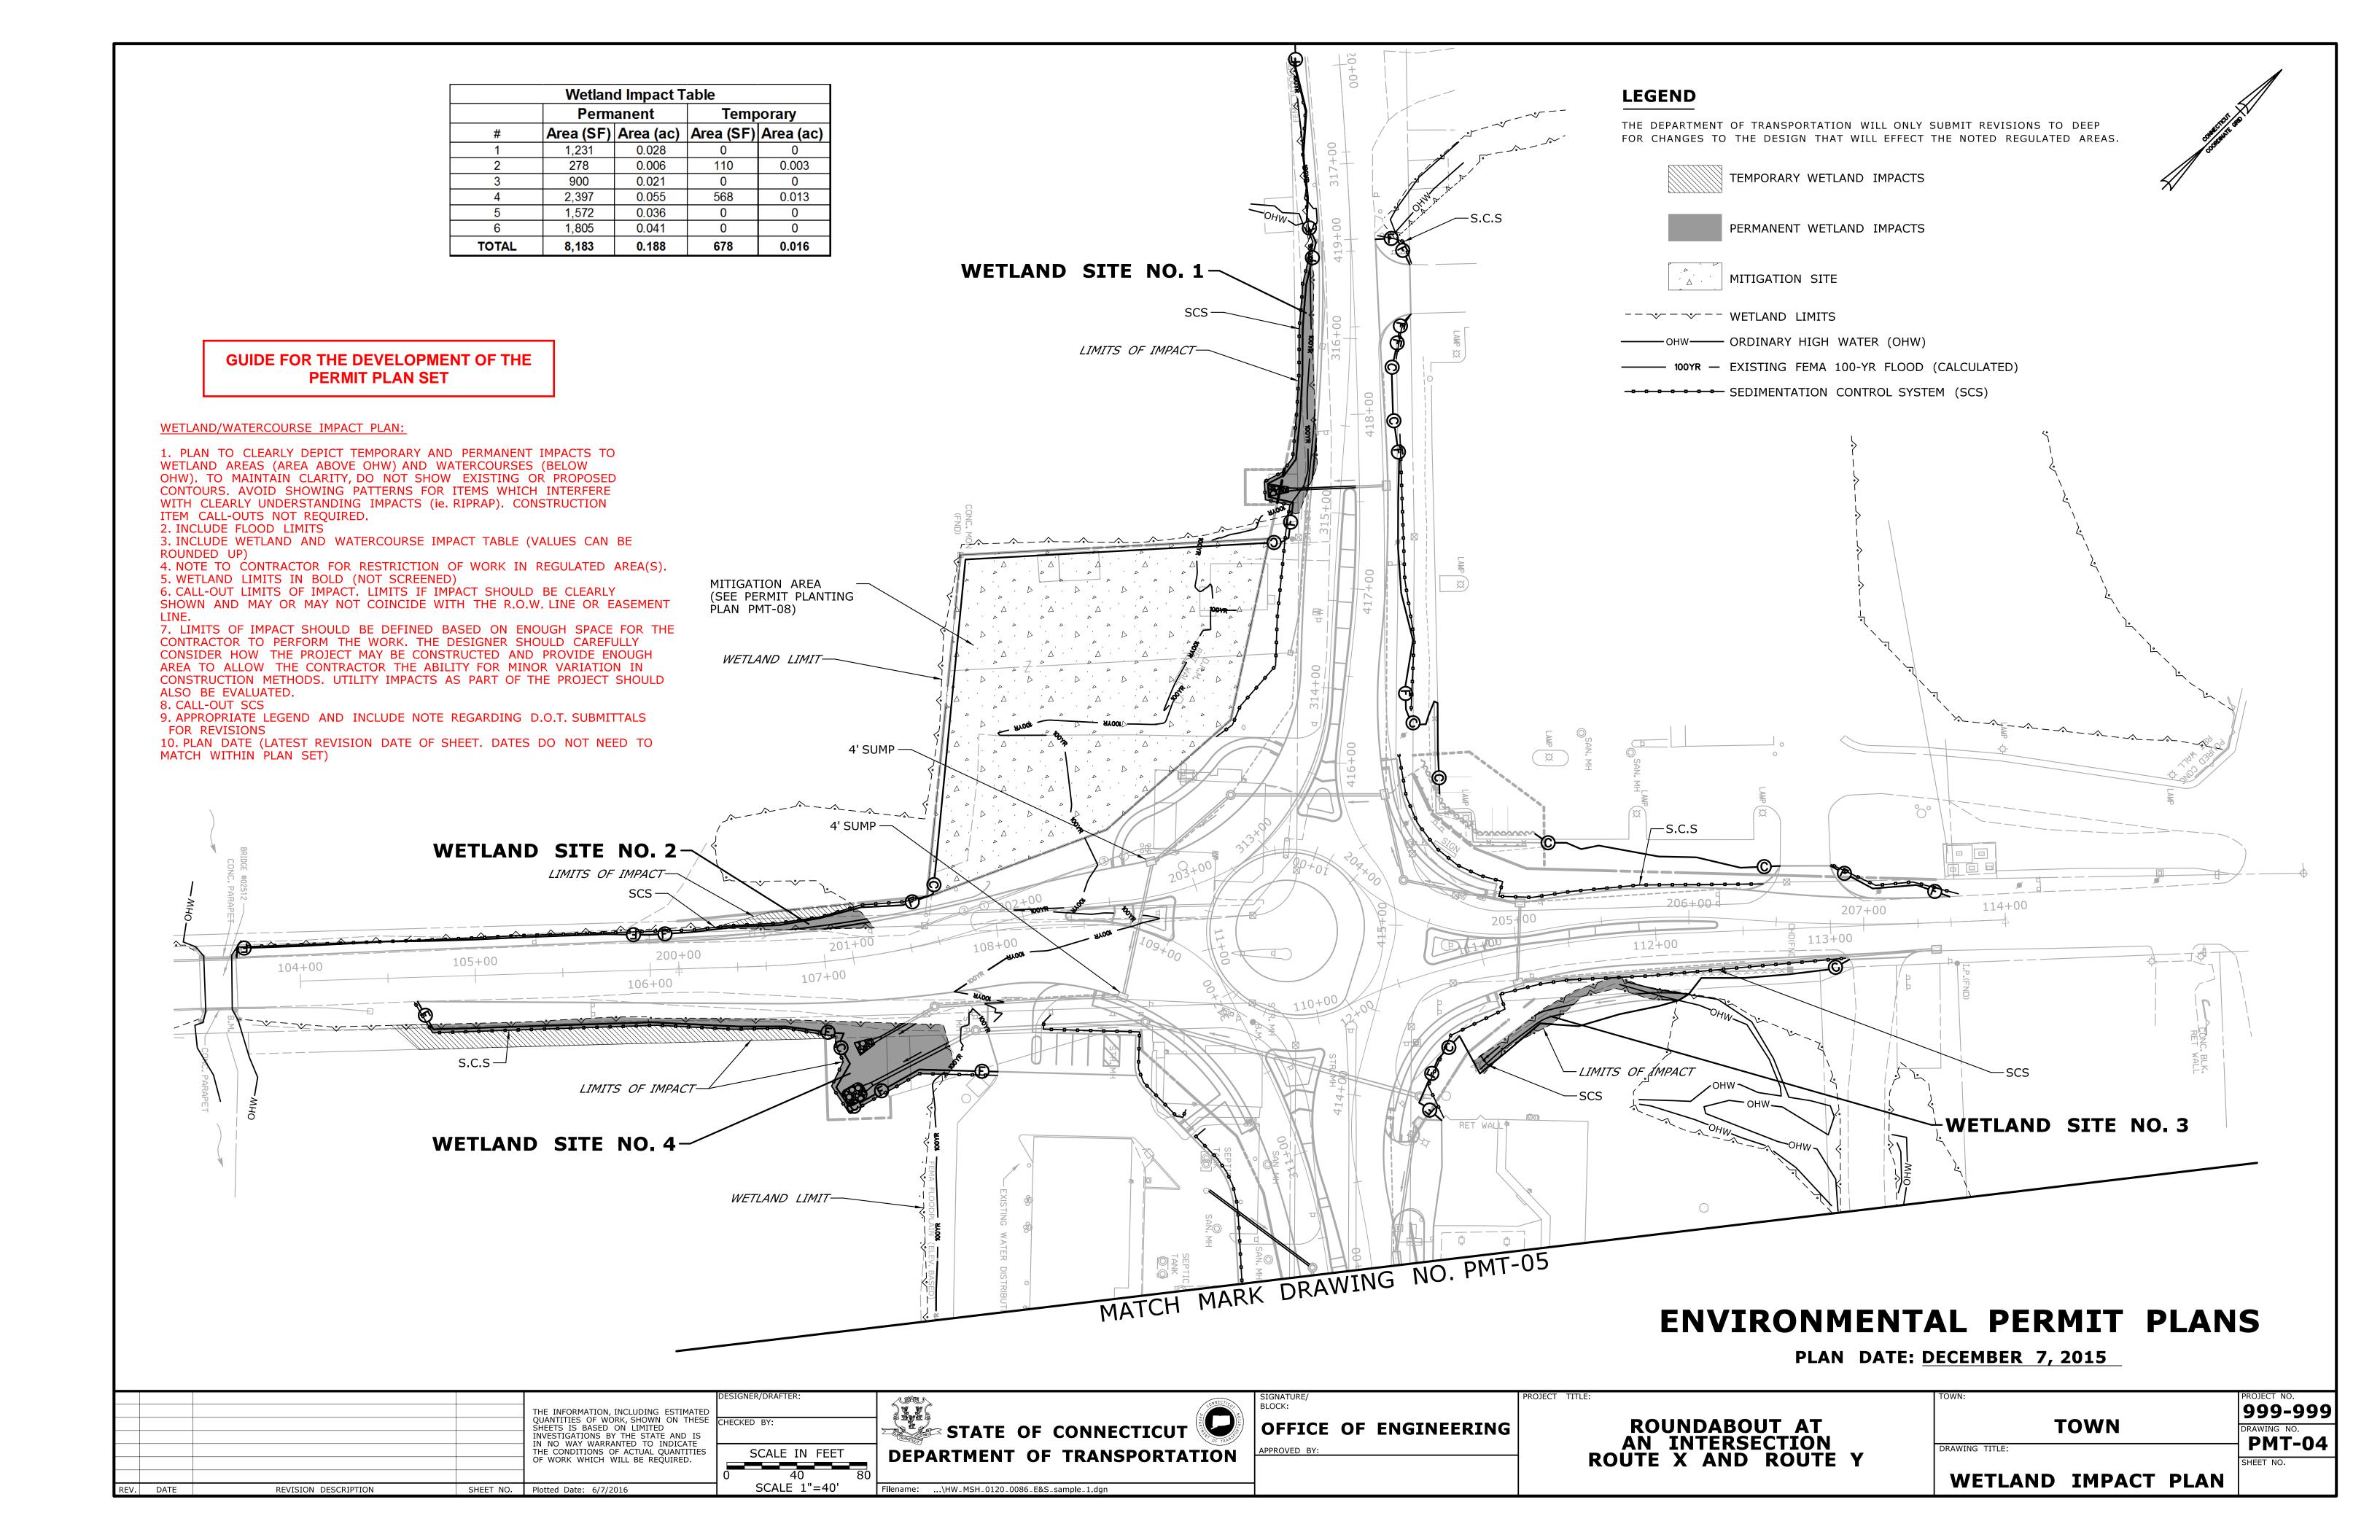


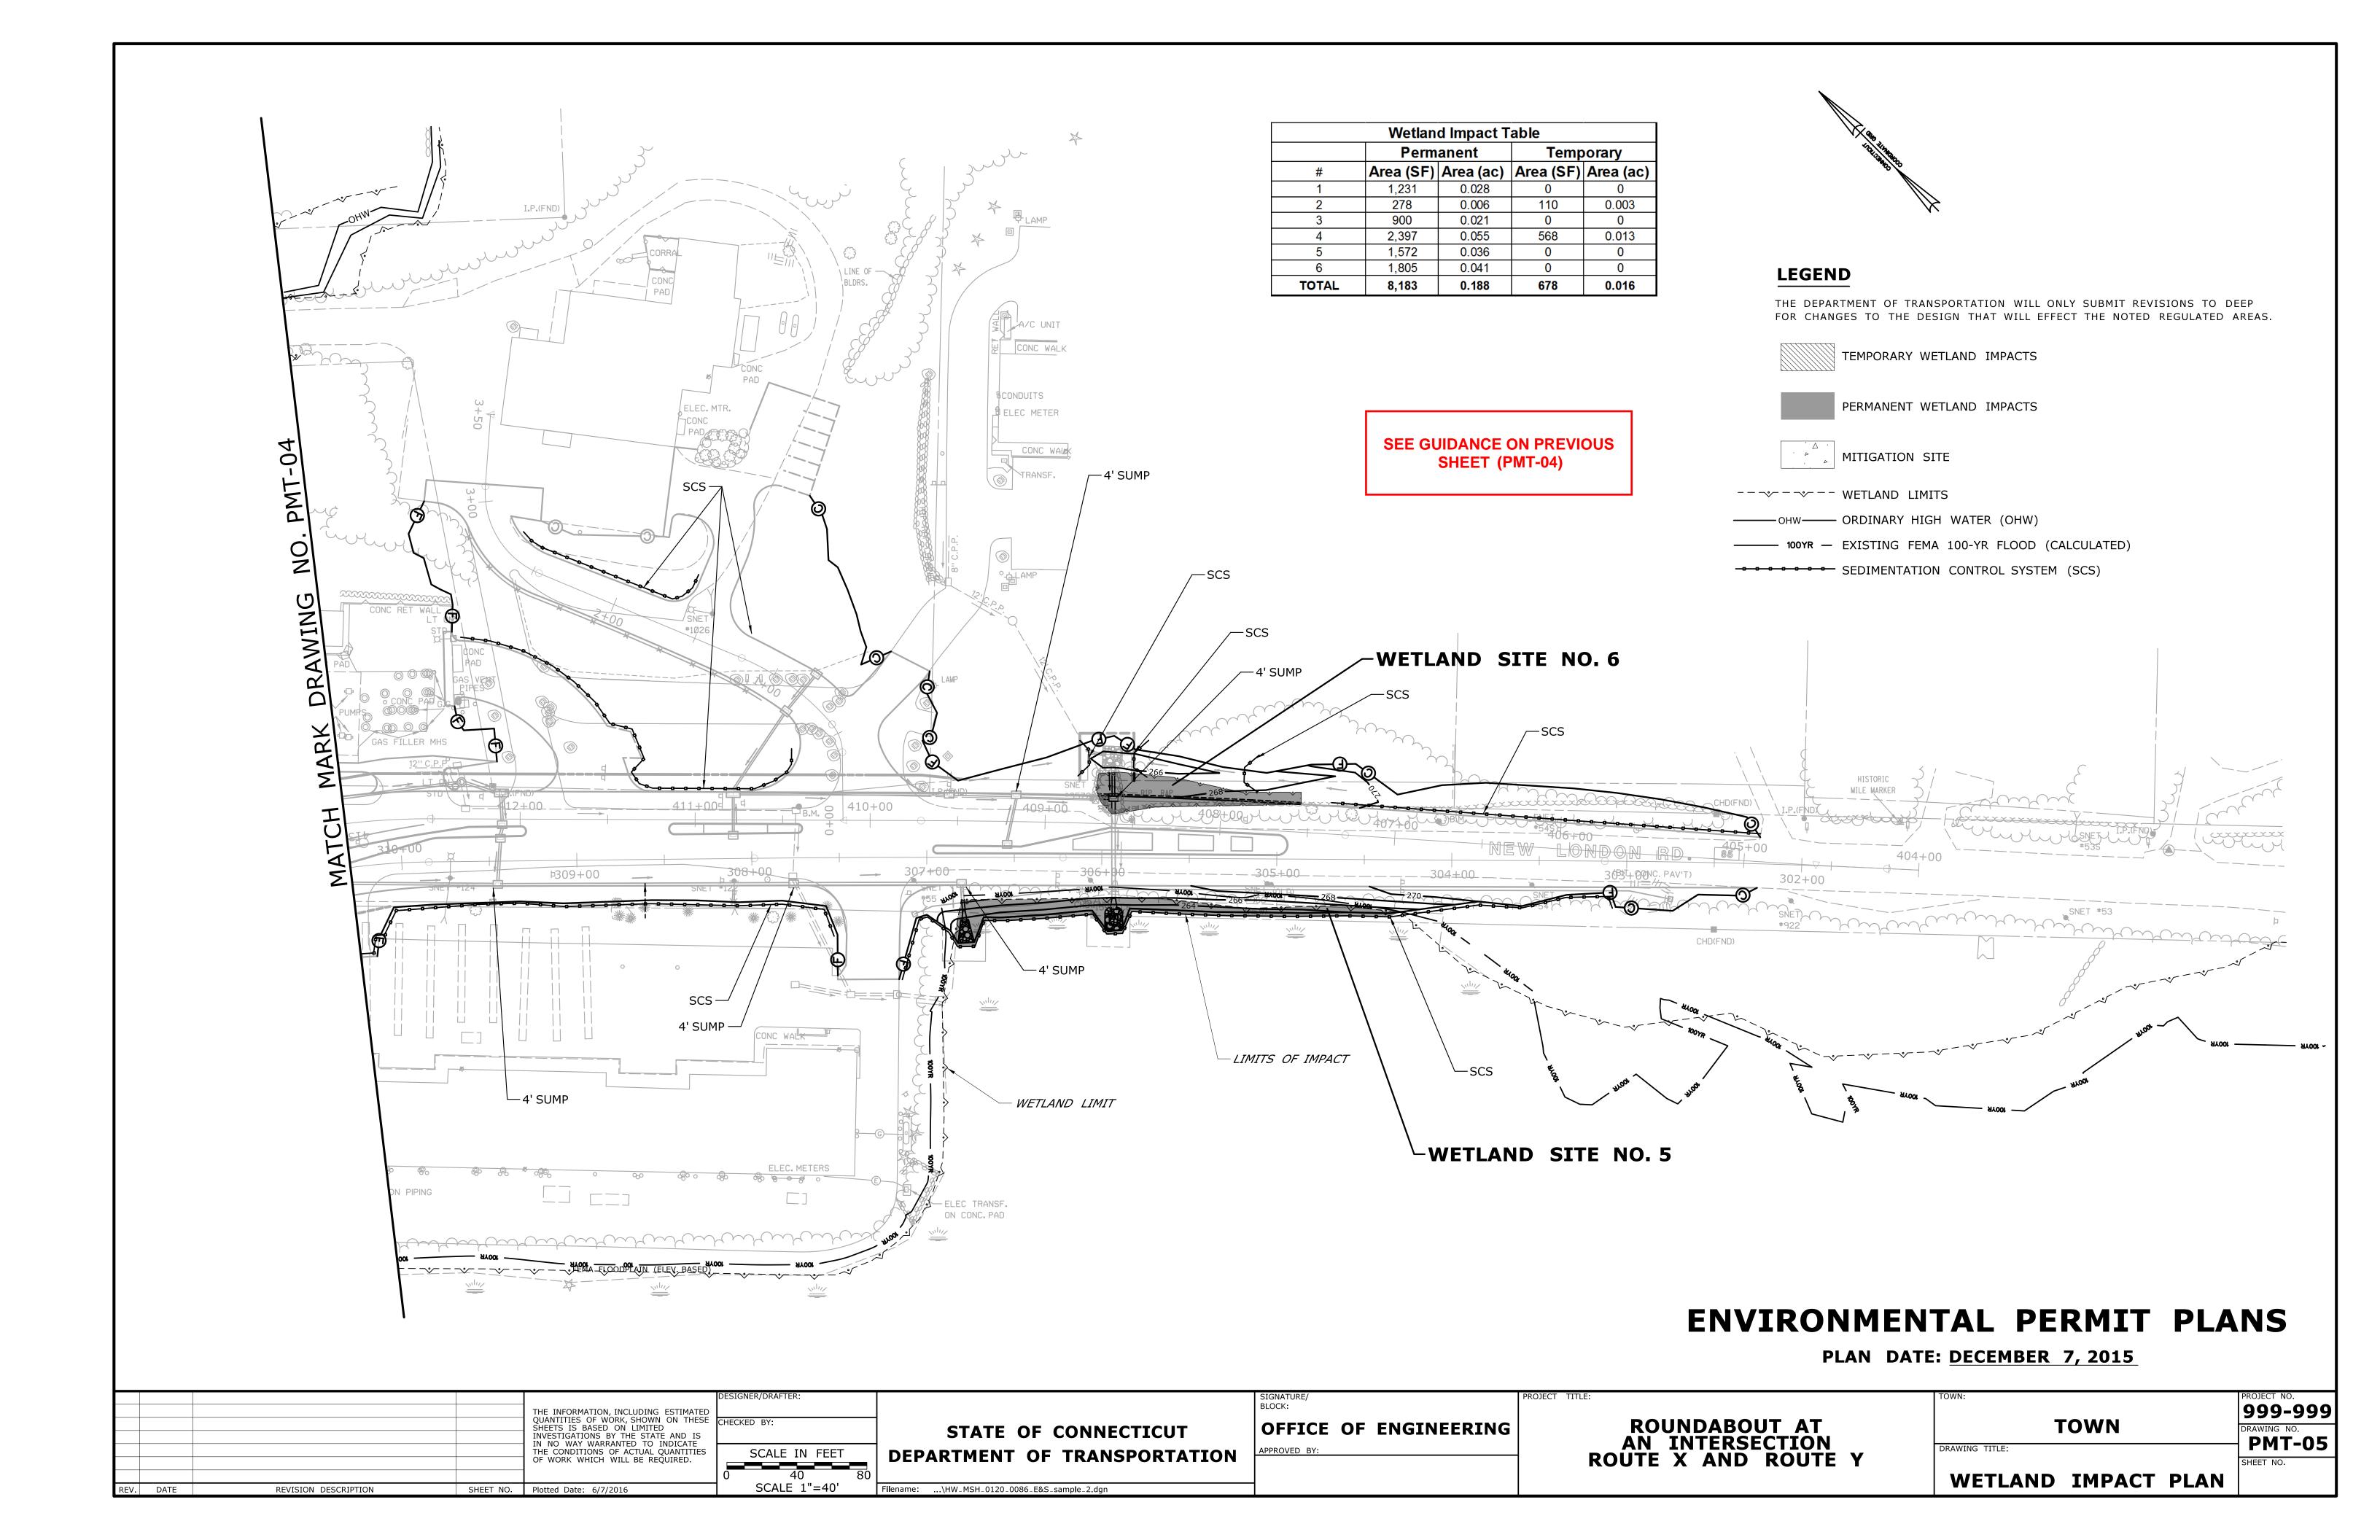

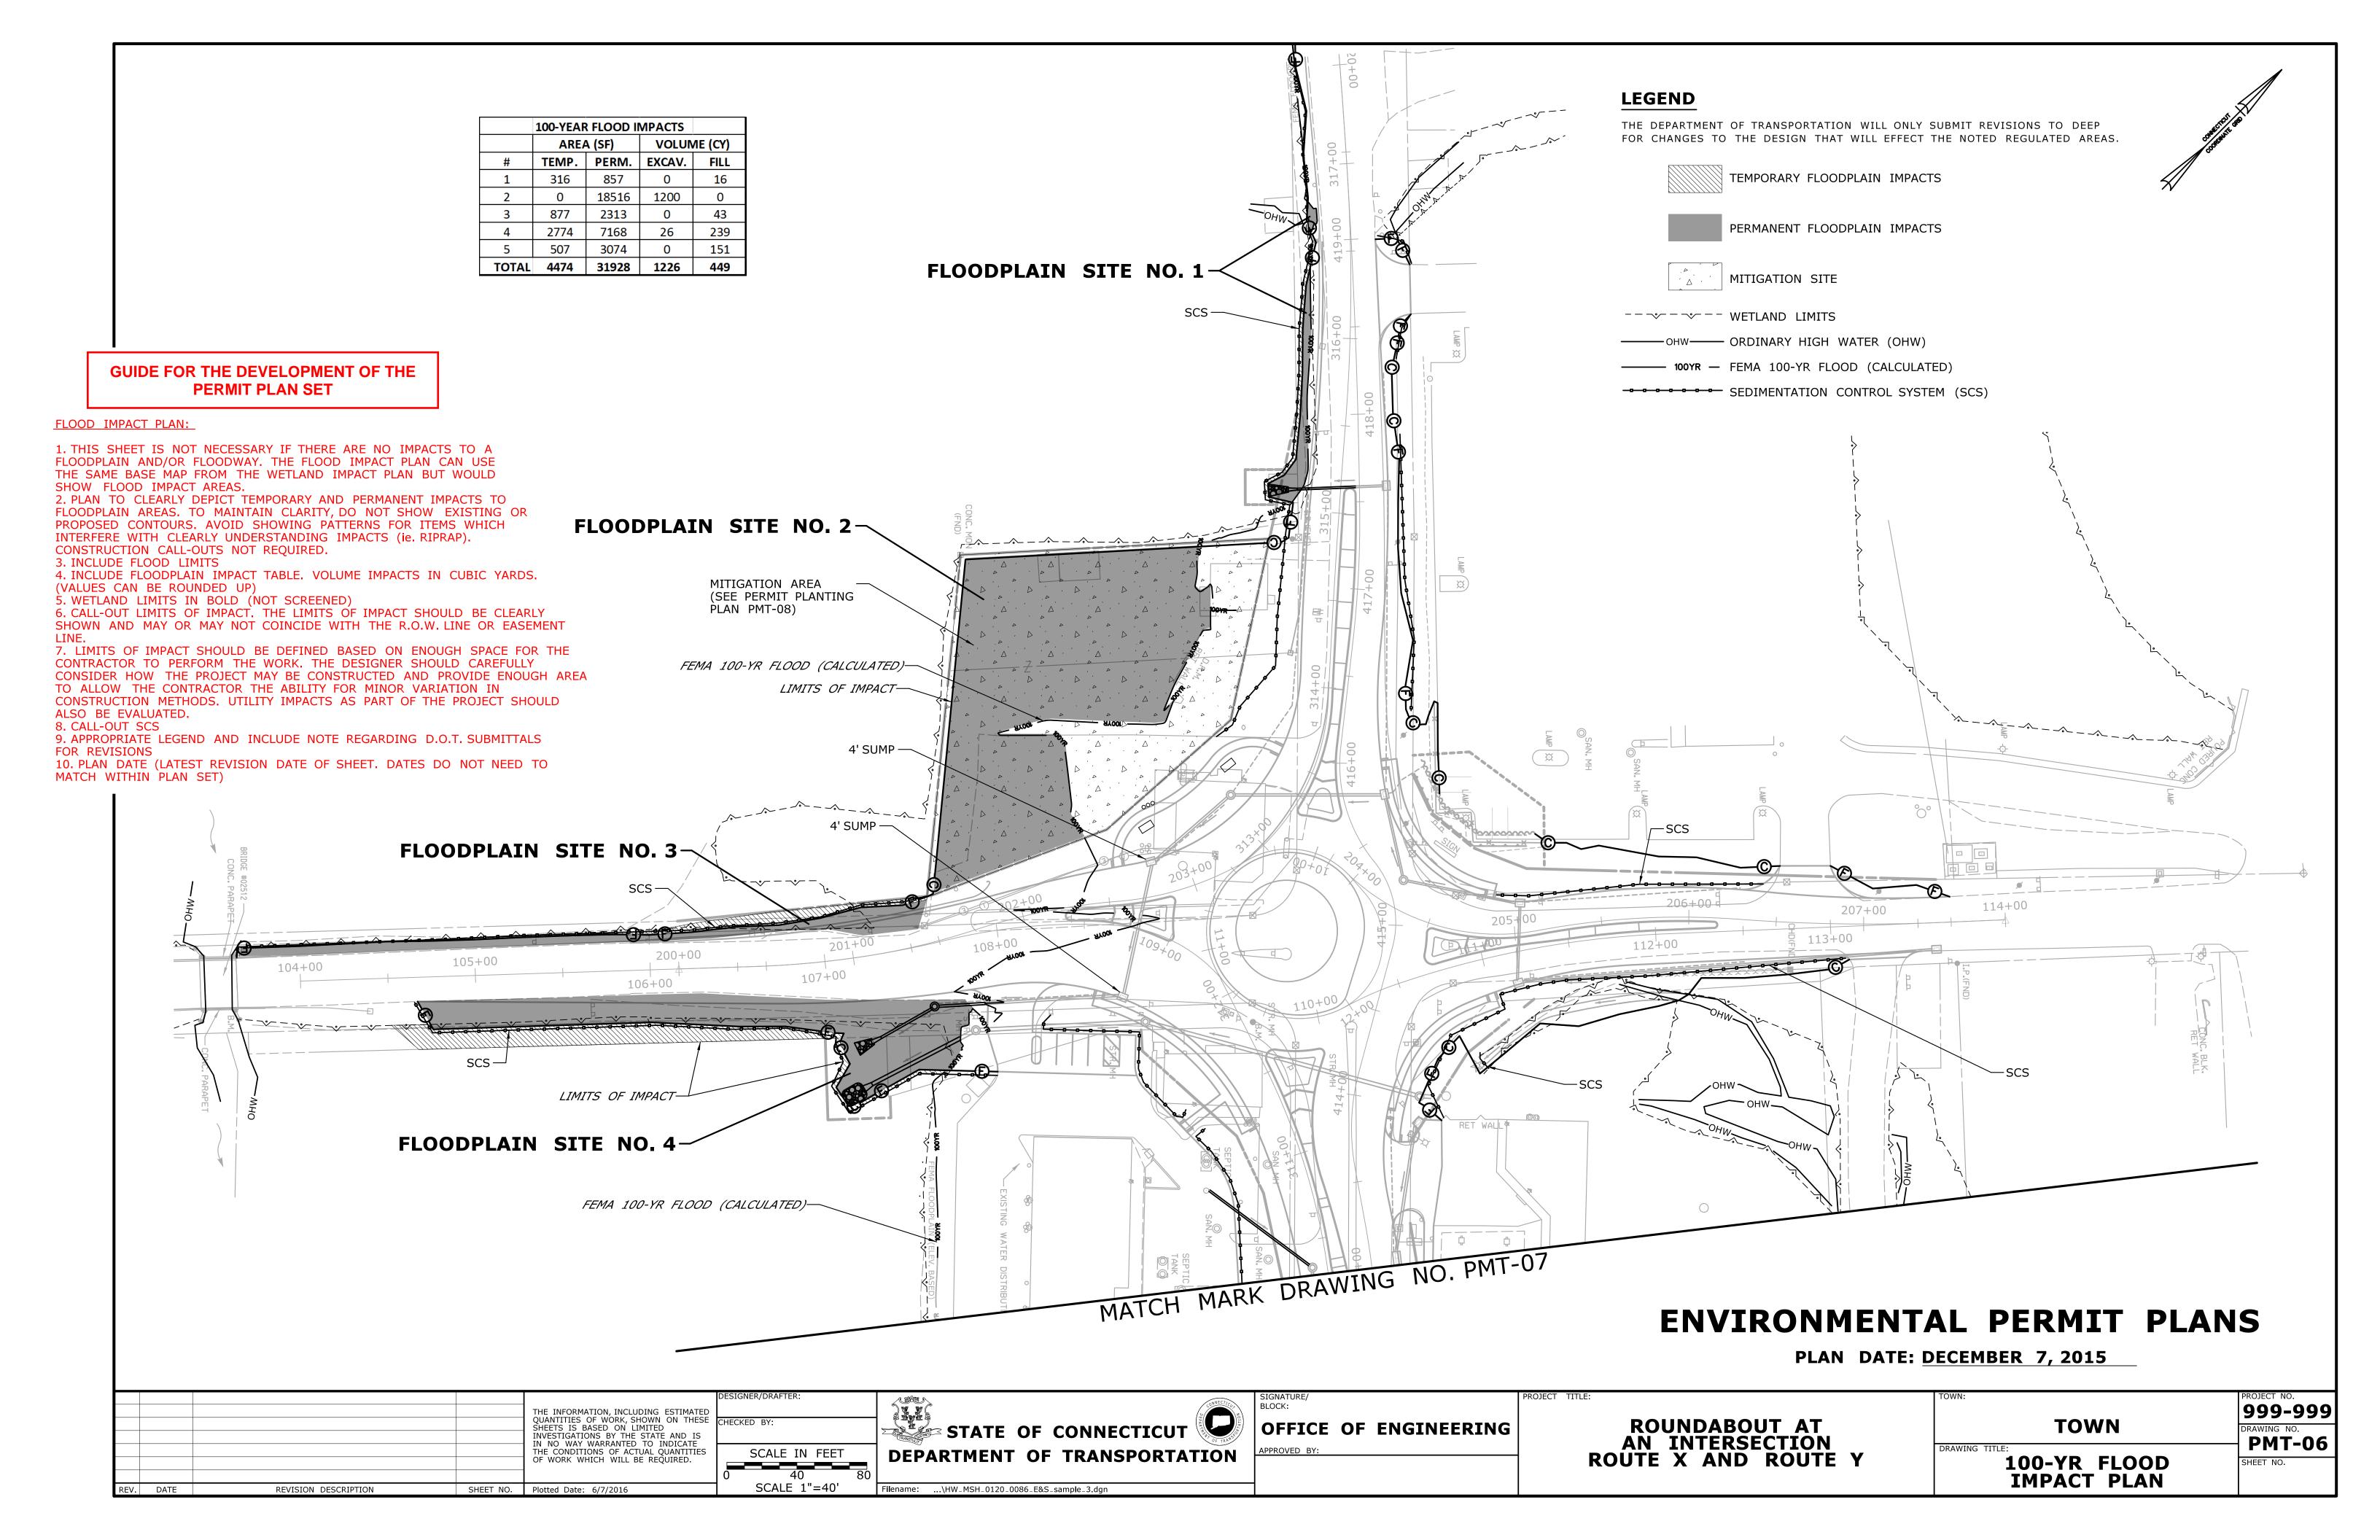

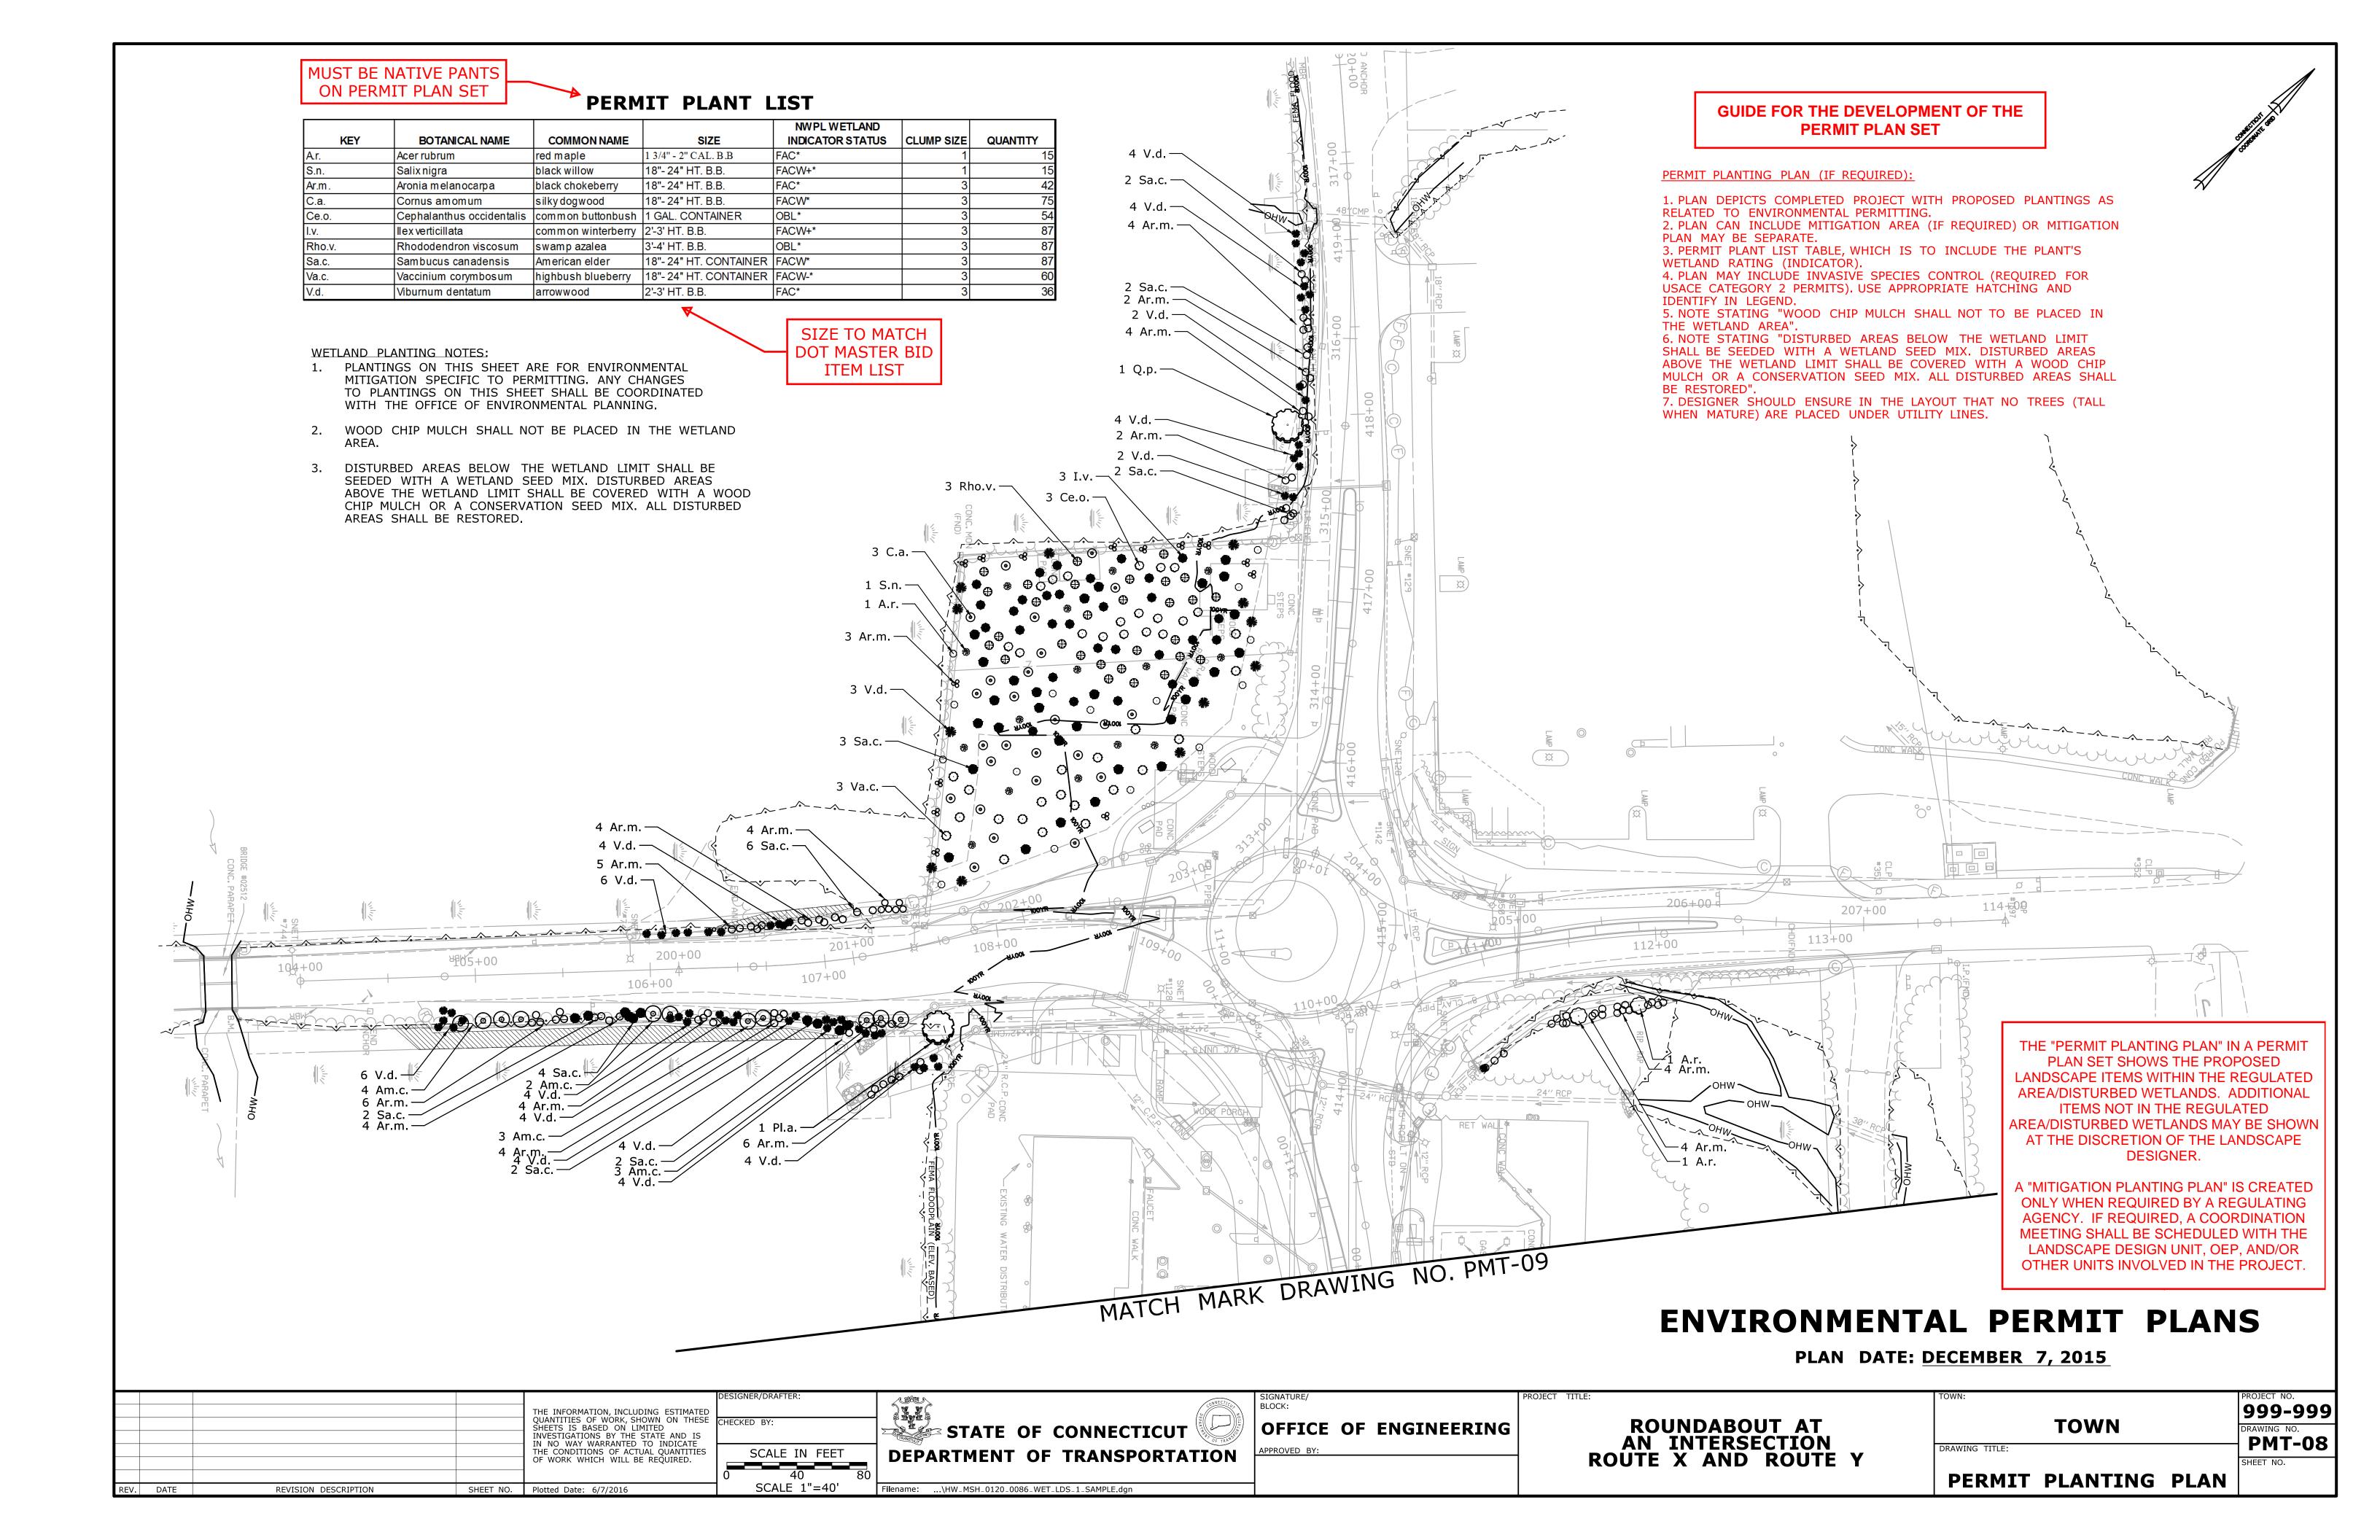


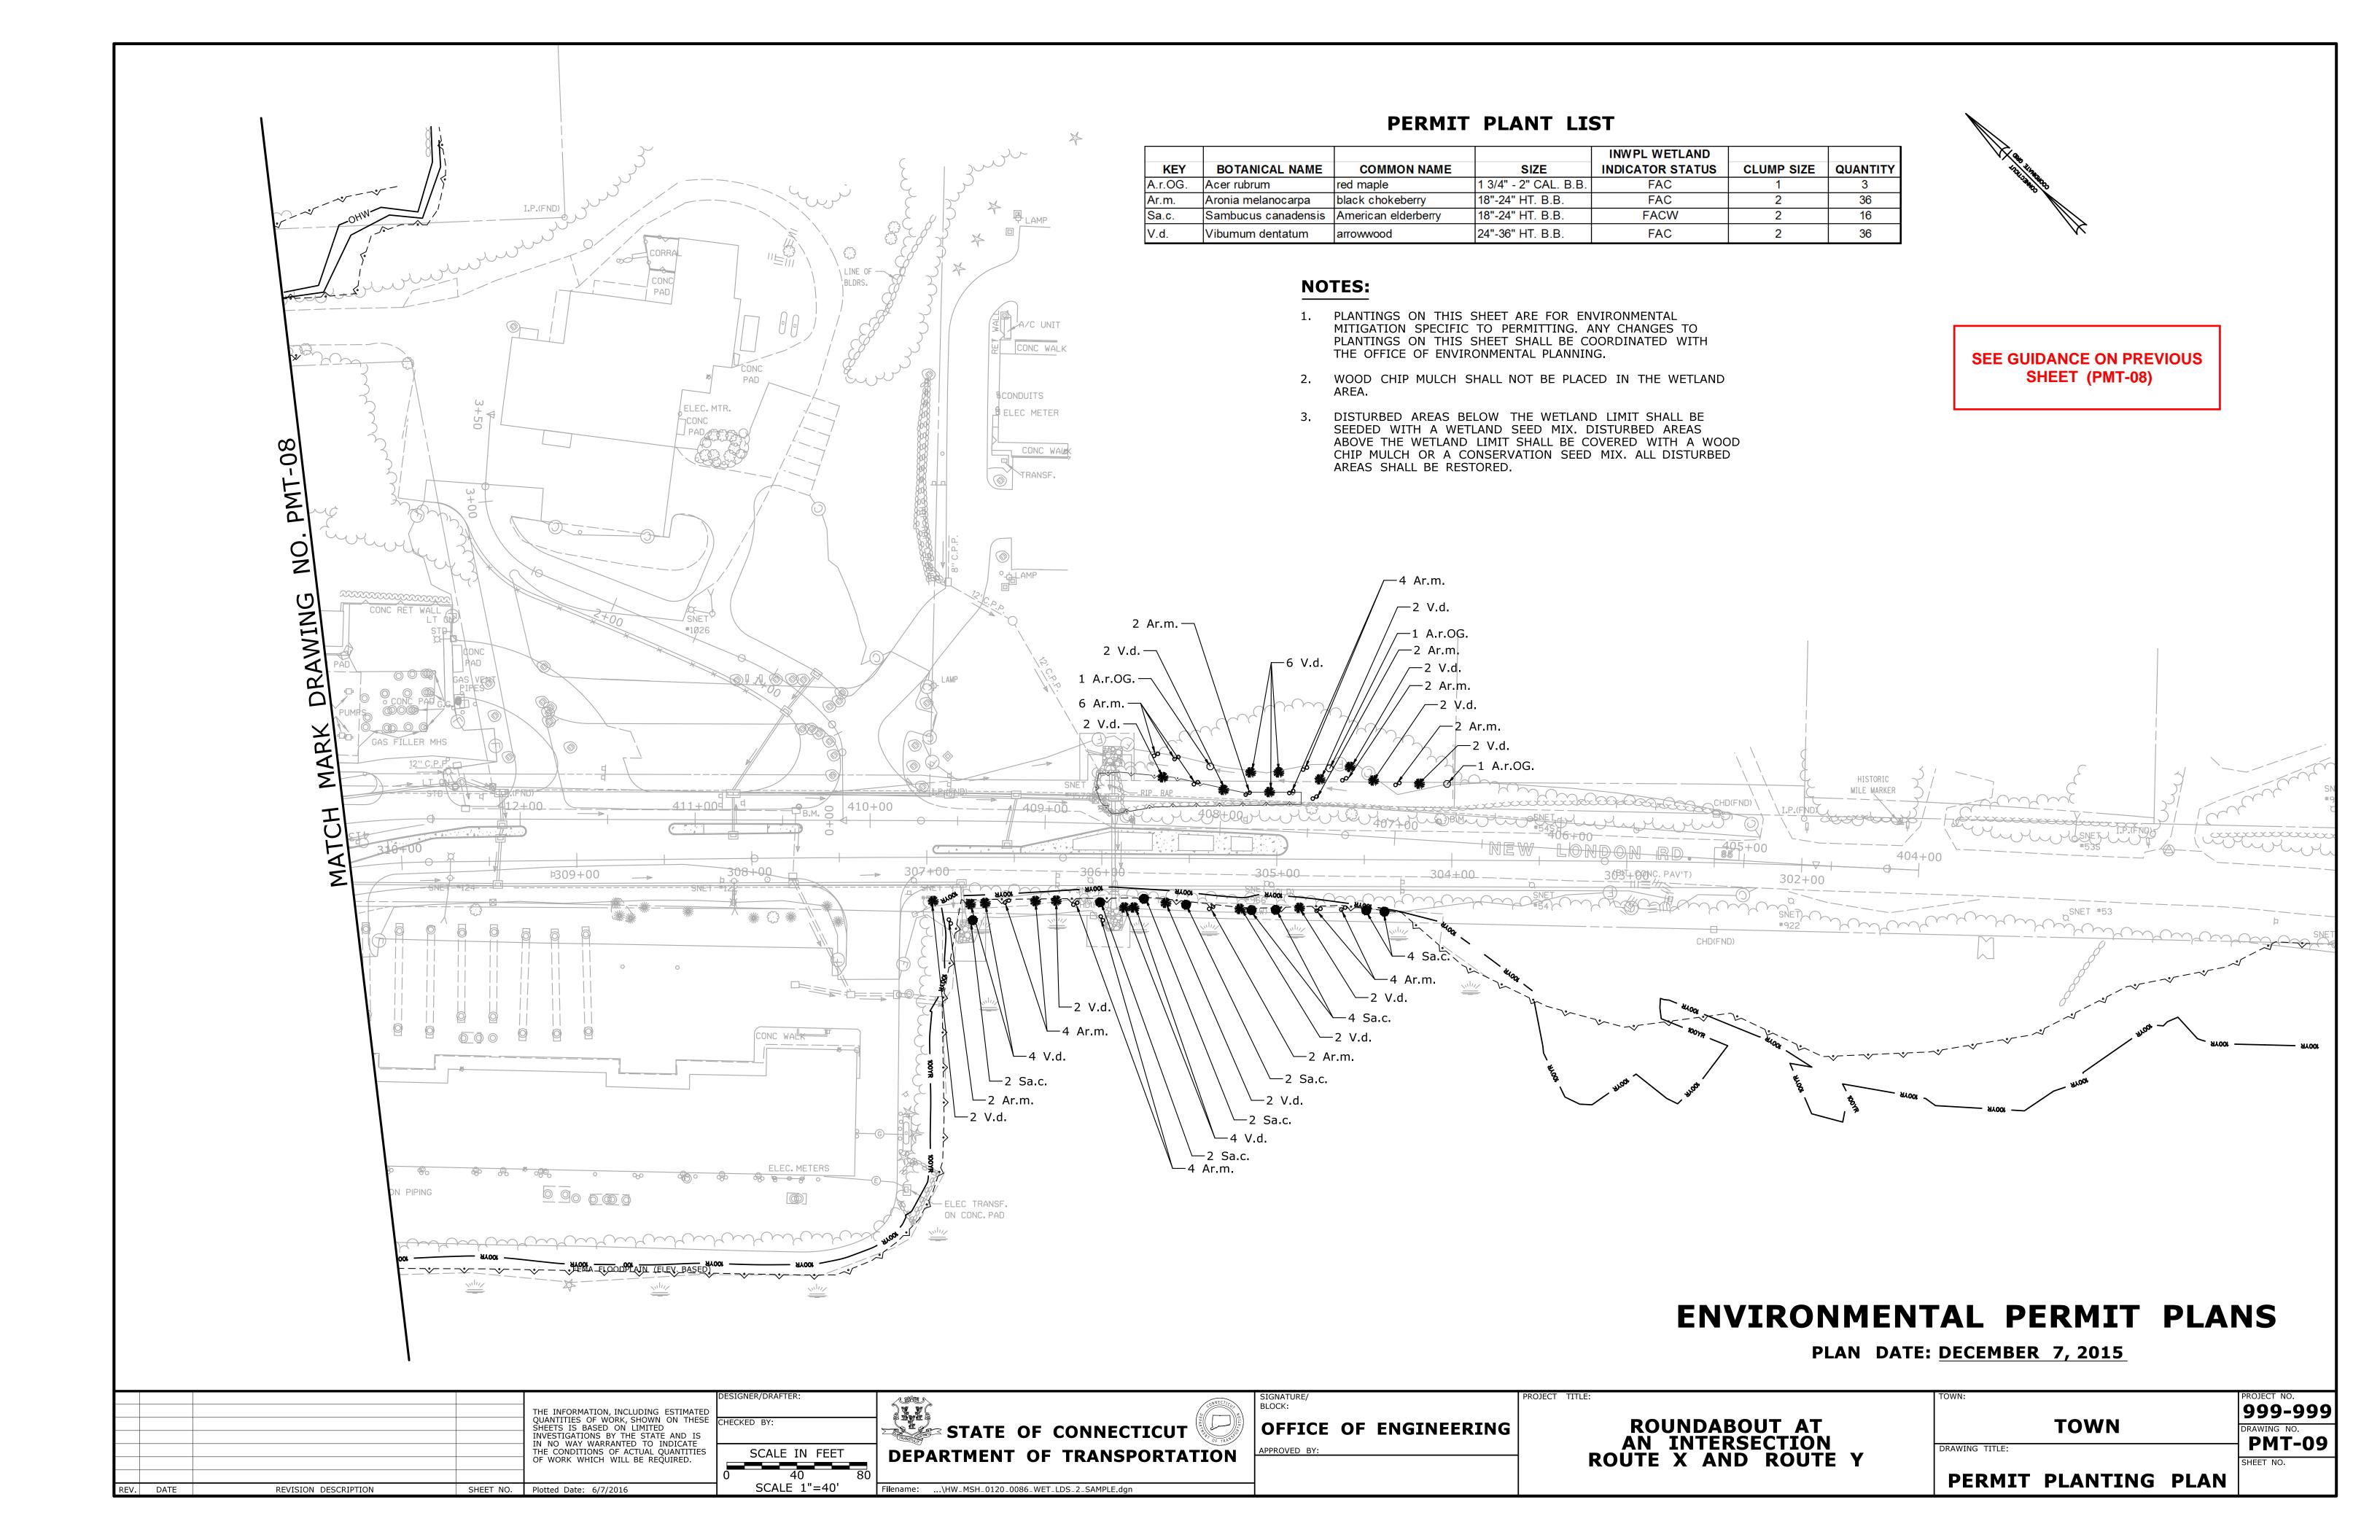

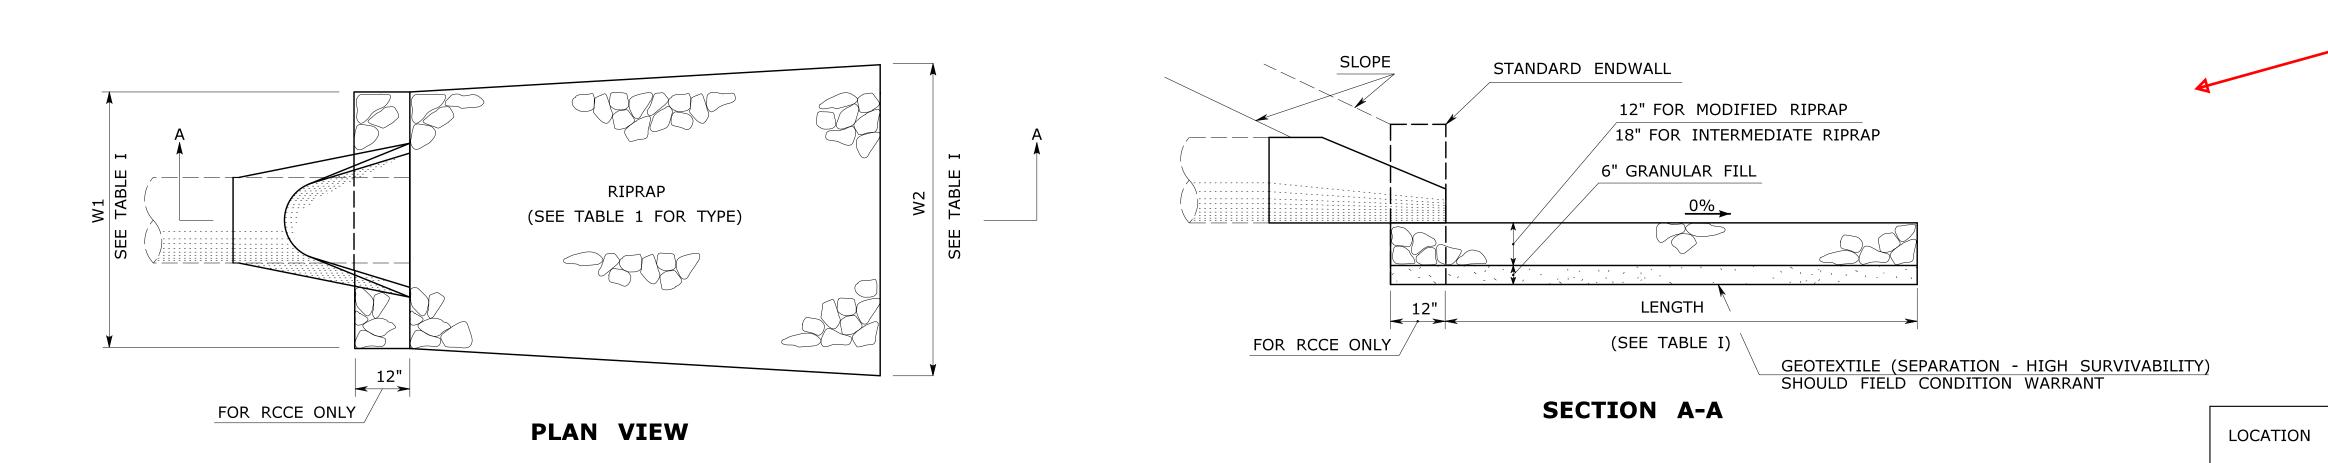

RIPRAP APRON

SEE TABLE 1 FOR LOCATIONS AND DIMENSIONS

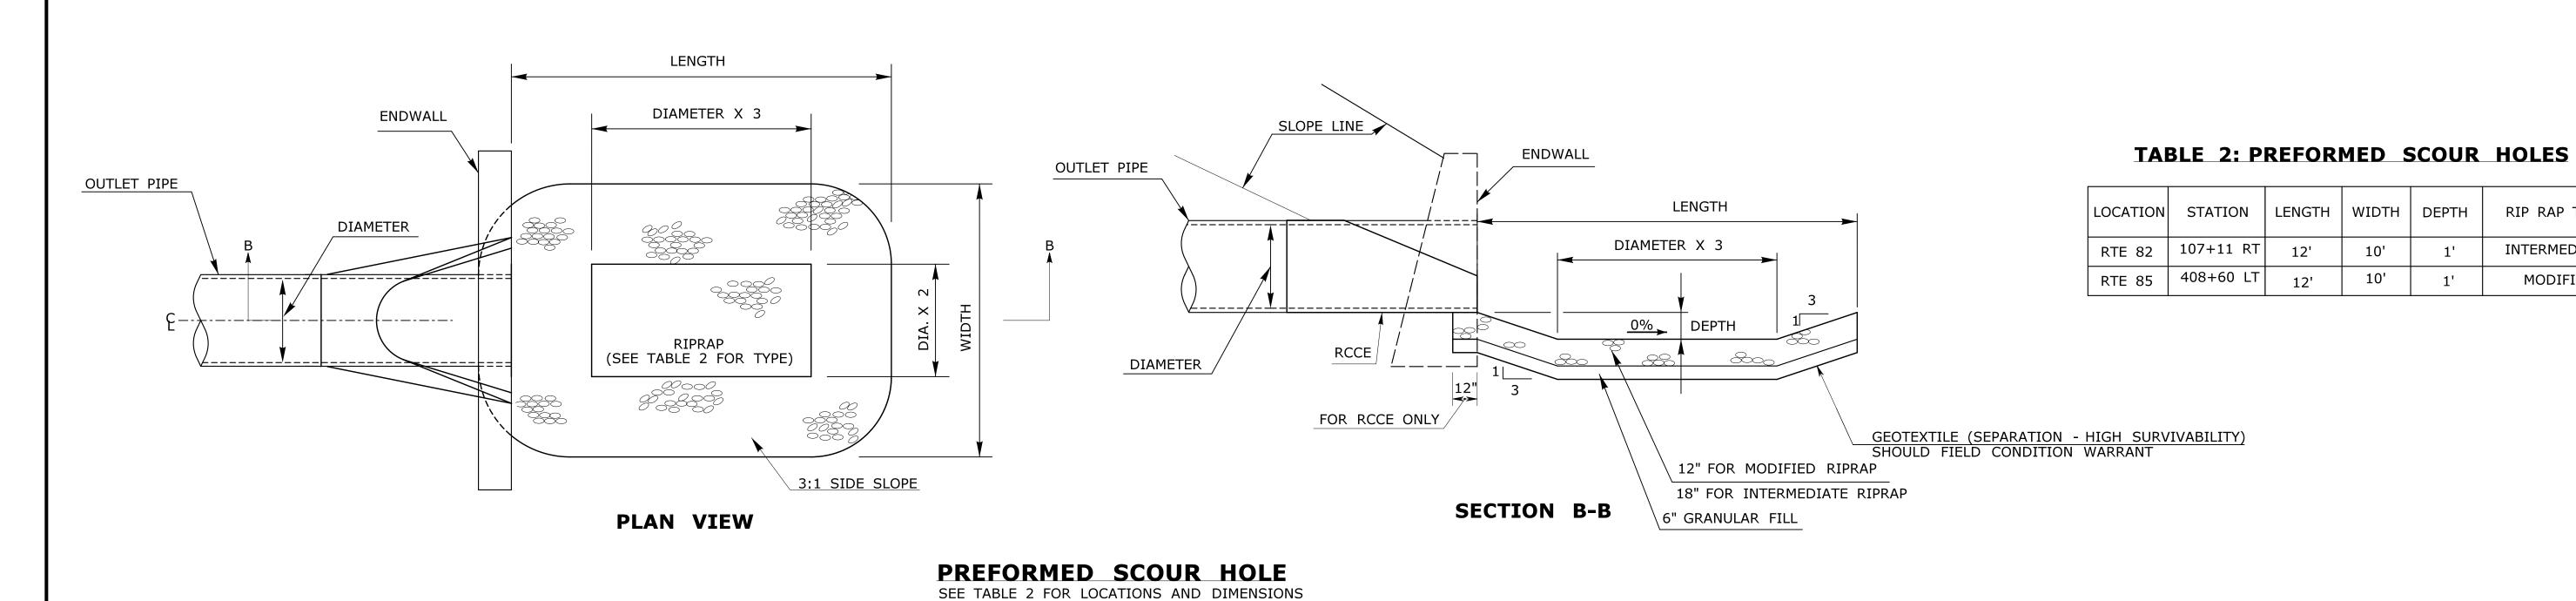

ENVIRONMENTAL PERMIT PLANS

PLAN DATE: DECEMBER 7, 2015

DETAILS TO BE

SHOWN ARE FOR

WORK ASSOCIATED

WITH THE

REGULATED AREAS

TABLE 1: RIPRAP APRONS

LENGTH

10'

12'

10'

STATION

107+11 RT

409+48 LT

417+59 LT

RTE 82

RTE 85

RTE 85

WIDTH

W1 W2

3.75' 7.75'

4.5' 9.3'

10'

10'

RIP RAP TYPE

MODIFIED

MODIFIED

MODIFIED

RIP RAP TYPE

INTERMEDIATE

MODIFIED

THE INFORMATION, INCLUDING ESTIMAT QUANTITIES OF WORK, SHOWN ON THE	DESIGNER/DRAFTER: D E CHECKED BY:	CONNECTICAL	BLOCK:	PROJECT TITLE:	TOWN:	PROJECT NO. 999-999
SHEETS IS BASED ON LIMITED INVESTIGATIONS BY THE STATE AND IS IN NO WAY WARRANTED TO INDICATE THE CONDITIONS OF ACTUAL QUANTITIE	5	TRAISTUT OF TRAIS	OFFICE OF ENGINEERING APPROVED BY:	ROUNDABOUT AT AN INTERSECTION	TOWN DRAWING TITLE:	PMT-10
OF WORK WHICH WILL BE REQUIRED.	NOT TO SCALE	DEPARTMENT OF TRANSPORTATION		ROUTE X AND ROUTE Y	DETAIL SHEET	SHEET NO.
REV. HBAMBS_sheet022 (riprap).dgn REVISION DESCRIPTION SHEET NO. Plotted Date: 6/7/2016		Filename:\permit riprap details.dgn			DETAIL SHEET	