Robinson+Cole

KENNETH C. BALDWIN

280 Trumbull Street Hartford, CT 06103-3597 Main (860) 275-8200 Fax (860) 275-8299 kbaldwin@rc.com Direct (860) 275-8345

Also admitted in Massachusetts

December 1, 2017

Melanie A. Bachman, Esq. Executive Director/ Staff Attorney Connecticut Siting Council 10 Franklin Square New Britain, CT 06051

Re:

Docket No. 477 – Application Of Cellco Partnership d/b/a Verizon Wireless For A Certificate Of Environmental Compatibility And Public Need For The Construction, Maintenance And Operation Of A Wireless Telecommunications Facility At 46 Cemetery Road, Canterbury, Connecticut

Dear Ms. Bachman:

Enclosed please find fifteen (15) copies of the project plans for the proposed Canterbury South facility. It was recently discovered that a complete set of these plans never made it into the Docket No. 477 Application submitted to the Siting Council on August 23, 2017. More specifically, Sheets C-4, C-5 and C-6 were missing from the plan set in the Application. I apologize for the any confusion this may have caused. We will have additional sets of these materials available at the December 21, 2017 hearing for members of the general public.

Sincerely,

Kenneth C. Baldwin

KCB/kmd Enclosure

17411526-v1



WIRELESS COMMUNICATIONS FACILITY

SITE NAME: CANTERBURY SOUTH CT

46 CEMETERY RD. CANTERBURY, CT 06331



SITE ADDR	ESS:	CANTERBURY, CT 06331		
		HOLOWATY NICHOLAS II 46 CEMETERY RD. CANTERBURY, CT 06331		
		09-2		
TOWER CO	ORDINATES:	41° 40' 21.46" N 72° 01' 59.57" W		
APPLICAN	Т:	CELLCO PARTNERSHIP d.b.a. VERIZON WIRELESS 99 EAST RIVER DR., 9TH FL. EAST HARTFORD, CT 06108		
VERIZON WIRELESS CONTACTS:		JOHN TIERNEY - CONSTRUCTION (860) 999-11 STEVE SCHADLER- SITE ACQ. (508) 887-0357		
LEGAL/REGULATORY COUNSEL:		KENNETH C. BALDWIN, ESQ. ROBINSON & COLE, LLP (860) 275-8345		
	DRAW	ING SCHEDULE		
SHEET NO.		SHEET DESCRIPTION		
- 4				

PROJECT SUMMARY

46 CEMETERY RD.

SITE NAME:

SITE ADDRESS:


CANTERBURY SOUTH CT

	DRAWING SCHEDULE
SHEET NO.	SHEET DESCRIPTION
T-1	TITLE SHEET
C-1	ABUTTERS MAP & PROPERTY OWNER LIST
C-2	SITE PLAN
C-3	ENLARGED SITE PLAN
C-4	COMPOUND PLAN, NORTH ELEVATION & ANTENNA PLAN
C-5	CONSTRUCTION DETAILS
C-6	EQUIPMENT PLATFORM, FENCE & MISC. DETAILS
C-7	EQUIPMENT PLATFORM FOUNDATION PLAN & SECTIONS

Cellco Partnership d/b/a Verizon Wireless



WIRELESS COMMUNICATIONS FACILITY 99 EAST RIVER DRIVE EAST HARTFORD, CT 06108

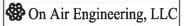

88 Foundry Pond Road Cold Spring, NY 10516 onair@optonline.net 201-456-4624



.06,17	REVIEW SET
29.17	REVISED PER ATTORNEY COMMENTS
01.17	REVISED PER COMMENTS
	01.17

DWMF

NEW BUILD MACRO

CANTERBURY SOUTH CT

PROJECT INFORMATION:

46 CEMETERY RD. CANTERBURY, CT 06331

DRAWING TITLE:

TITLE SHEET


T-1

PROJECT DESCRIPTION

INSTALLATION OF A 160 FT, MONOPOLE/TOWER AND FENCED—IN COMPOUND AT GRADE INSTALLATION OF OUTDOOR EQUIPMENT CABINETS AND A DIESEL FUELED GENERATOR LOCATED ON A NEW 16'-0"x9'-4" PRE-FABRICATED EQUIPMENT PLATFORM WITHIN THE COMPOUND INSTALLATION OF (9) PANEL ANTENNAS AND ASSOCIATED DEVICES ON THE MONOPOLE

INSTALLATION OF CABLING FROM EQUIP: CABINETS TO ANTENNAS

ELECTRICAL, TELEPHONE & GROUNDING CONNECTIONS TO EXISTING UTILITIES

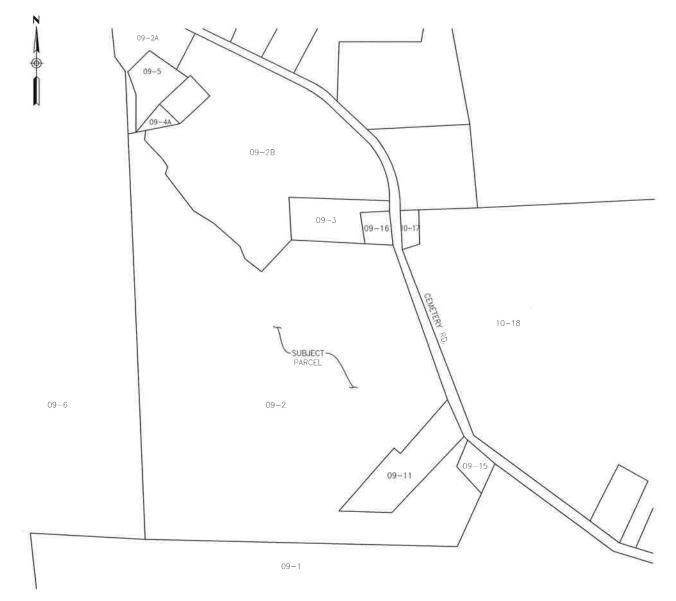

ABUTTERS MAP
C-1 Scale: 1"=300"

ABUTTERS LIST FROM PARCEL 9-02			
PARCEL#	OWNER NAME	OWNER MAILING ADDRESS	PROPERTY ADDRESS
09-2A	SARGENT, CARL W	108 CEMETERY RD, CANTERBURY, CT 06331	108 CEMETERY RD.
09-5	JACKSON CYNTHIA L	106 CEMETERY RD, CANTERBURY, CT 06331	106 CEMETERY RD.
09-4A	THOMA BARBARA M ETAL	144 CEMETERY RD, CANTERBURY, CT 06331	104 CEMETERY RD.
09-2B	THOMA BARBARA, LINDA, TIMOTHY, JAMES	144 CEMETERY RD, CANTERBURY, CT 06331	CEMETERY RD.
09-3	CANTERBURY CEMETERY ASSOC INC; DEAN CEMETERY	PO BOX 1, CANTERBURY, CT 06331	CEMETERY RD.
09-16	WESTMINSTER CONGREGATIONAL CHURCH; NEW SMITH CEMETERY	395 WESTMINSTER RD., CANTERBURY, CT 06331	CEMETERY RD.
10-17	CANTERBURY TOWN OF; OLD SMITH CEMETERY	1 MUNICIPAL DRIVE, CANTERBURY, CT 06331	CEMETERY RD.
10-18	THORNTON, JEREMY	75 CEMETERY RD, CANTERBURY, CT 06331	45 CEMETERY RD.
09-11	RILEY GEORGE JR & DEBORAH ROSE	40 CEMETERY RD, CANTERBURY, CT 06331	40 CEMETERY RD.
09-15	CANTERBURY TOWN OF	PO BOX 27, CANTERBURY, CT 06331	CEMETERY RD.
09-1	RACY ANN S	395 WATER ST, CANTERBURY, CT 06331	395 WATER ST
09-6	THOMA BARBARA, ET AL	148 CEMETERY RD, CANTERBURY, CT 06331	148 CEMETERY RD.

NOTES TO ABUTTERS MAP & OWNERS LIST:

1. ALL INFORMATION TAKEN FROM THE "NECCOG" 'GIS' WEBSITE FOR THE TOWN OF CANTERBURY, DECEMBER 2016 AND MODIFIED AUGUST 2017 BASED ON UNDERLYING PARCEL SURVEY.

Cellco Partnership d/b/a Verizon Wireless



WIRELESS COMMUNICATIONS FACILITY 99 EAST RIVER DRIVE EAST HARTFORD, CT 06108



LICENSURE



NO,:	DATE:	SUBMISSIONS
0	06,06,17	REVIEW SET
1	06,29,17	REVISED PER ATTORNEY COMMENTS
2	08,01,17	REVISED PER COMMENTS
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 $\mathbf{D}\mathbf{W}$ MF

PROJECT TYPE:

NEW BUILD MACRO

SITE NAME:

CANTERBURY SOUTH CT


PROJECT INFORMATION:

46 CEMETERY RD. CANTERBURY, CT 06331

DRAWING TITLE:

ABUTTERS MAP & PROPERTY OWNER LIST


SHEET NUMBER:

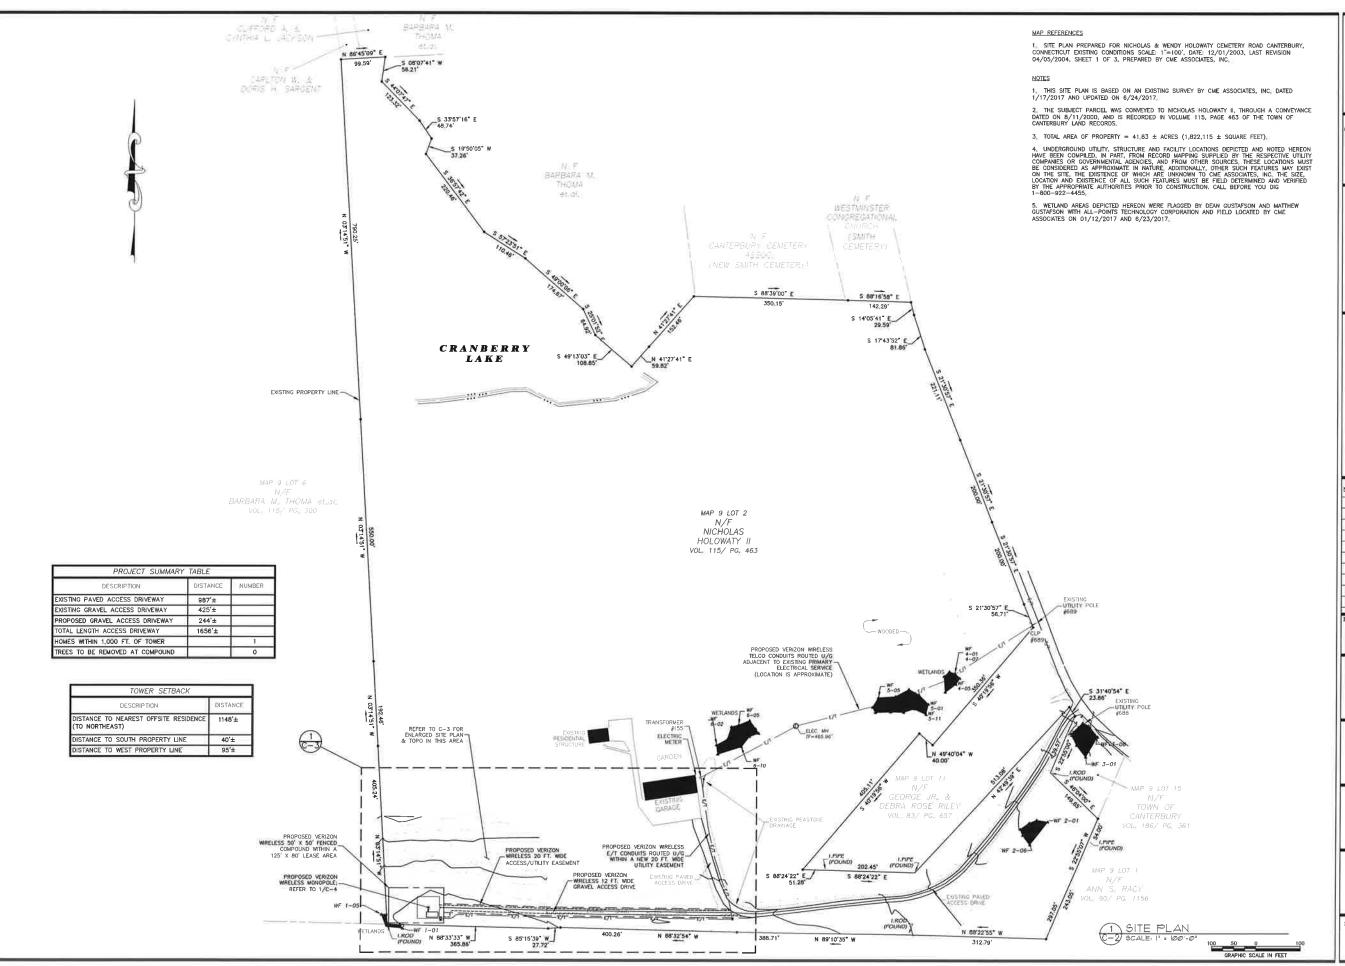

Cellco Partnership d/b/a Verizon Wireless



WIRELESS COMMUNICATIONS FACILITY
99 EAST RIVER DRIVE
EAST HARTFORD, CT 06108

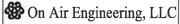

88 Foundry Pond Road Cold Spring, NY 10516 onair@optonline.net 201-456-4624



S3 Willbur Cross Way, Marssfeld, CT 06268 S33 East River Drive, East Hardord, CT 0610

688-291-3227 | www.ameangineering.com

LICENSURE



DAVID WEINPAHL, P.E.

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NEW BUILD MACRO

DW

SITE NAME

CANTERBURY SOUTH CT

PROJECT INFORMATION:


46 CEMETERY RD. CANTERBURY, CT 06331

DRAWING TITI

SITE PLAN

SHEET NUMBER

C-2

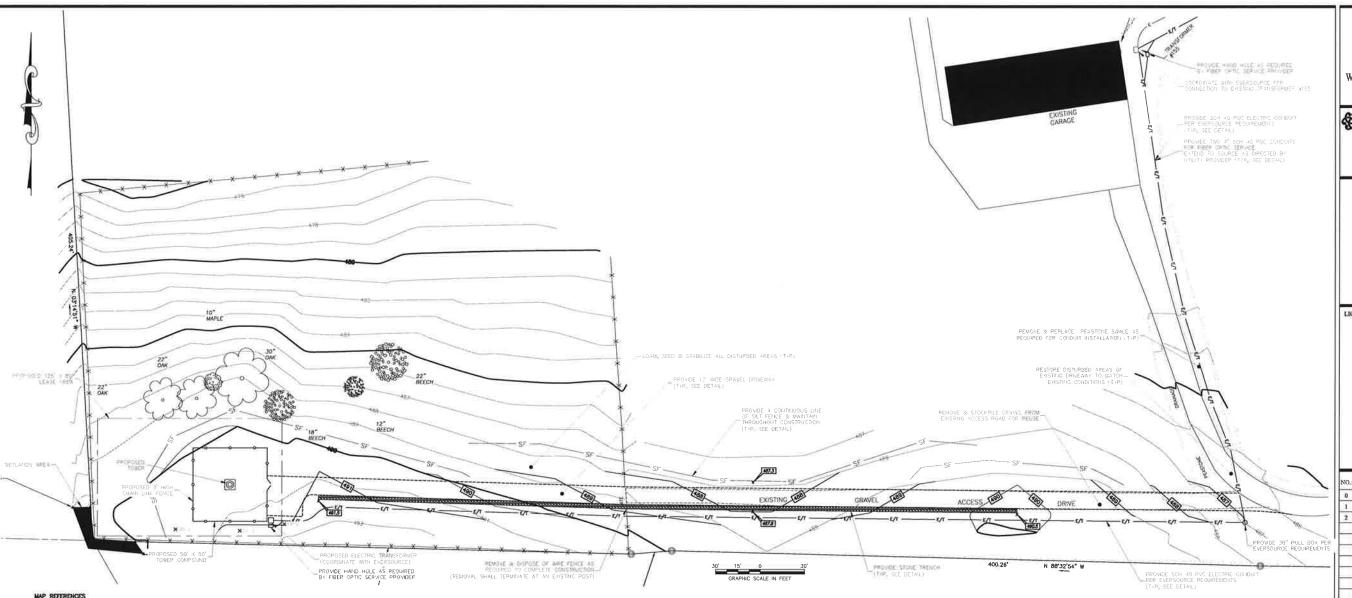

1. SITE PLAN PREPARED FOR NICHOLAS & WENDY HOLOWATY CEMETERY ROAD CANTERBURY, CONNECTICUT EXISTING CONDITIONS SCALE: 1"-100', DATE: 12/01/2003, LAST REVISION 04/05/2004, SHEET 1 OF 3, PREPARED BY CME ASSOCIATES, INC.

NOTES

1. THIS SITE PLAN IS BASED ON AN EXISTING SURVEY BY CME ASSOCIATES, INC. DATED 1/17/2017 AND UPDATED ON $6/24/2017_{\circ}$

 2_{\star} THE SUBJECT PARCEL WAS CONVEYED TO NICHOLAS HOLOWATY II, THROUGH A CONVEYANCE DATED ON 8/11/2000, AND IS RECORDED IN VOLUME 115, PAGE 463 OF THE TOWN OF CANTERBURY LAND RECORDS.

- 3. TOTAL AREA OF PROPERTY = 41.83 \pm ACRES (1,822,115 \pm SQUARE FEET).
- 4. SITE IS LOCATED IN RD (RURAL DISTRICT) ZONE.

5. UNDERGROUND UTILITY, STRUCTURE AND FACILITY LOCATIONS DEPICTED AND NOTED HEREON HAVE BEEN COMPILED, IN PART, FROM RECORD MAPPING SUPPLIED BY THE RESPECTIVE UTILITY COMPANIES OR GOVERNMENTAL ACENCIES, AND FROM OTHER SOURCES. THESE LOCATIONS MUST BE CONSIDERED AS APPROXIMATE IN NATURE. ADDITIONALLY, OTHER SUCH FEATURES MAY EXIST ON THE SITE, THE EXISTENCE OF WHICH ARE UNKNOWN TO CME ASSOCIATES, INC. THE SIZE, LOCATION AND EXISTENCE OF ALL SUCH FEATURES MAY EXPLICATION AND EXISTENCE OF ALL SUCH FEATURES MUST BE FIELD DETERMINED AND VERIFIED BY THE APPROPRIATE AUTHORITIES PRIOR TO CONSTRUCTION, CALL BEFORE YOU DIG 1-800-922-4455.

- 6. HORIZONTAL DATUM BASED ON NAD 83
- 7, VERTICAL DATUM BASED ON THE NORTH AMERICAN VERTICAL DATUM OF 1988, (NAVD 88)
- 8. WETLAND AREAS DEPICTED HEREON WERE FLAGGED BY DEAN GUSTAFSON AND MATTHEW GUSTAFSON WITH ALL-POINTS TECHNOLOGY CORPORATION AND FIELD LOCATED BY CME ASSOCIATES ON 01/12/2017 AND 6/23/2017.

9. PURSUANT TO FEMA FLOOD INSURANCE RATE MAP, COMMUNITY PANEL 090183 0015A, THE PROPOSED TOWER LOCATION IS LOCATED IN ZONE C, AREAS OF MINIMAL FLOODING.

10. ALL UTILITIES SHALL BE APPROVED BY LOCAL UTILITY COMPANIES PRIOR TO CONSTRUCTION; ALL UTILITIES SHALL BE CONSTRUCTED TO UTILITY COMPANY SPECIFICATIONS,

- 11. NO CHANGES CAN BE MADE TO THESE PLANS WITHOUT THE ENGINEER'S APPROVAL
- 12. CONTRACTOR SHALL OBTAIN ALL REQUIRED LOCAL & STATE PERMITS PRIOR TO BEGINNING ANY CONSTRUCTION.
- 13. FIELD CHANGES SHALL HAVE PRIOR APPROVAL OF THE ENGINEER.

SITE INFORMATI	ON
PARAMETER	MEASUREMENT
NEAREST OFF-SITE RESIDENCE	±1,050 FEET
NEAREST MUNICIPAL BOUNDARY	>3,000 FEET
ACCESS FROM CEMETERY ROAD	±1,670 FEET
RESIDENTIAL STRUCTURES WITHIN 1,000 FEET	1.
NEAREST PROPERTY LINE	40 FEET
TREES TO BE REMOVED	0

ABUTTERS LINE	
EDGE OF PAVEMENT	
EDGE OF GRAVEL	
EXISTING CONTOUR	
STONE WALL	
RETAINING WALL	244
LIMITS OF INLAND WETLANDS	-4 47/
FENCE	
TREE LINE	
OVERHEAD WIRES	o/w
NOW OR FORMERLY	N/F
UTILITY POLE	
BOUNDARY POINT	0
DRILL HOLE	DH 🛞
IRON MONUMENT	•
CONNECTICUT HIGHWAY DEPARTMENT MONUMENT(CHD)	
IRON PIPE	IP
IRON ROD	IR
RAIL ROAD SPIKE	RRSPK
WELL	(9)
WATER VALVE	M
	WV

LEGEND

Cellco Partnership d/b/a Verizon Wireless



WIRELESS COMMUNICATIONS FACILITY 99 EAST RIVER DRIVE EAST HARTFORD, CT 06108

On Air Engineering, LLC

88 Foundry Pond Road Cold Spring, NY 10516 onair@optonline.n 201-456-4624



LICENSURE



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NEW BUILD MACRO

DW

CANTERBURY SOUTH CT

PROJECT INFORMATION:


46 CEMETERY RD. CANTERBURY, CT 06331

DRAWING TITLE:

ENLARGED SITE PLAN

SHEET NUMBER:

C-3

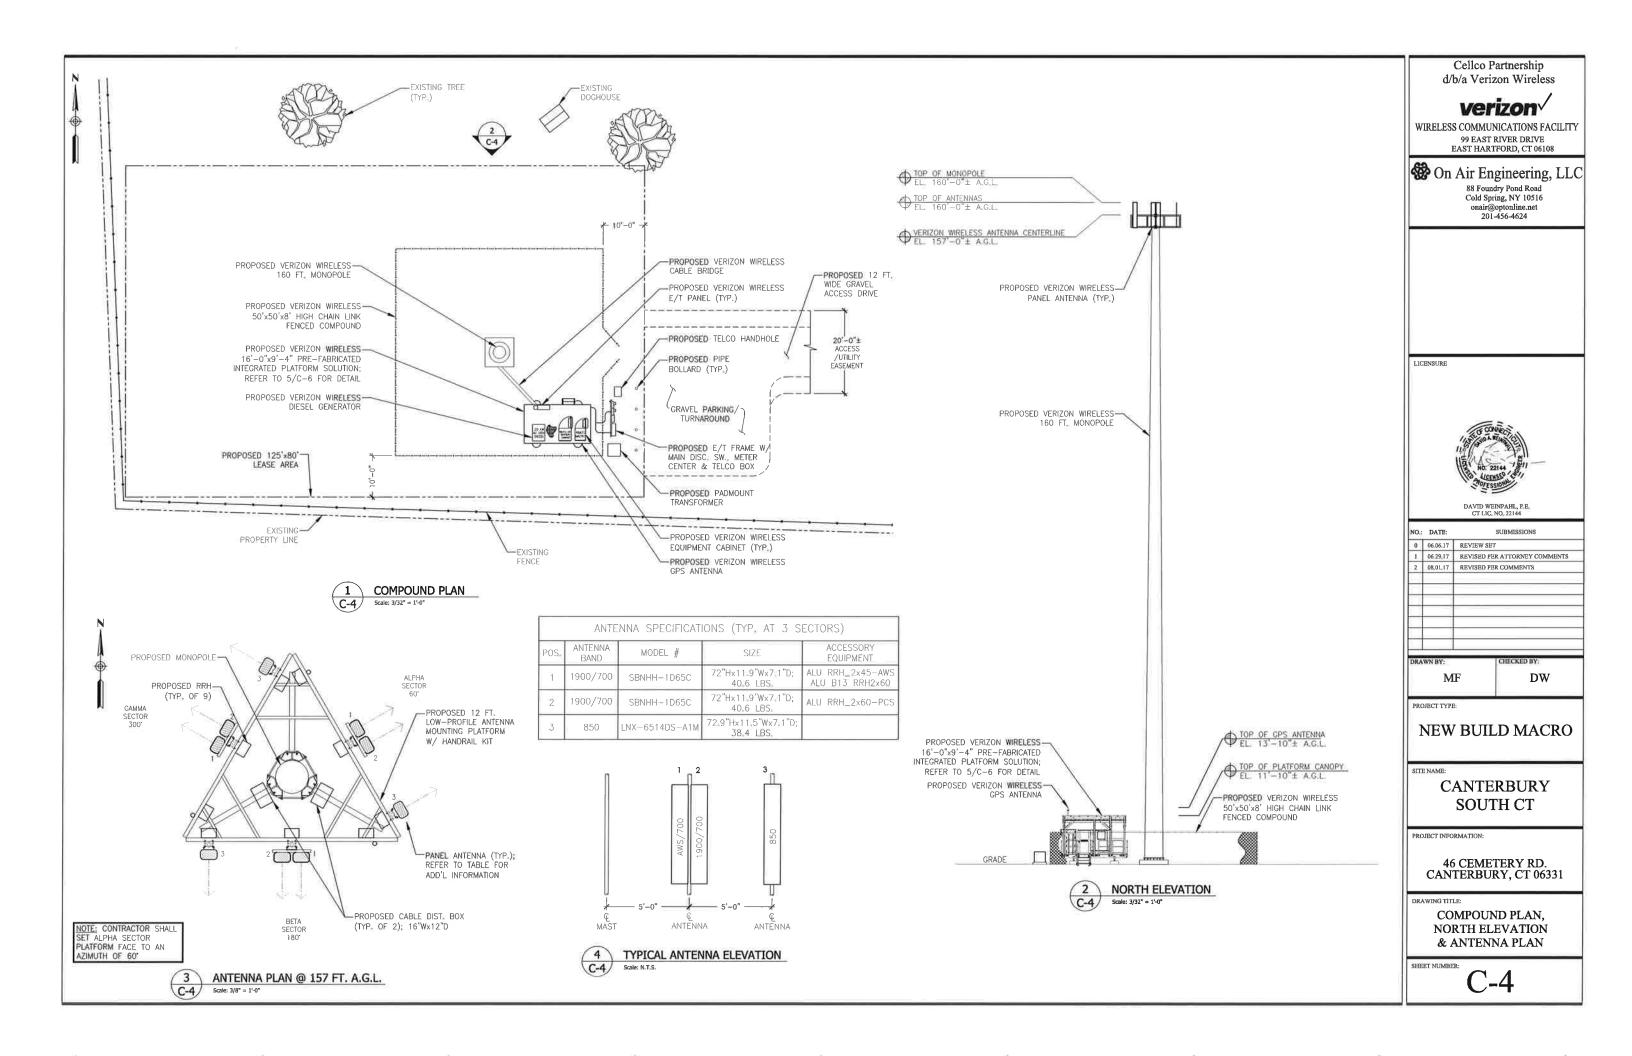




GRAVEL DRIVEWAY SURFACE


2 CRUSHED STONE SHALL MEET OF DOT STANDARD SPECIFICATIONS MIGH DE NG. 3.



GRAVEL COMPOUND SURFACE

STANDARD SPECIFICATIONS VIOLOT NO 5

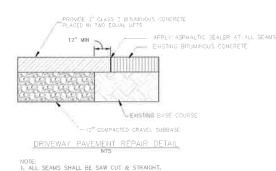

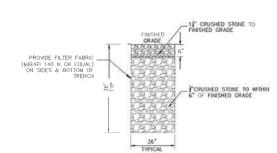

STONE TRENCH CROSS SECTION

It is of the ulmost importance that the Controctor complies with the requirement for the installation of protective measures, restorolico of offected wellands and the education of its employees and subcontractors performing work on the project site. These measures will also provide protection to and properly restore welland areas temporarily affected by the proposed underground utility tranching work. All-Points Technology Corporation, P.C. (APT) will serve as the Environmental Monitor for this project to ensure that welland protection and restoration measures are implemented property. The Controctor shall contact Deon Custafson, Senior Welland Scientist at APT of least 5 business days prior to the pre-construction meeting, Mr. Gustafson can be reached by phone of (860) 984–9515 or via email as adjustafson@alpointstech.com,

The welland protection pragram consists of several components: use of appropriate erosion control measures to control and contain erosion while avoiding/minimizing wildlife entanglement; periodic inspection and mointenance of isolation structures and erosion control measures; education of all contractors and sub-contractors prior to initiation of work an the site; welland protective measures; welland restoration measures, and, reporting.

1 Erosion and Sedimentation Controls

a.All erosion and sedimentation controls shall conform to the 2002 Connecticut Guidelines for Soil Erosion and Sediment Control, DEP Bulletin

b.Plastic nelting used in a variety of erosion control products (i.e., erosion control blankets, fiber rolls [wattles], reinforced silt fence) has been found to enlangle wildlife, including reptiles, amphibians, birds and small mammals. No permanent erosion control products or reinforced silt fence will be used on the project. Temporary Erosion control braducts will use either erosion control blankels and fiber rolls composed of processed fibers mechanically bound tagether to form a continuous matrix (net tess) or netting composed of planar woven natural biodegradable fiber to avoid/minimize wildlife enlanglement.

d.Sit fencing shall consist of non-reinforced conventional erasion control soven fabric, installed approximately six inches below surface grade and staked at seven to ten-foot intervals using four-foot oek stakes or approved equivalent. The Contractor is responsible for daily inspections or cumulation levels of sedimental, particularly following storm events that generate a discharge. The Environmental Monitor will provide periodic inspections of the sedimentation and erosion controls throughout the duration of construction activities only as it pertains to protection of are species and nearby extlands.

e. The extent of erosion controls will be as shown on the site plans. The Contractor shall have additional sedimentation and erosion controls stockgeind on site should field or construction controls beliefling to the control of the

g.All silf fencing and other erosion control devices shall be removed within 30 days of campletion of work and permonent stabilization of site soils so that restricted. If filter color work was the soil so that restricted. If filter color work was the soil so other natural makerial arosion control products are used, such devices will not be left in place to biologorade and shall be promptly removed after soils are stable so as not to create a barrier to migrating wildlife. Seed from seeding of soils should not spread over filter rolls/wattles as it makes them harder to remove once soils are stable soil.

2.Welland Restoration Measures

b. Locate staging areas and access points. Staging areas should be located at least 50 feet from the edge of the wetland. Install sediment borriers down slope of any staging areas or access points.

d.Clearing, grubbing and utility trenching activities may not commence in any stage or phase of the project until the erosion and sedimentation controls specified by this protection plan and so detailed on the project site plans have been installed and have been reviewed and approved by the Environmental Monitor to ensure erosion controls are properly installed.

e.Soil excavated from wetland areas shall be carefully removed with the roots indact. This soil should be placed in a separate stackpile to be reused during the wetland restoration work. Both wetland topsoil and subsoil shall be segregated into separate stockpiles.

h.Install pipe and trench plugs in wetland areas, as necessary, to prevent the trench from draining the welland or changing its hydrology, as determined by the Environmental Monitors.

Backfill pipe trench. Backfill first with stackpiled wetland subsoil, with the top 12-inches of the excayated trench filled with the stackpiled wetland topsoil to match original surface grades.

j. No soil amendments such as agricultural lime, fertilizer, etc. will be used within welland greas.

k.Compact backfill and grade the surface of the trench area to allow for positive drainage to soil erosion and sediment controls and to prepare disturbed areas for permanent trench restoration.

m.Seed disturbed wetland areas with a New England Wet Seed Mix (New England Wetland Plants, Inc., or approved equivarient) at the manufacturers recommended seed rote. Mulch disturbed wetland areas with non-woven natural riser erosion control blanket or 2 to 3 inches of ciean stow mulch.

n.Seed disturbed upland oreas with a New England Semi-Shade Grass and Forbs Mix (New England Welland Plants, Inc., or approved equivalent) at the manufacturers recommended seed rate. Mulch disturbed areas with non-waven natural fiber erasion control blanket or 2 to 3 inches of clean strow mulch.

p.Remove all soil and erasion sediment control measures within 30 days upon establishment of a uniform 70% vegetative cover over the disturbed area. Re-grade and revegetate areas disturbed during the removal of the sail erasion and sediment controls.

WETLAND PROTECTION AND RESTORATION PROGRAM-CONTINUED

3 Contractor Education

a.Prior to work on site, the Contractor shall attend an educational session at the pre-construction meeting with APT. This orientation and educational session will consist of an introductory meeting with APT to understand the environmentally sensitive nature of the development site and the need to follow Protective Measures and Restoration Measures as described in Section 3 below.

a. Certain precautions are necessary to stare petroleum materials, refuel and contain and properly clean up any inadvertent fuel or petroleum (i.e., oil, hydraulic fluid, etc.) spill due to the project's location within and proximity to sensitive wellands.

b.A spill containment kit consisting of a sufficient supply of absorbent pods and absorbent material will be maintained by the Contractor at the construction site throughout the duration of the project, in addition, a waste drum will be kept on site to contain any used absorbent pads/material for proper and timely disposal off site in accordance with applicable local, state and federal laws.

i Petroleum and Hazardous Materials Storage and Refueling

1. Refueling of vehicles or machinery shall occur a minimum of 100 feet from wetlands or watercourses and shall take place on an impervious pad with secondary containment designed to contain fuels.

2.Any fuel or hazardous materials that must be kept on site shall be stored on an impervious surface utilizing secondary containment a minimum of 100 feet from without or withercourses.

ii Initial Spill Response Procedures

1. Stop operations and shut off equipment

2 Remove any sources of spark or flame.

3.Contain the source of the spill-

4.Determine the approximate volume of the spill.

5, dentify the location of natural flow paths to prevent the release of the spill to sensitive nearby waterways or wetlands...

6.Ensure that fellow workers are notified of the spill-

iii.Spill Clean Up & Containment

1. Obtain spill response materials from the on-site spill response kit. Place absorbent materials directly on the release area.

3.Isolate and eliminate the spill source.

4.Contact the Connecticut Siting Council along with other appropriate local, state and/or federal agencies, as ${\sf necessary}_{\sf in}$

5.Contact a disposal company to properly dispose of contaminated materials.

1.Complete an incident report.

2 Submit a completed incident report to the Connecticut Siting Council, along with other appropriate local, state and/or federal agencies, as necessary

5 Herbicide and Pesticide Restrictions

 α_i The use of herbicides and pesticides at the proposed wireless telecommunications facility is strictly prohibited. 6.Reporting

a.Daily Compliance Monitoring Reports (brief narrative and applicable photos) will be submitted by the Environmental Monitor to Verizon Wireless for compliance verification for each inspection performed.

b-Following completion of the construction project, the Environmental Monitor will provide a Compliance Monitoring Summary Report to Verizon Wireless documentaling implementation of the welland protection and restoration program. Verizon Wireless will provide a capy of the Compliance Monitoring Summary Report to the Connecticut Stiling Council for compliance

SEEDING SPECIFICATIONS

A. IF GROUND HAS BEEN PREVIOUSLY MULCHED, MULCH MUST BE REMOVED OR ADDITIONAL NITROGEN MUST BE ADDED.

B. REMOVE ALL SURFACE STONES 2" OR LARGER AS WELL AS ALL DEBRIS SUCH AS WRE, CABLE, TREE ROOTS, PIECES OF CONCRETE, CLOOS, CLUMPS, OR OTHER UNSUITABLE MATERIAL.


APPLY FERTILIZER AT 7.5 POUNDS PER 1,000 SQUARE FEET AND LIME AT 200 POUNDS PER 1,000 SQUARE FEET UNLESS SOIL TESTING FOR REQUIREMENTS IS PERFORMED.


D. NO MOWING IS TO BE UNDERTAKEN UNTIL THE MAJORITY OF THE VEGETATION IS AT LEAST 6" HIGH. MOWING SHOULD CUT THE TOP 1/3 OF VEGETATION. DO NOT UNDER ANY CIRCUMSTANCES CUT VEGETATION BELOW 3".


E. DO NOT APPLY ANY FORM OF WEED CONTROL UNTIL GRASS HAS BEEN MOWED AT LEAST 4 TIMES.

F. THESE SEEDING MEASURES ARE NOT TO BE USED ON SLOPES IN EXCESS OF 2:1 GRADING.

ALL DISTURBED AREAS OUTSIDE THE PAVEMENT AREA SHALL BE LOAMED AND SEEDED IN ACCORDANCE WITH THE SUGGESTED SEEDING MIXTURES TABLE

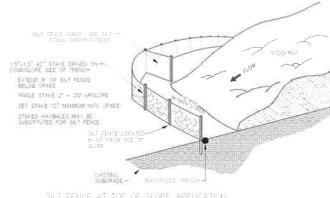

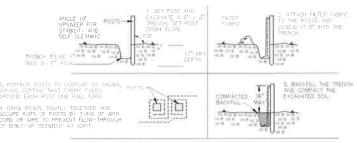

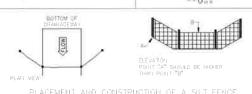

SILT FENCE SPECIFICATIONS

7. FLOW RATE

A. SYNTHETIC FILTER FABRIC SHALL BE A PERVIOUS SHEET OF PROPYLENE, NYLON, POLYESTER, ETHYLENE, OR SIMILAR FILAMENTS AND SHALL BE CERTIFIED BY THE MANUFACTURER OR SUPPLIER AS CONFORMING TO THE FOLLOWING MINIMUM REQUIREMENTS:

1, FILTERING EFFICIENCY 75 PERCENT (MIN) 2 GRAB TENSILE STRENGTH 100 POUNDS 3. ELONGATION AT FAILURE 15 PERCENT 250 POUNDS PER SQUARE INCH 4 MULLEN BURST STRENGTH

5. PUNCTURE STRENGTH 50 POUNDS 6. APPARENT OPENING SIZE

0.2 GALLONS PER SQUARE FOOT PER MINUTE 0.05 PER SECOND (MIN)

70 PERCENT AFTER 500 HOURS OF


EXPOSURE (MIN) STAKES ARE TO BE MADE OUT OF HARDWOOD WITH A MINIMUM CROSS SECTIONAL AREA OF 1.5 SQUARE INCHES OR STEEL POSTS WITH A MINIMUM WEIGHT OF 0.5 POUNDS PER LINEAR FOOT.

C. TORN OR PUNCTURED GEOTEXTILES SHALL NOT BE USED.

9. ULTRAVIOLET RADIATION STABILITY

ON SLOPES WHERE SURFACE FLOW FOLLOWS THE SILT FENCE LINE, PERPENDICULAR SILT FENCE CHECKS SHALL BE INSTALLED AT 50 FOOT

LINES OF SILT FENCE SHOULD FOLLOW CONTOUR LINES 5-10 FEET DOWN GRADIENT FROM THE SLOPE, WHERE CONTOUR LINES CAN NOT BE FOLLOWED PERPENDICULAR WINGS SHOULD BE PLACED AT 50 FOOT INTERVALS.

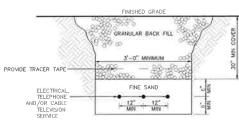

BURIED CABLE TRENCH CROSS SECTION

AREAS WHERE SEED MIX APPLIES	SEEDING MIXTURES BY WEIG	НТ	RATE PER 1,000 SQ FT.	SEEDING DATES
ALL LAWN AREAS	RED FESCUES KENTUCKY BLUEGRASS PERENNIAL RYEGRASS	45% 45% 10%	1 LBS	APRIL 1 - JUNE 15 OR AUG. 15 - OCT. I
ROAD CUTS, FILLS, DIVERSION DITCHES, & STORMWATER BASINS	KENTUCKY TALL FESCUE REDTOP CREEPING RED FESCUE	47% 6% 47%	0.95 LBS	APRIL 1 - JUNE 15 OR AUG. 15 - OCT. 1
WHERE TREES ARE TO BE	RETAINED, THE SEED MIXTURE	E SHOULD BE	ADAPTED FOR SHAD	Y CONDITIONS
TEMPORARY SEEDING	ANNUAL RYEGRASS OR		1-1/2 LBS=	WITHIN 7 DAYS AFTER

ANNUAL RYEGRASS OF PERENNIAL RYEGRASS

Cellco Partnership d/b/a Verizon Wireless



WIRELESS COMMUNICATIONS FACILITY 99 EAST RIVER DRIVE



onair@optonline.n 201-456-4624



LICENSURE



DAVID WEINPAHL, P.E

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	MILITARY	

DRAWN BY CHECKED BY: DW MF

PROJECT TYPE:

NEW BUILD MACRO

CANTERBURY SOUTH CT


PROJECT INFORMATION:

46 CEMETERY RD. CANTERBURY, CT 06331

CONSTRUCTION **DETAILS**

SHEET NUMBER:

C-5

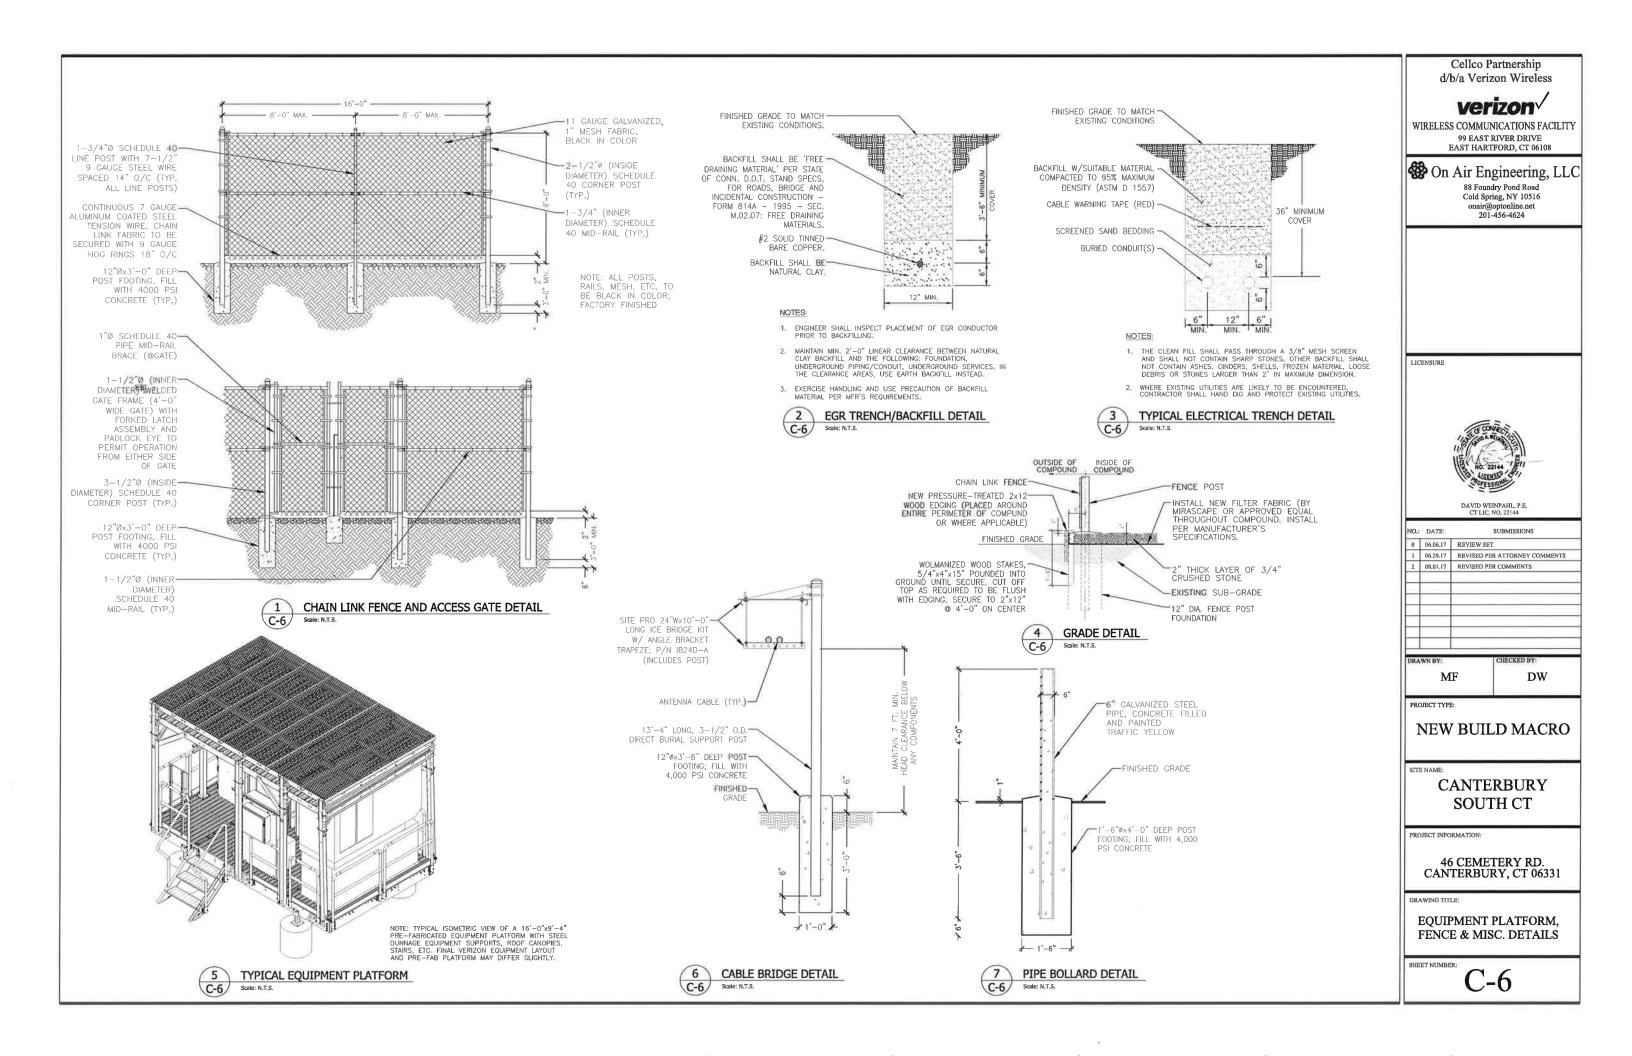

GENERAL STRUCTURAL NOTES:

- 1. ALL EQUIPMENT SHALL BE INSTALLED PLUMB AND LEVEL.
- 2, ALL WIDE FLANGE STRUCTURAL STELL SHALL CONFORM WITH A992 SPECIFICATIONS, ALL STRUCTURAL STEEL SHALL BE FABRICATED AND ERECTED IN ACCORDANCE WITH THE LATEST AISC CODE AND ASTM SPECIFICATION. STEEL SHALL CONFORM TO ASTM A-36. PIPE SHALL CONFORM TO ASTM A-501 OR ASTM TYPE EOR \$ A-53 (GRADE B).
- 3. ALL CONNECTIONS OF STRUCTURAL STEEL MEMBERS SHALL BE MADE USING SPECIFIED WELDS WITH WELDING ELECTRODES E-70XX OR SPECIFIED HIGH STRENGTH BOLTS TO BE ASTM A325, THREAD EXCLUDED FROM SHEAR PLANE.
- 4. ALL STEEL EXPOSED TO MOISTURE SHALL BE HOT DIPPED GALVANIZED AFTER FABRICATION PER ASTM A-123. ALL DAMAGED SURFACES, WELDED AREAS AND AUTHORIZED NON-GALVANIZED MEMBERS OR PARTS (EXISTING OR NEW)
 SHALL BE PAINTED WITH 2 COATS OF ZRC COLD GALVANIZING COMPOUND MANUFACTURED BY ZRC CHEMICAL PRODUCTS CO. QUINCY, MA, OR USE THERMAL SPRAYING WITH PLATTZINC 85/15 AS MANUFACTURED BY PLATT BROTHERS & COMPANY, WATERBURY, CT 1-800-752-8276.
- 5. ALL SHOP AND FIELD WELDING SHALL BE DONE BY WELDERS QUALIFIED AS DESCRIBED IN THE "AMERICAN WELDING SOCIETY'S STANDARD QUALIFICATION PROCEDURE' TO PERFORM THE TYPE OF WORK REQUIRED.
- 6. ALL PIPE SIZES ARE NOMINAL DIAMETER (INSIDE DIAMETER).

CAST-IN-PLACE CONCRETE:


- 1. ALL CONCRETE WORK SHALL CONFORM TO THE LATEST EDITION OF THE ACI BUILDING CODE.
- 2. ALL CONCRETE SHALL ATTAIN 4000 PSI COMPRESSIVE STRENGTH AT 28 DAYS.
- 3. READY MIX; COMPLY WITH ACI-301 AND ASTM C-94. ALL CONCRETE EXPOSED TO THE GROUND OR WEATHER SHALL BE AIR ENTRAINED.
- 4. COLD WEATHER CONCRETE POURING SHALL BE IN ACCORDANCE WITH ACI-306.
- 5. THROUGHOUT CONSTRUCTION THE CONCRETE WORK SHALL BE ADEQUATELY PROTECTED AGAINST DAMAGE DUE TO EXCESSIVE LOADING, CONSTRUCTION EQUIPMENT, MATERIALS, ICE, RAIN, SNOW, EXCESSIVE HEAT AND FREEZING
- 6. EARLY DRYING OUT OF CONCRETE, ESPECIALLY DURING THE FIRST 24 HOURS, SHALL BE CAREFULLY GUARDED AGAINST. ALL SURFACES SHALL BE PROTECTED USING MOIST CURING OR A MEMBRANE CURING AGENT APPLIED AS SOON AS FORMS ARE REMOVED OR FINISHING OPERATIONS ARE COMPLETE. CARE SHALL BE EXERCISED SO AS NOT TO DAMAGE
- 7. APPLY NON-SLIP BROOM FINISH IMMEDIATELY AFTER TROWEL FINISHING.
- 8. CONTRACTOR TO COORDINATE REQUIREMENTS OF STRUCTURAL, CIVIL, MECHANICAL AND ELECTRICAL DRAWINGS INCLUDING ANY AND ALL PENETRATIONS SPECIFIED PRIOR TO POURING CONCRETE.
- 9. CONTRACTOR SHALL PROVIDE A 3/4" CHAMFER ON ALL CONCRETE SLABS.


REINFORCING:


- 1. ALL REINFORCING BAR SHALL CONFORM TO THE LATEST ACI CODE AND DETAILING MANUAL
- 2, WHERE REINFORCING IS CALLED OUT IN THE CONSTRUCTION DOCUMENTS IT SHALL BE 3" CLEAR COVER (MINIMUM UNLESS OTHERWISE NOTED).
- 3. ALL BARS SHALL BE ASTM A-615, GRADE 60.
- 4. WELDED WIRE FABRIC SHALL BE ASTM A-185.
- 5. WHERE CONTINUOUS BARS ARE CALLED FOR, THEY SHALL BE RUN CONTINUOUSLY AROUND CORNERS AND LAPPED AT NECESSARY SPLICES OR HOOKED AT DISCONTINUOUS ENDS. LAP SHALL BE 40 BAR DIAMETERS.

FOUNDTAION


FOOTINGS SHALL BEAR ON UNDISTURBED SOIL AND /OR SUPERVISED COMPACTED FILL, FREE OF FROST, HAVING A MINIMUM ALLOWABLE BEARING CAPACITY OF 1 1/2 TONS PER

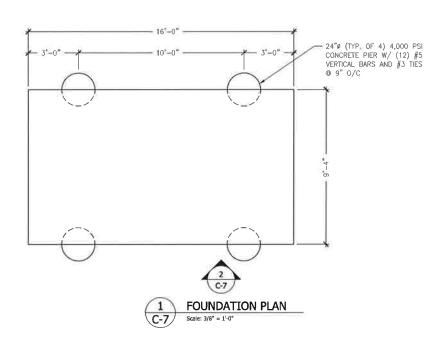

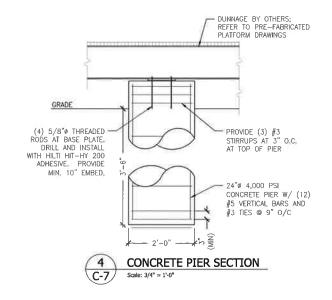

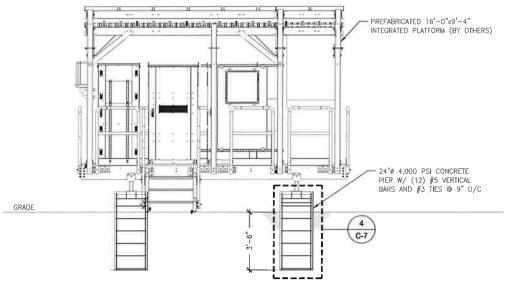



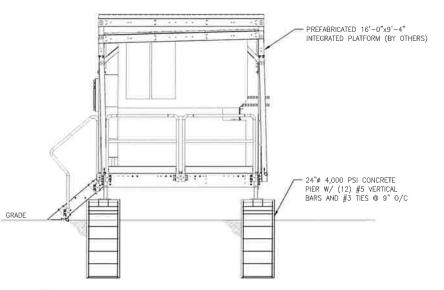

EQUIPMENT PLATFORM SHORT SECTION Scale: 3/8" = 1'-0"

Cellco Partnership d/b/a Verizon Wireless



WIRELESS COMMUNICATIONS FACILITY 99 EAST RIVER DRIVE EAST HARTFORD, CT 06108

On Air Engineering, LLC 88 Foundry Pond Road

Cold Spring, NY 10516 onair@optonline.net 201-456-4624

LICENSURE



NO.		SUBMISSIONS
0	06.06.17	REVIEW SET
1	06.29.17	REVISED PER ATTORNEY COMMENTS
2	08.01.17	REVISED PER COMMENTS
-	_	

MF DW

NEW BUILD MACRO

SITE NAME:

CANTERBURY SOUTH CT

PROJECT INFORMATION:

46 CEMETERY RD. CANTERBURY, CT 06331

DRAWING TITLE:

EQUIPMENT PLATFORM FOUNDATION PLAN & SECTIONS

SHEET NUMBER: