


PRELIMINARY - NOT ISSUED FOR CONSTRUCTION

GREENWICH - COS COB 115-kV TRANSMISSION LINE PLAN & PROFILE DRAWING GREENWICH, CT

BY CPS	CHKD	APP	APP				
DATE 4/12/2016	DATE	DATE	DATE				
H-SCALE1":400`	SIZE B	FIELD BOOK & PAGES					
v-scale 1" :80`	V.S.	R.E. DWG					
R.E. PROJ. NUMBE	R	DWG NO.01242-10001p001					

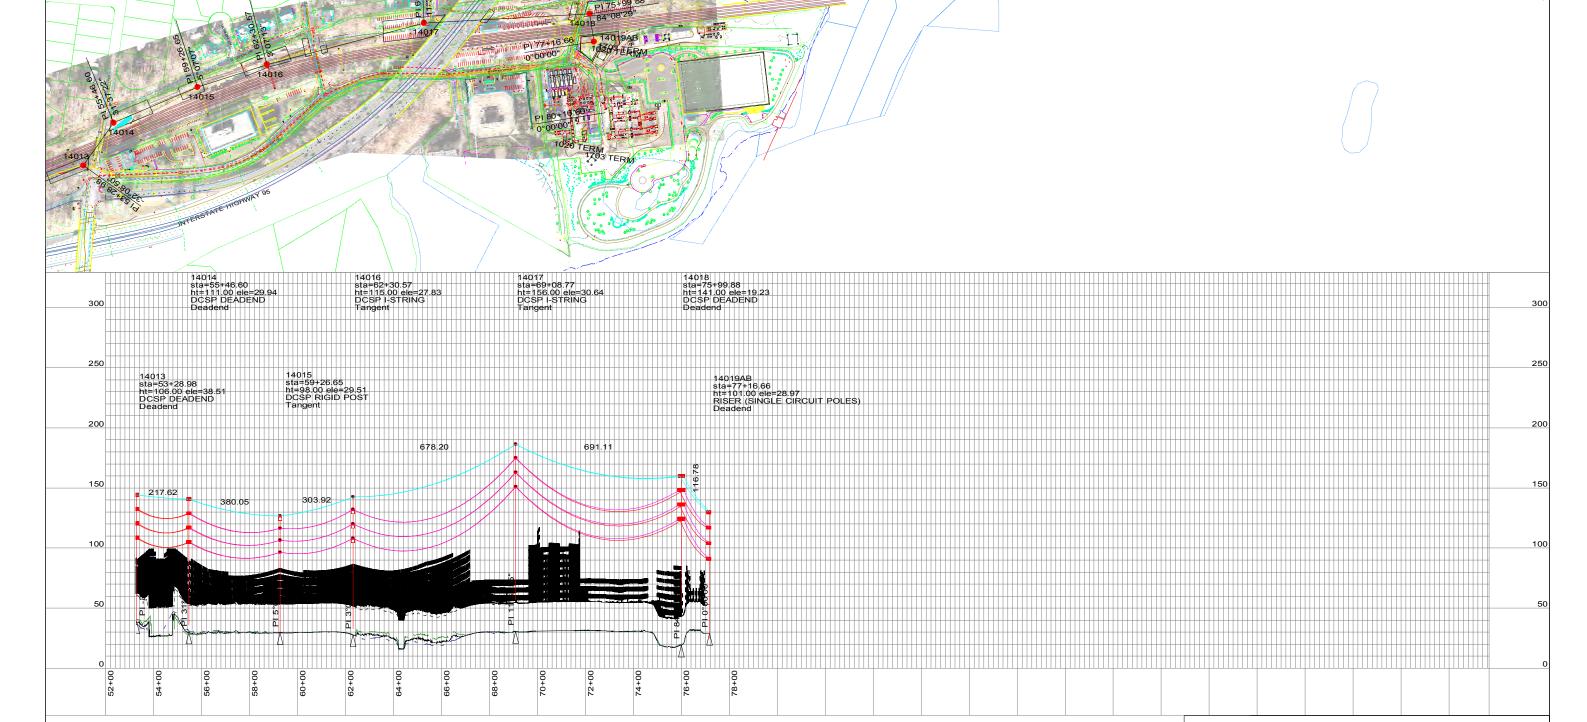






EVERS URCE ENERGY

GREENWICH - COS COB 115-kV TRANSMISSION LINE PLAN & PROFILE DRAWING GREENWICH, CT

BY CPS	CHKD	APP
DATE 4/12/2016	DATE	DATE
H-SCALE1":40	-	FIELD BOOK & PAGES
V-SCALE1":80	V.S.	R.E. DWG
R.E. PROJ. NU	MBER	DWG NO.01242-10001p002

PRELIMINARY - NOT ISSUED FOR CONSTRUCTION

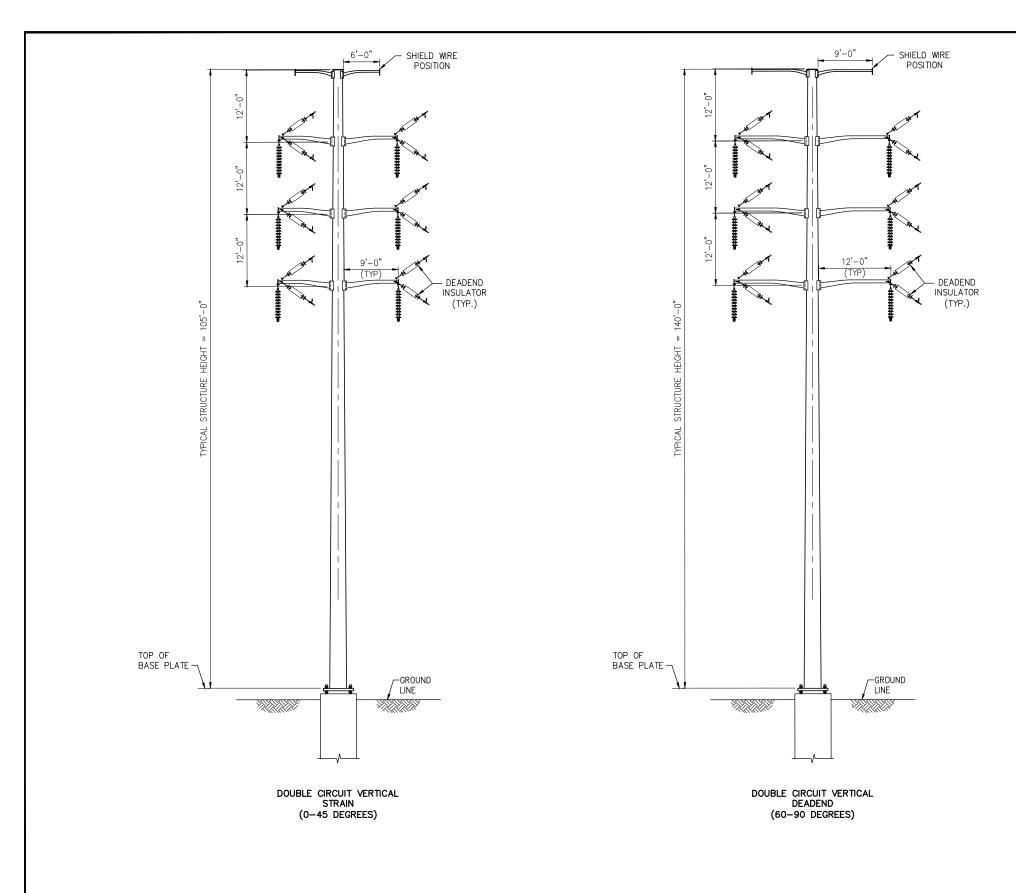

- NOTES:


 1. STRUCTURES SHOWN DEPICT STEEL POLE CONSTRUCTION.
- 2. STRUCTURE GROUNDING EQUIPMENT NOT SHOWN.


GREENWICH LINE AND SUBSTATION PROJECT DOUBLE CIRCUIT DEADEND CONFIGURATION FAMILY OF STRUCTURES


PRELIMINARY - NOT ISSUED FOR CONSTRUCTION

	01									
BY	BMcD	CHKD	-	APP _	APP _					
DATE	01/09/2017	DATE	-	DATE	DATE					
H-SCALE		size D	D	FIELD BOOK & PAGES						
V-SCAL		v.s.		R.E. DWG —						
R.E. PF	KOJ. NUMBER			SHEET 1 OF 3						

EVERSOURCE

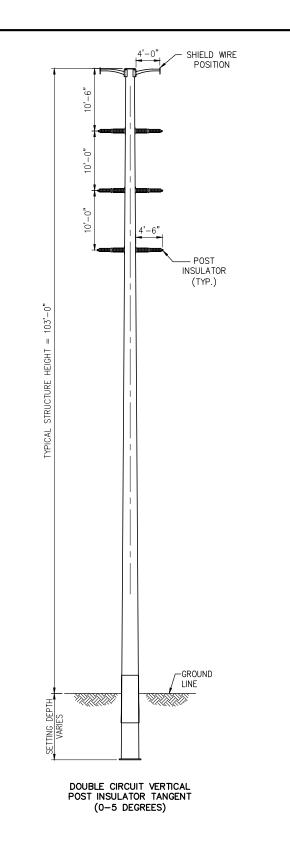

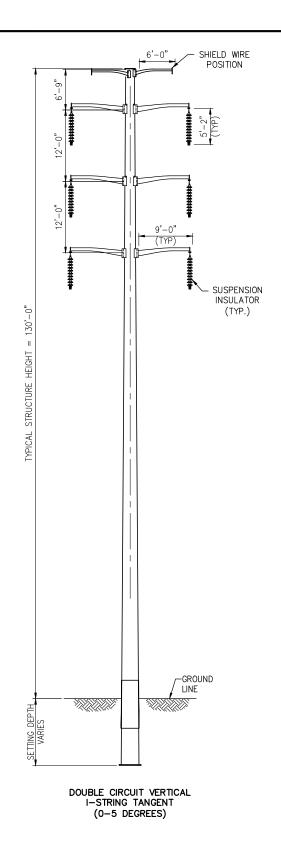

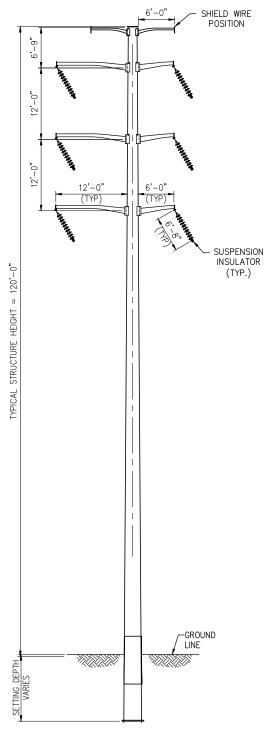

DOUBLE CIRCUIT VERTICAL I-STRING ANGLE (5-15 DEGREES)


NOTES

- 1. STRUCTURES SHOWN DEPICT STEEL POLE CONSTRUCTION.
- 2. DRILLED PIER FOUNDATIONS MAY BE UTILIZED FOR SUSPENSION STRUCTURES.
- 3. STRUCTURE GROUNDING EQUIPMENT NOT SHOWN.

EVERSOURCE ENERGY

GREENWICH LINE AND SUBSTATION PROJECT
DOUBLE CIRCUIT SUSPENSION CONFIGURATION
FAMILY OF STRUCTURES

PRELIMINARY - NOT ISSUED FOR CONSTRUCTION

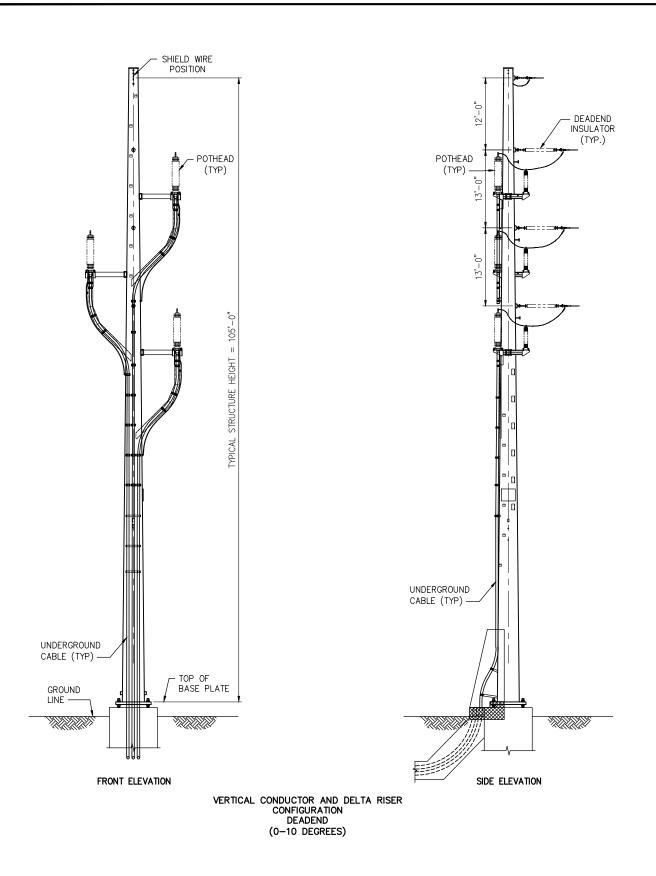

- DEADEND INSULATOR (TYP.) POTHEAD (TYP) — POTHEAD UNDERGROUND CABLE (TYP) — PLAN VIEW UNDERGROUND CABLE (TYP) — — TOP OF BASE PLATE GROUND LINE -SIDE ELEVATION FRONT ELEVATION VERTICAL CONDUCTOR AND UNDERBUILD RISER CONFIGURATION DEADEND (0-10 DEGREES)

SHIELD WIRE POSITION


- NOTES:
 1. STRUCTURES SHOWN DEPICT STEEL POLE CONSTRUCTION.
- 2. STRUCTURE GROUNDING EQUIPMENT NOT SHOWN.


EVERSOURCE


GREENWICH LINE AND SUBSTATION PROJECT SINGLE CIRCUIT TRANSITION STRUCTURE FAMILY OF STRUCTURES


PRELIMINARY - NOT ISSUED FOR CONSTRUCTION


	C	· I		
CHKD	-	APP –	APP	-
DATE	-	DATE	DATE	
SIZE D	D	FIELD BOOK & PAGES		
v.s.		R.E. DWG	-	
		NUSCO	SHEET:	3 OF 3
	DATE SIZE D	CHKD _ DATE _ SZE D		OND

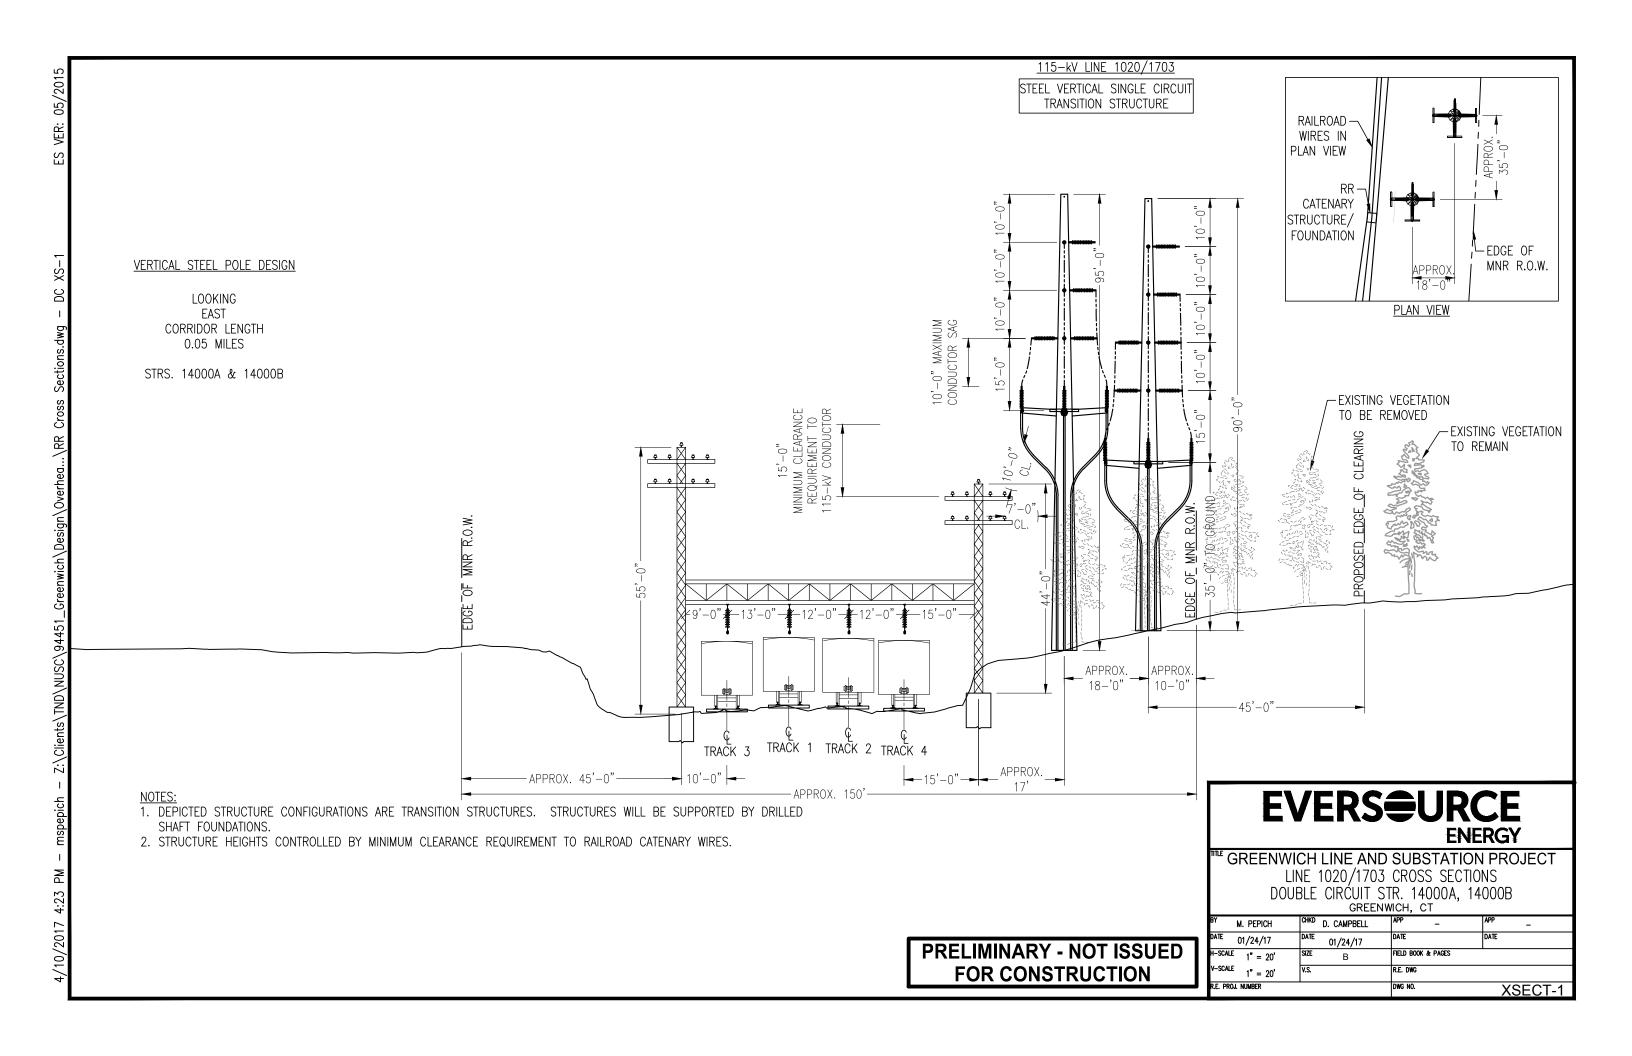


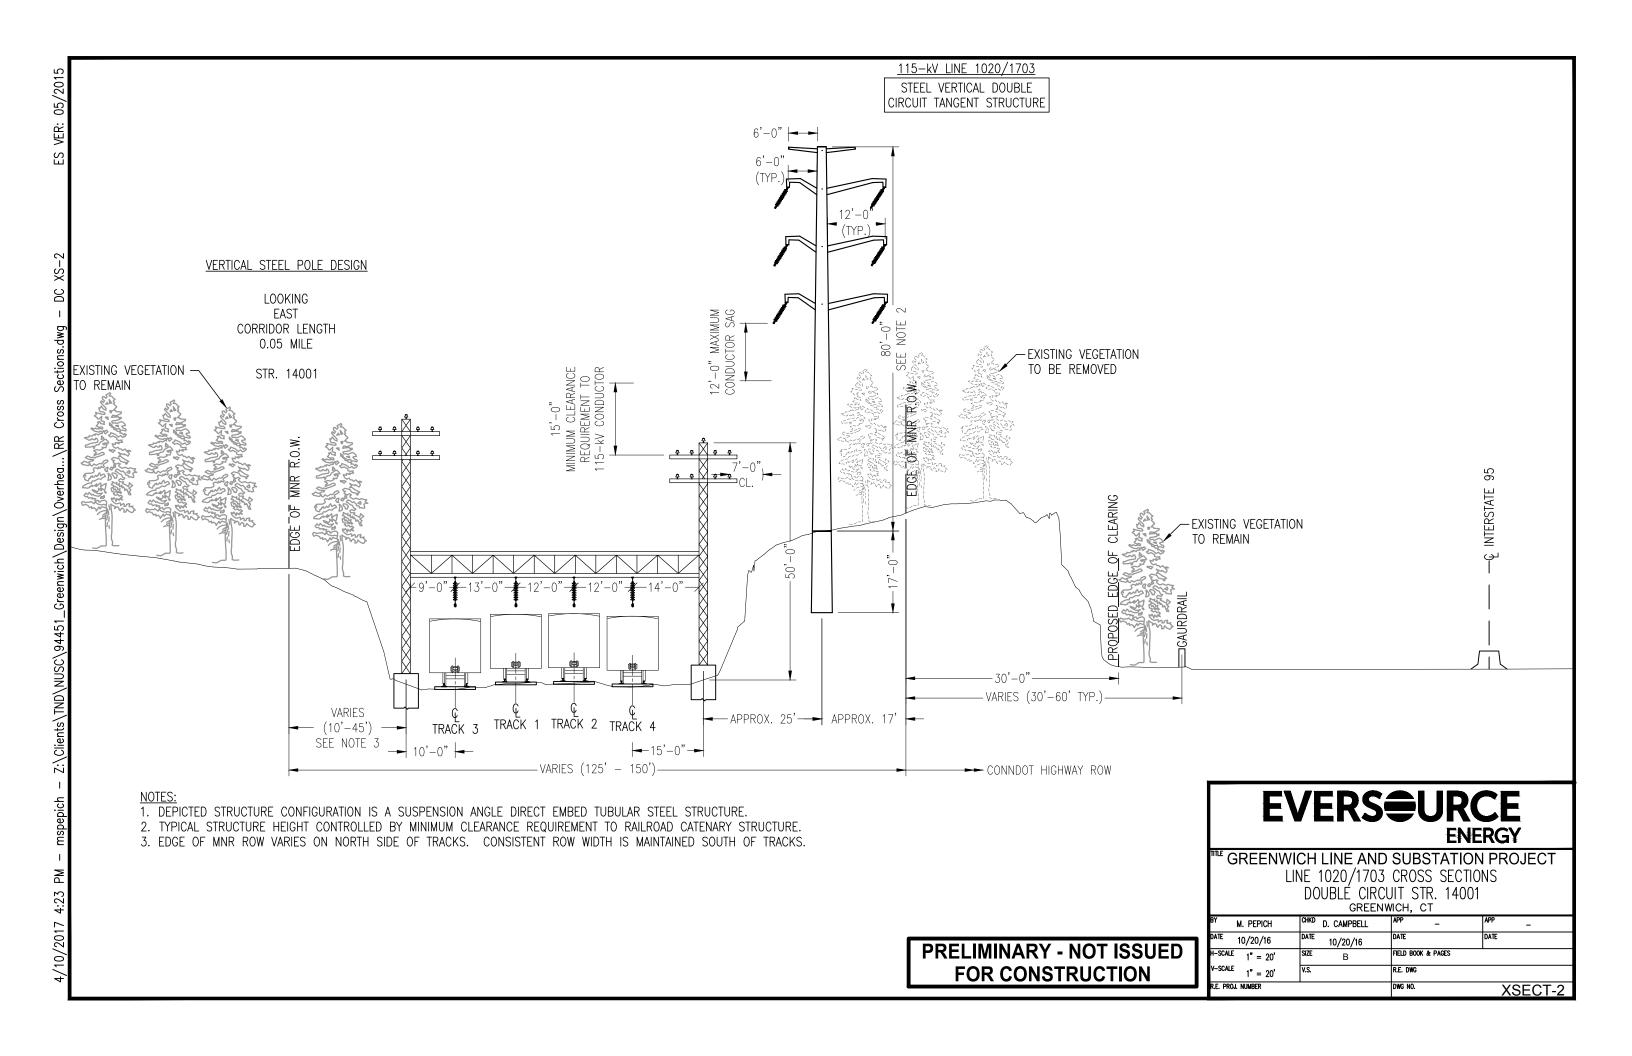


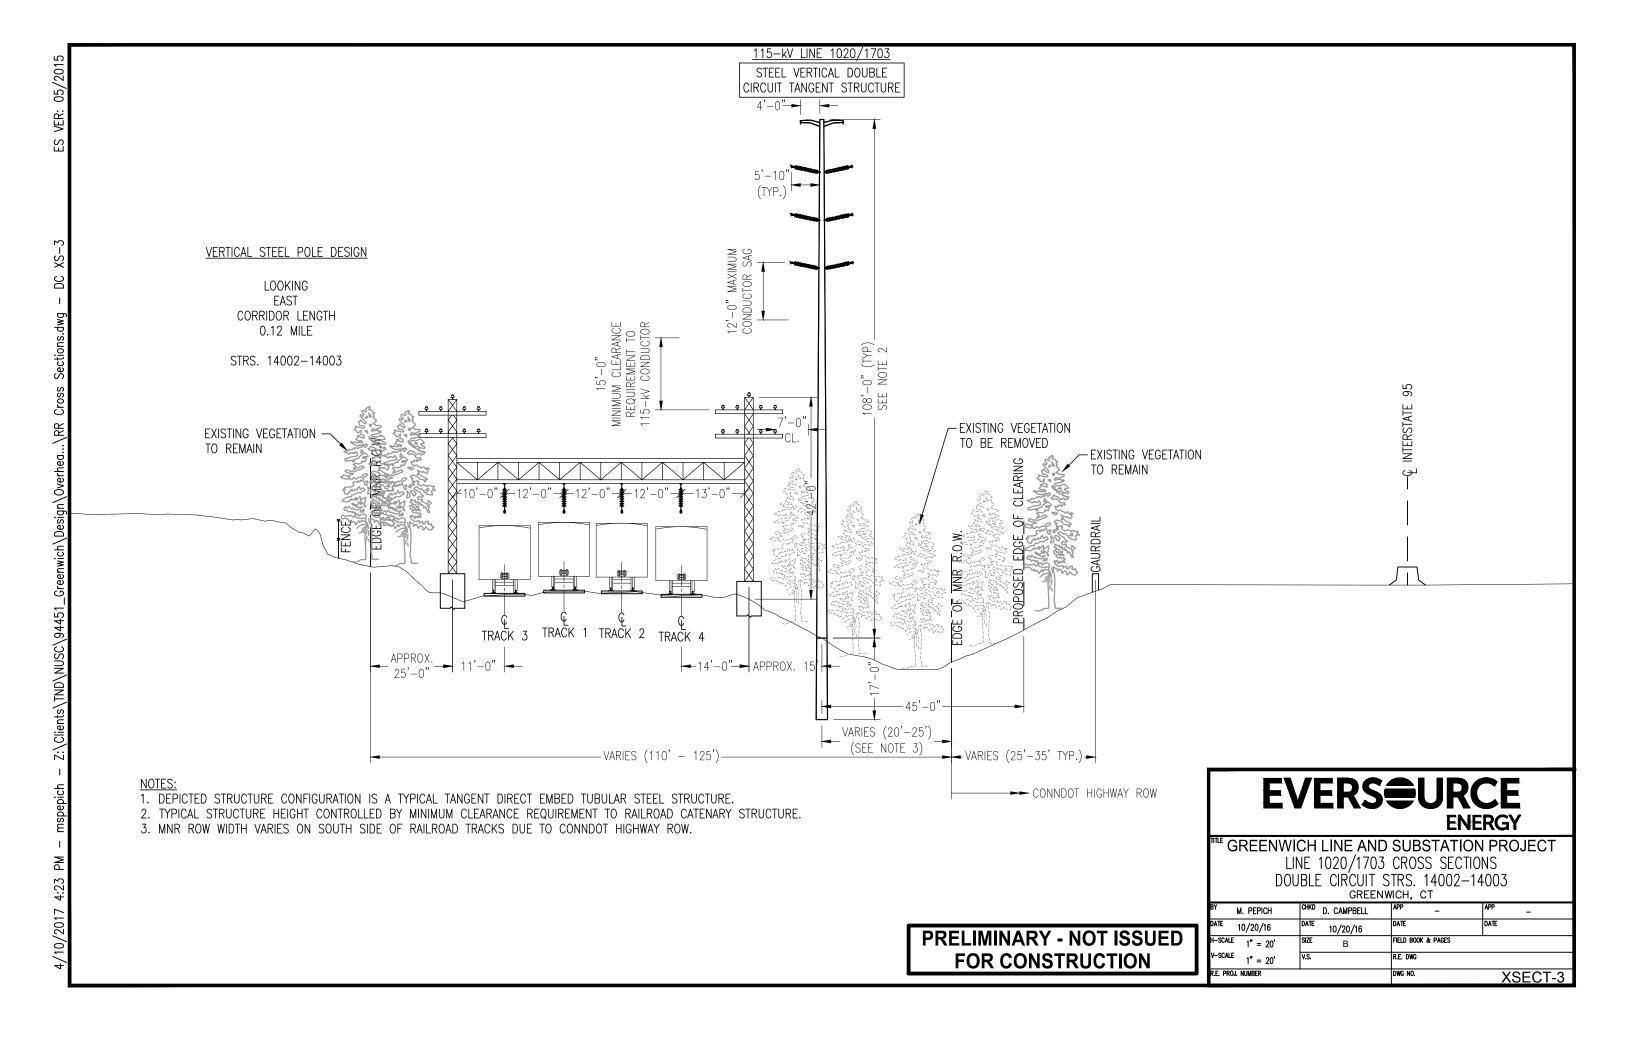


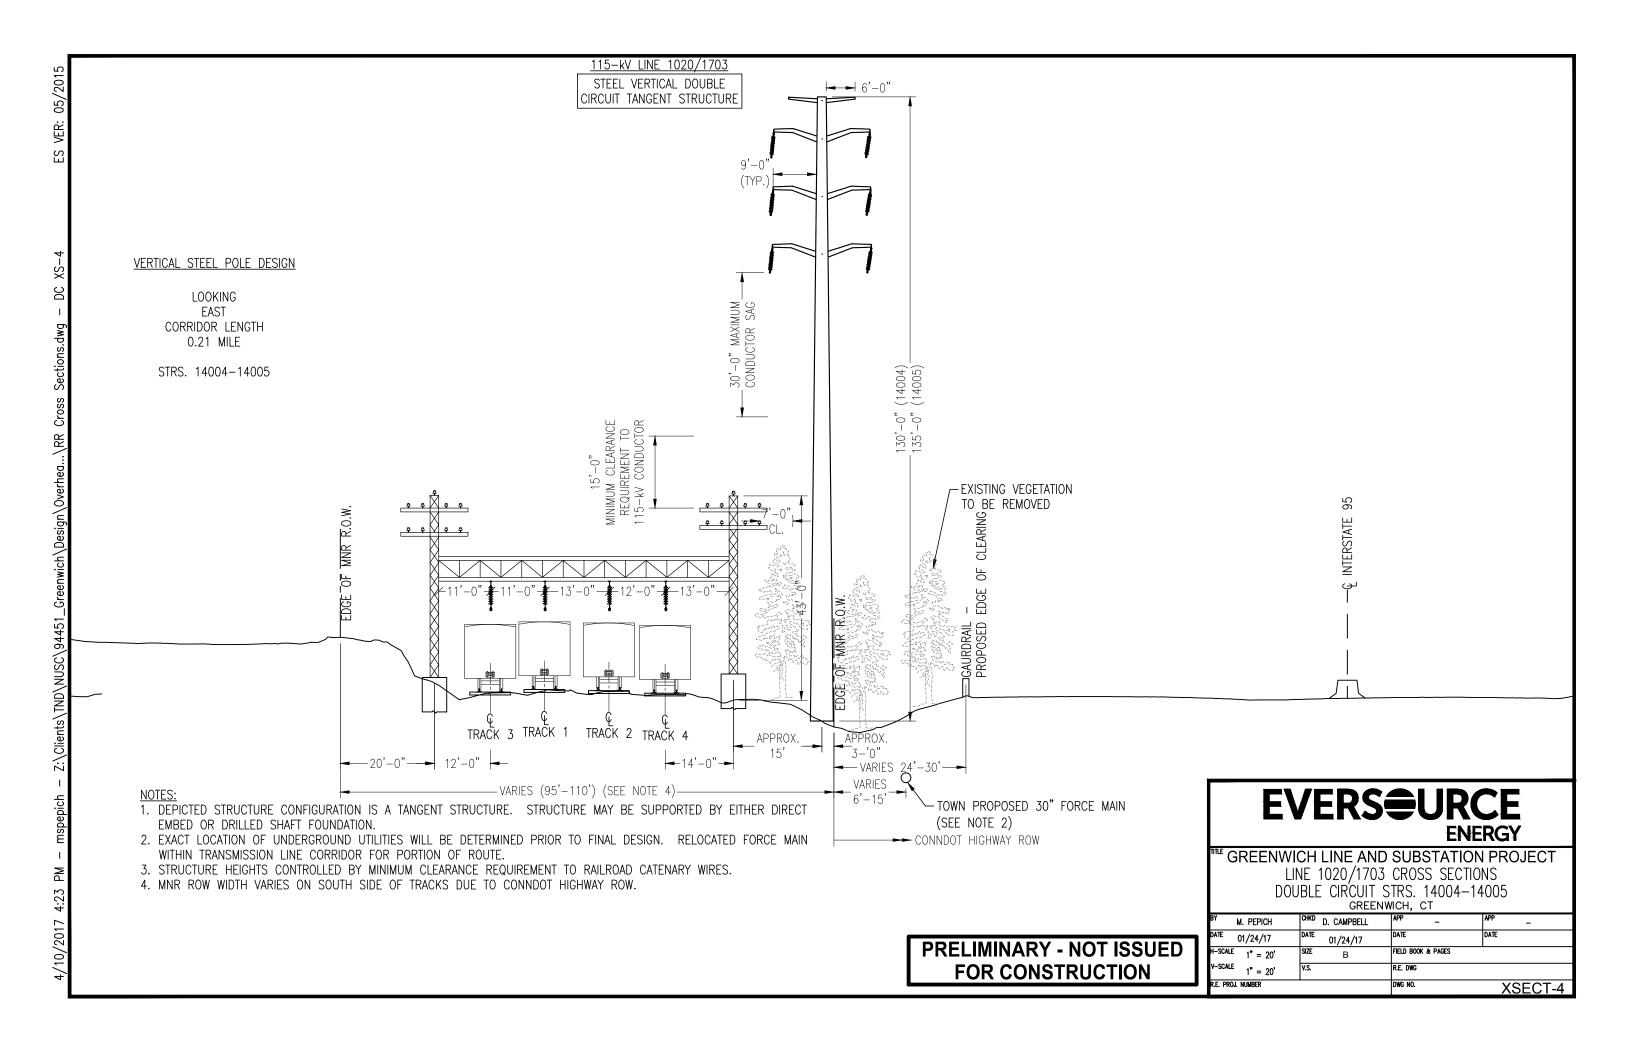


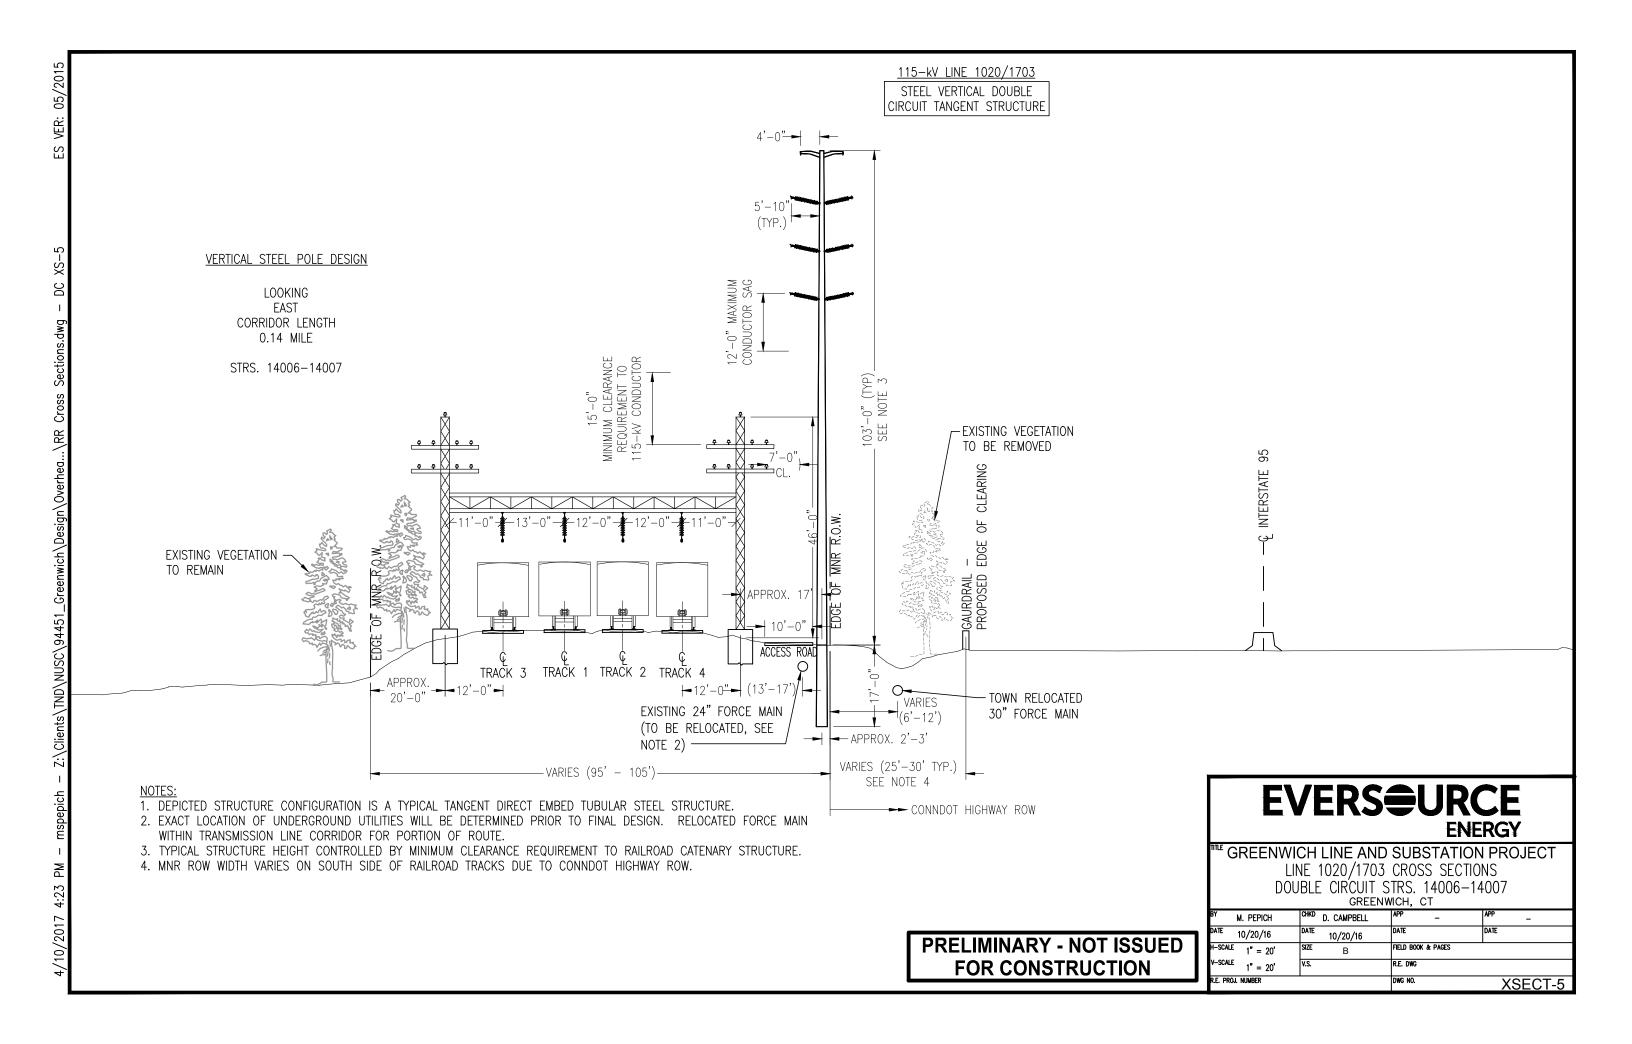


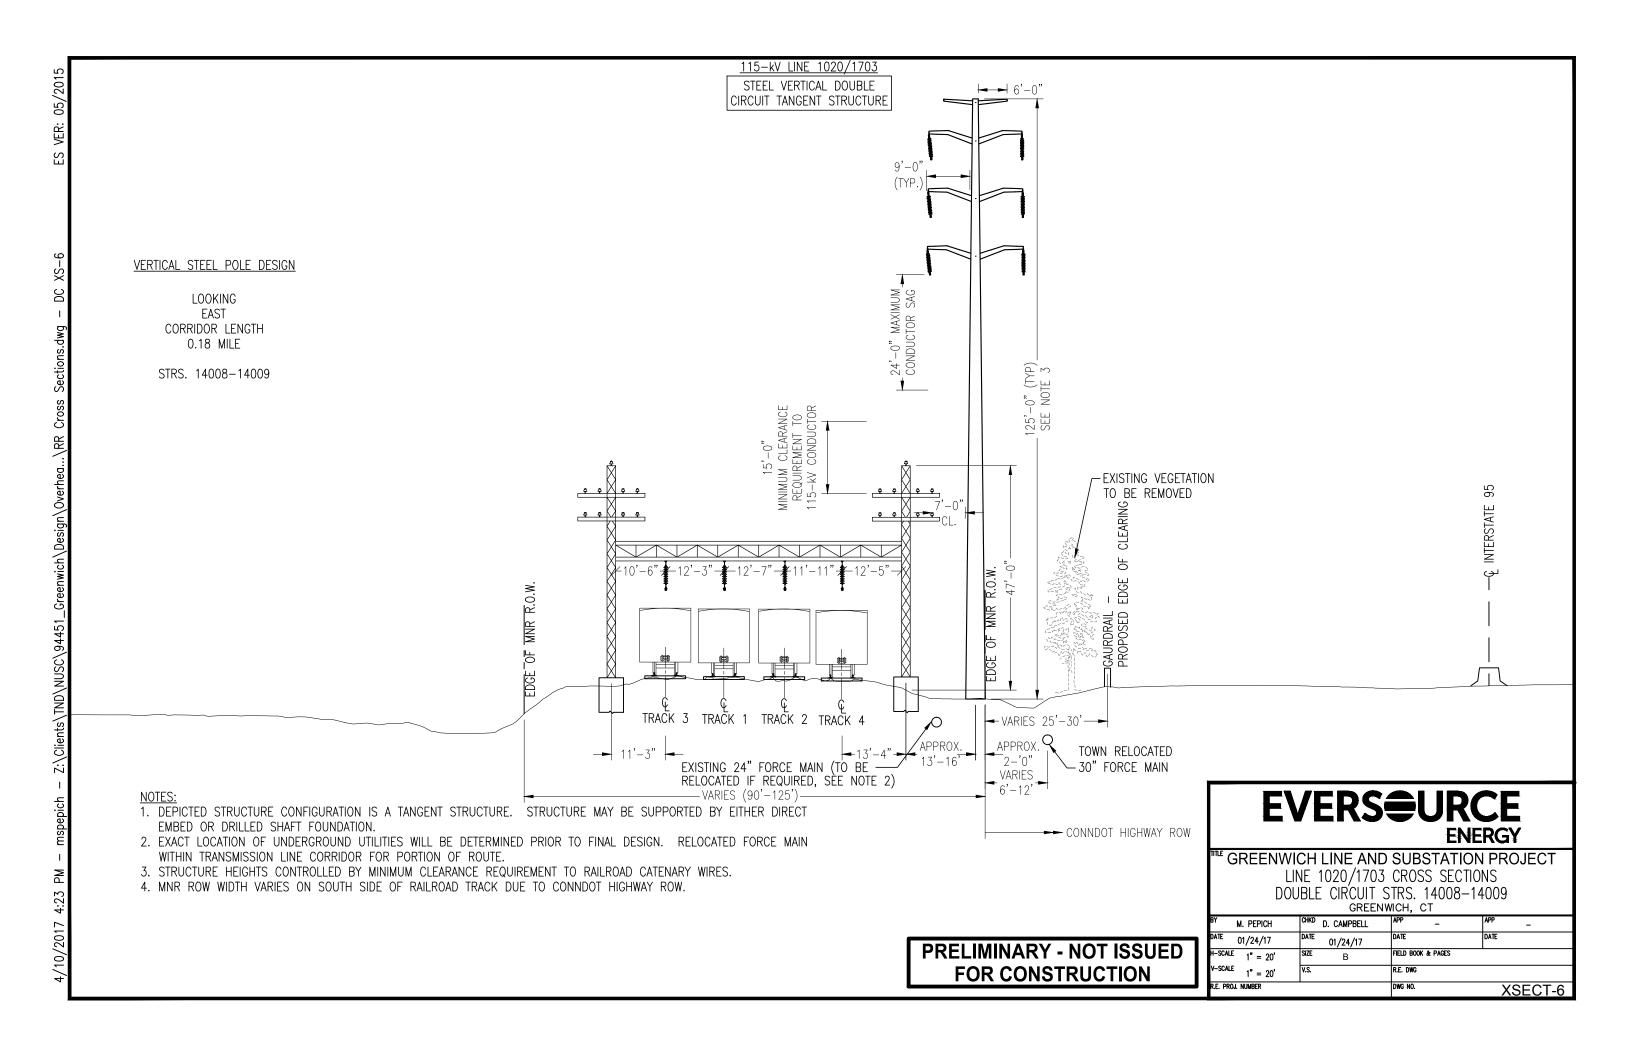


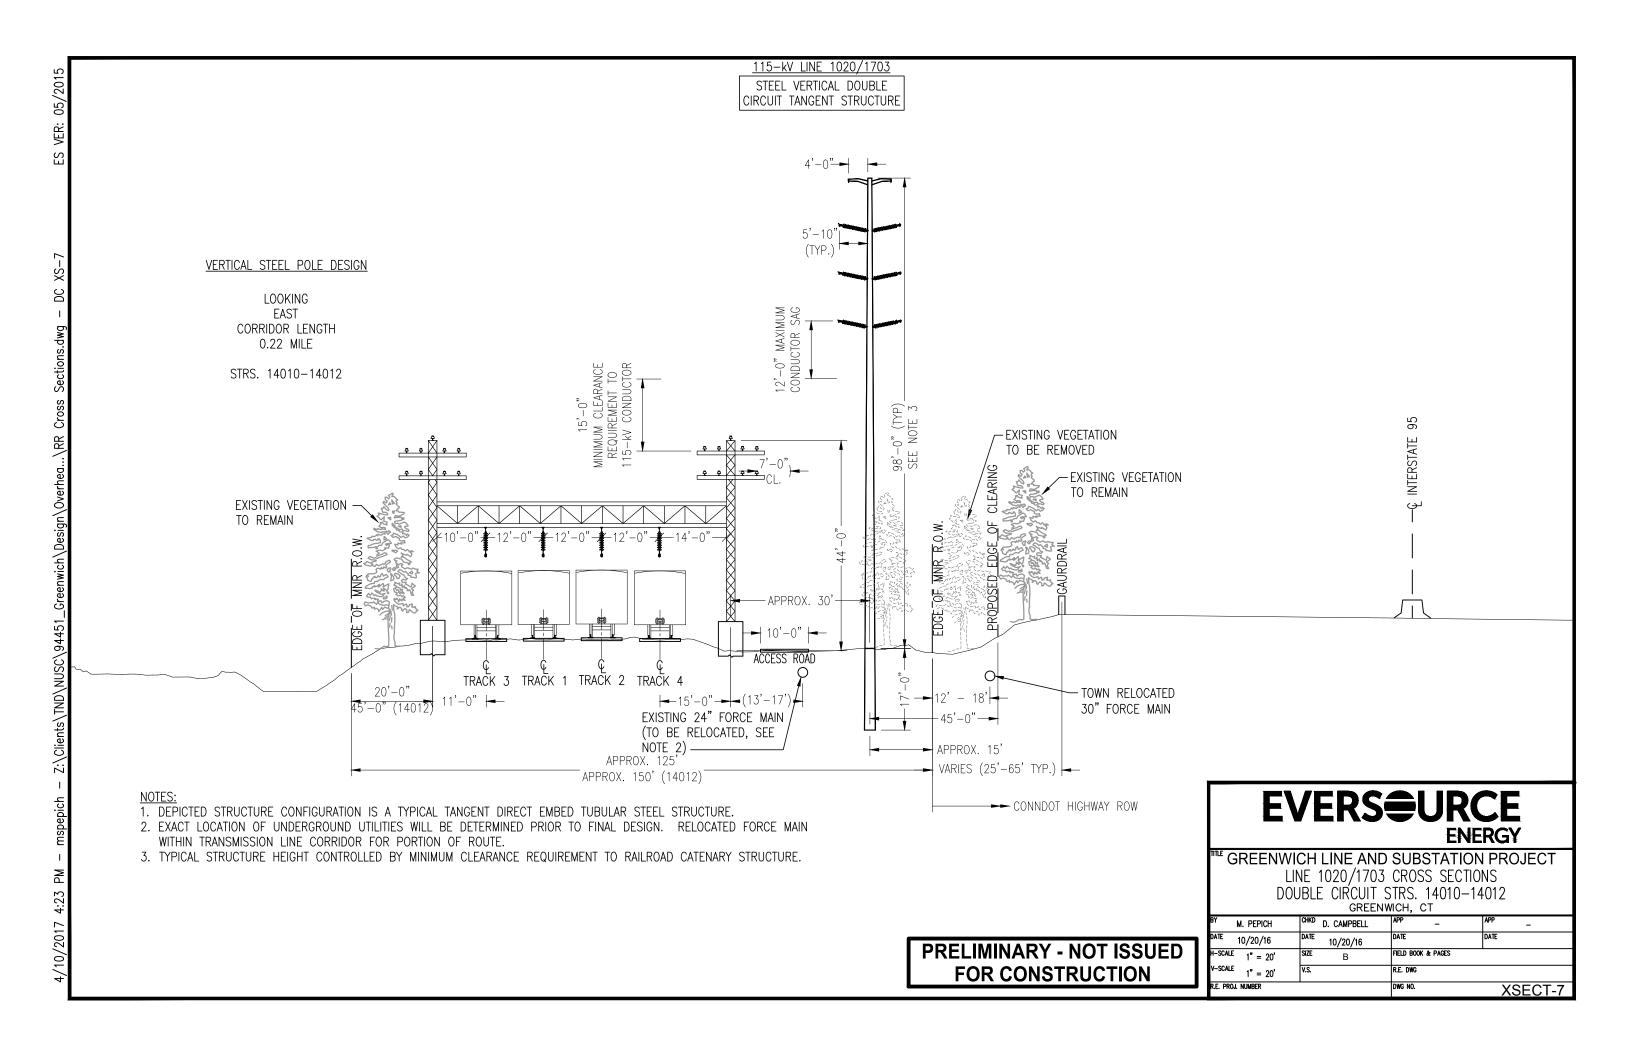


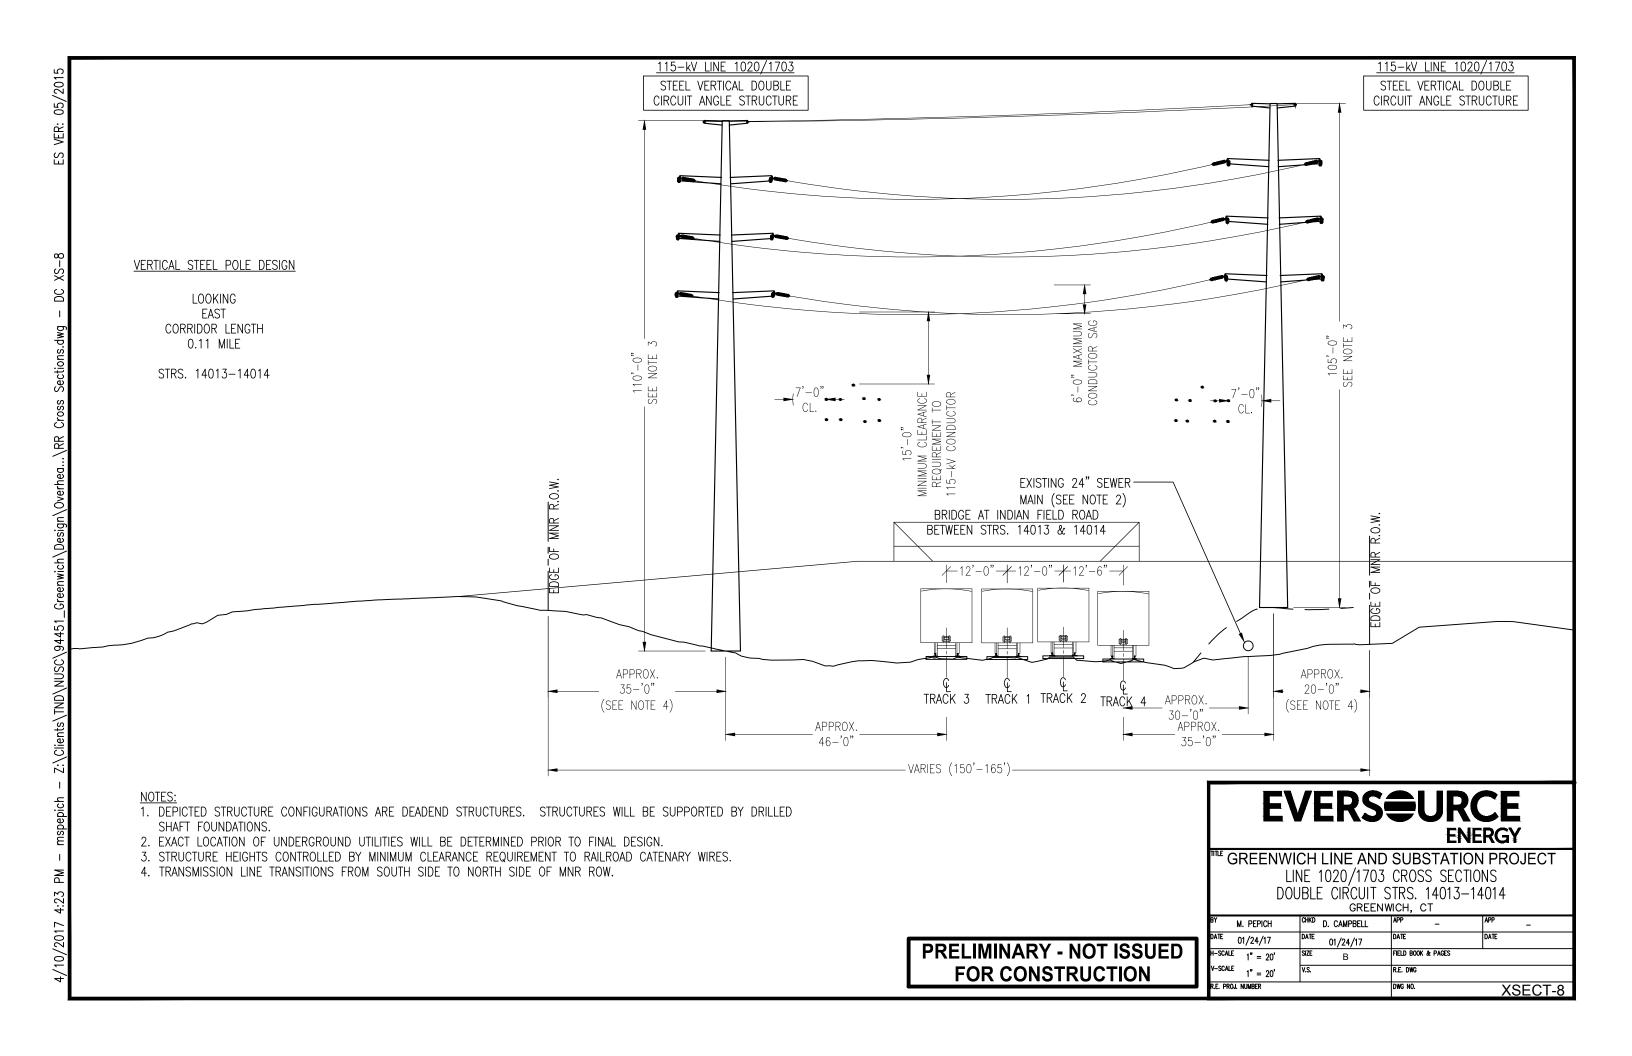

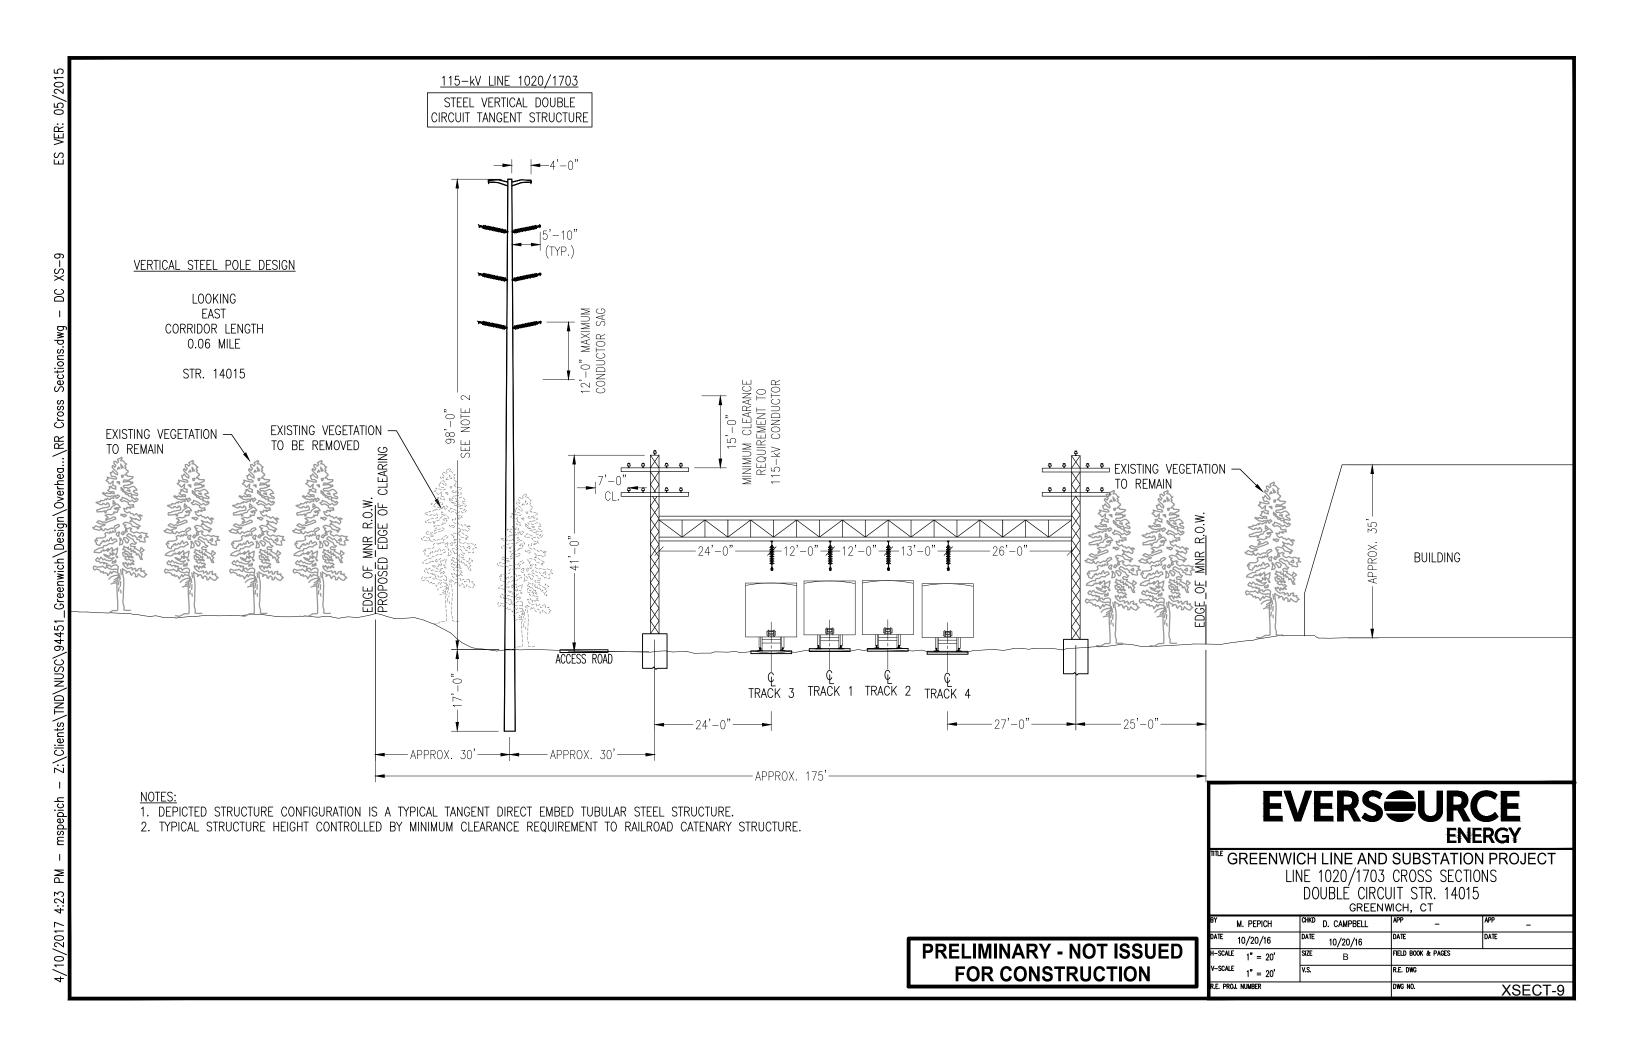

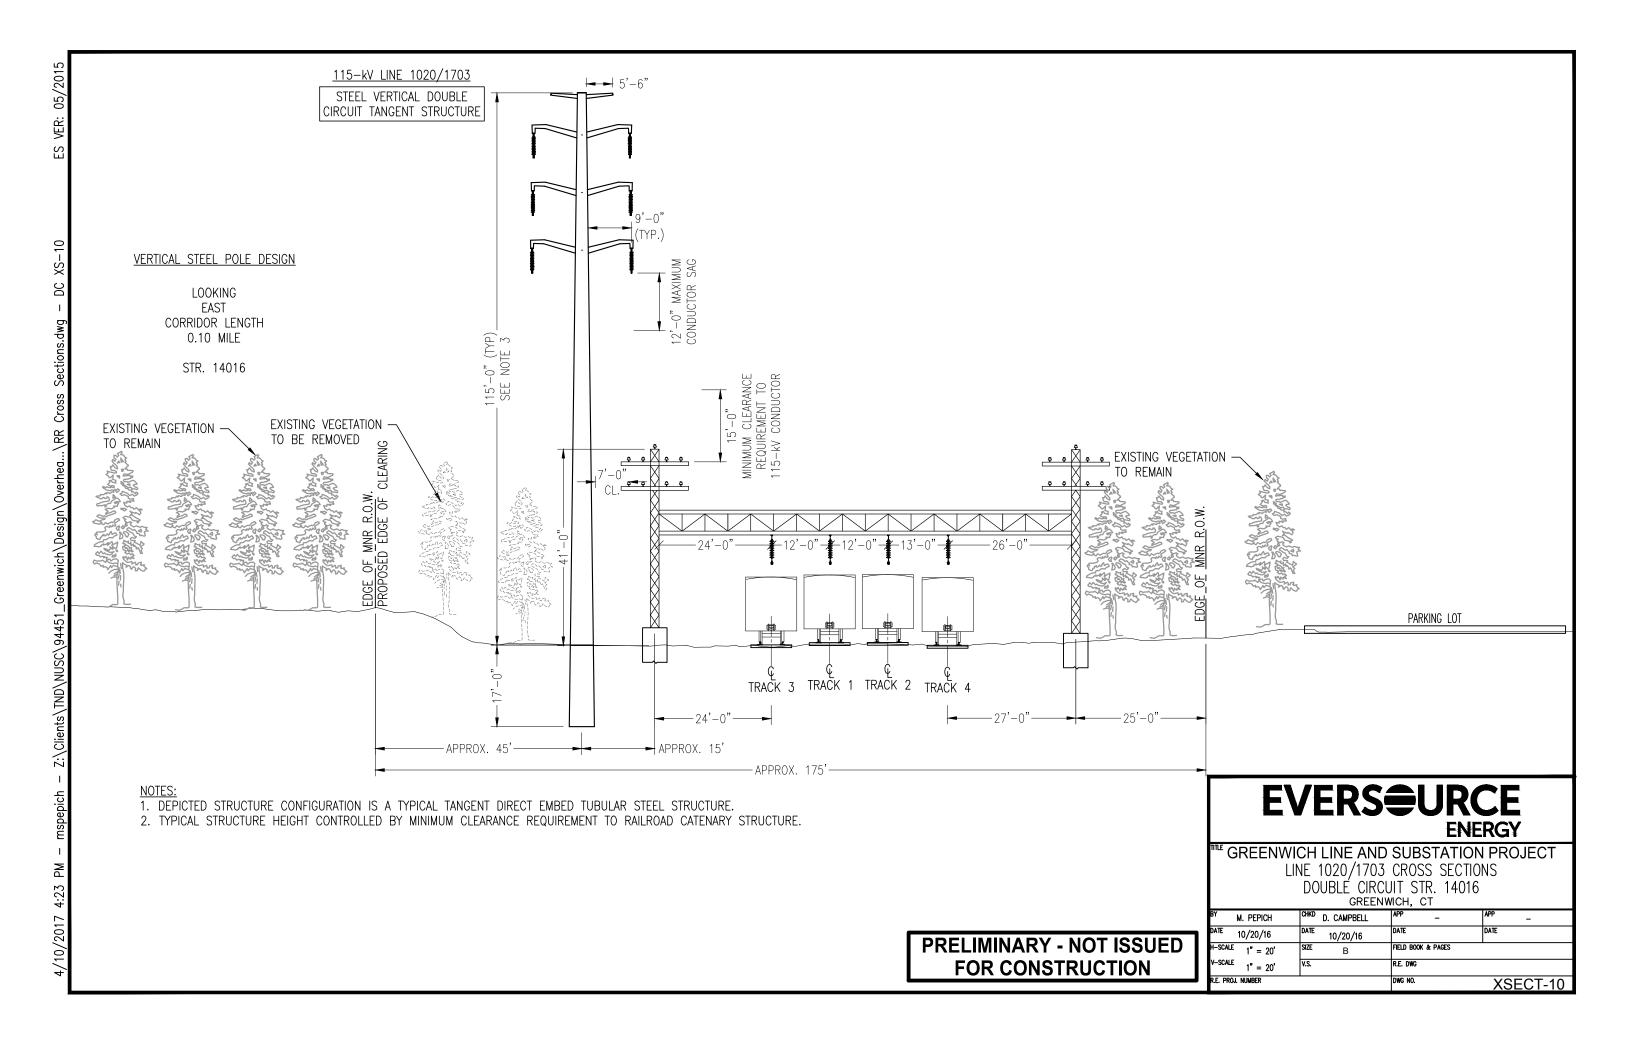

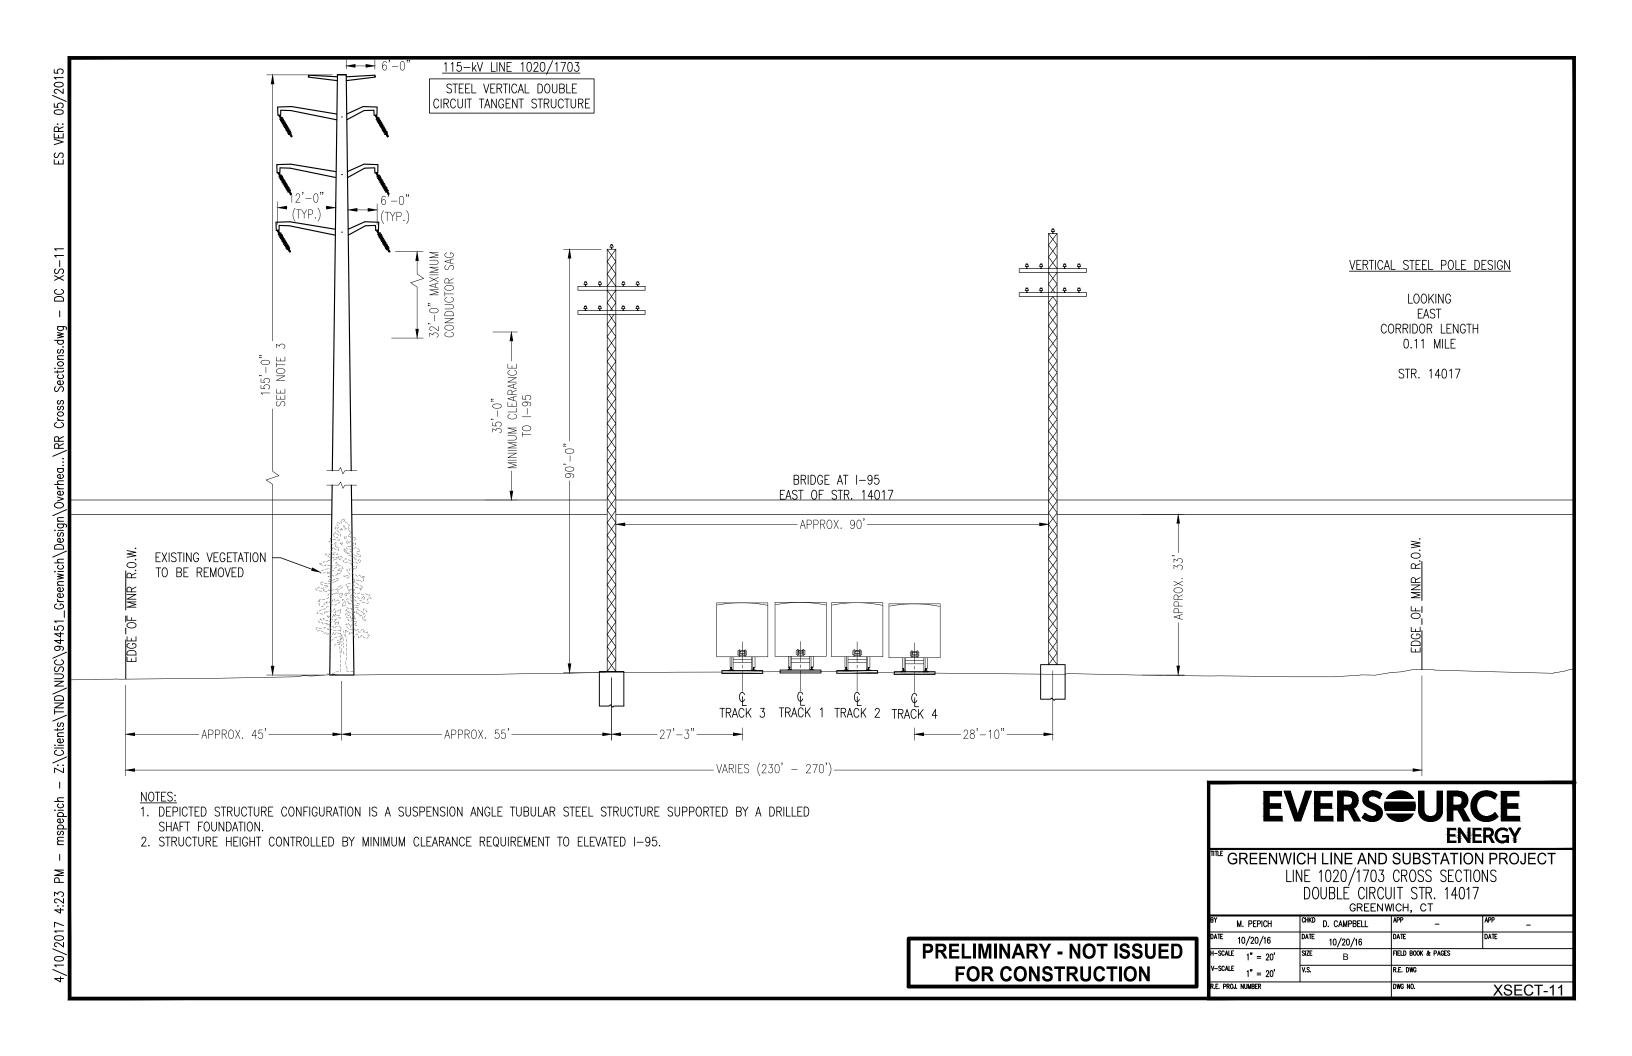

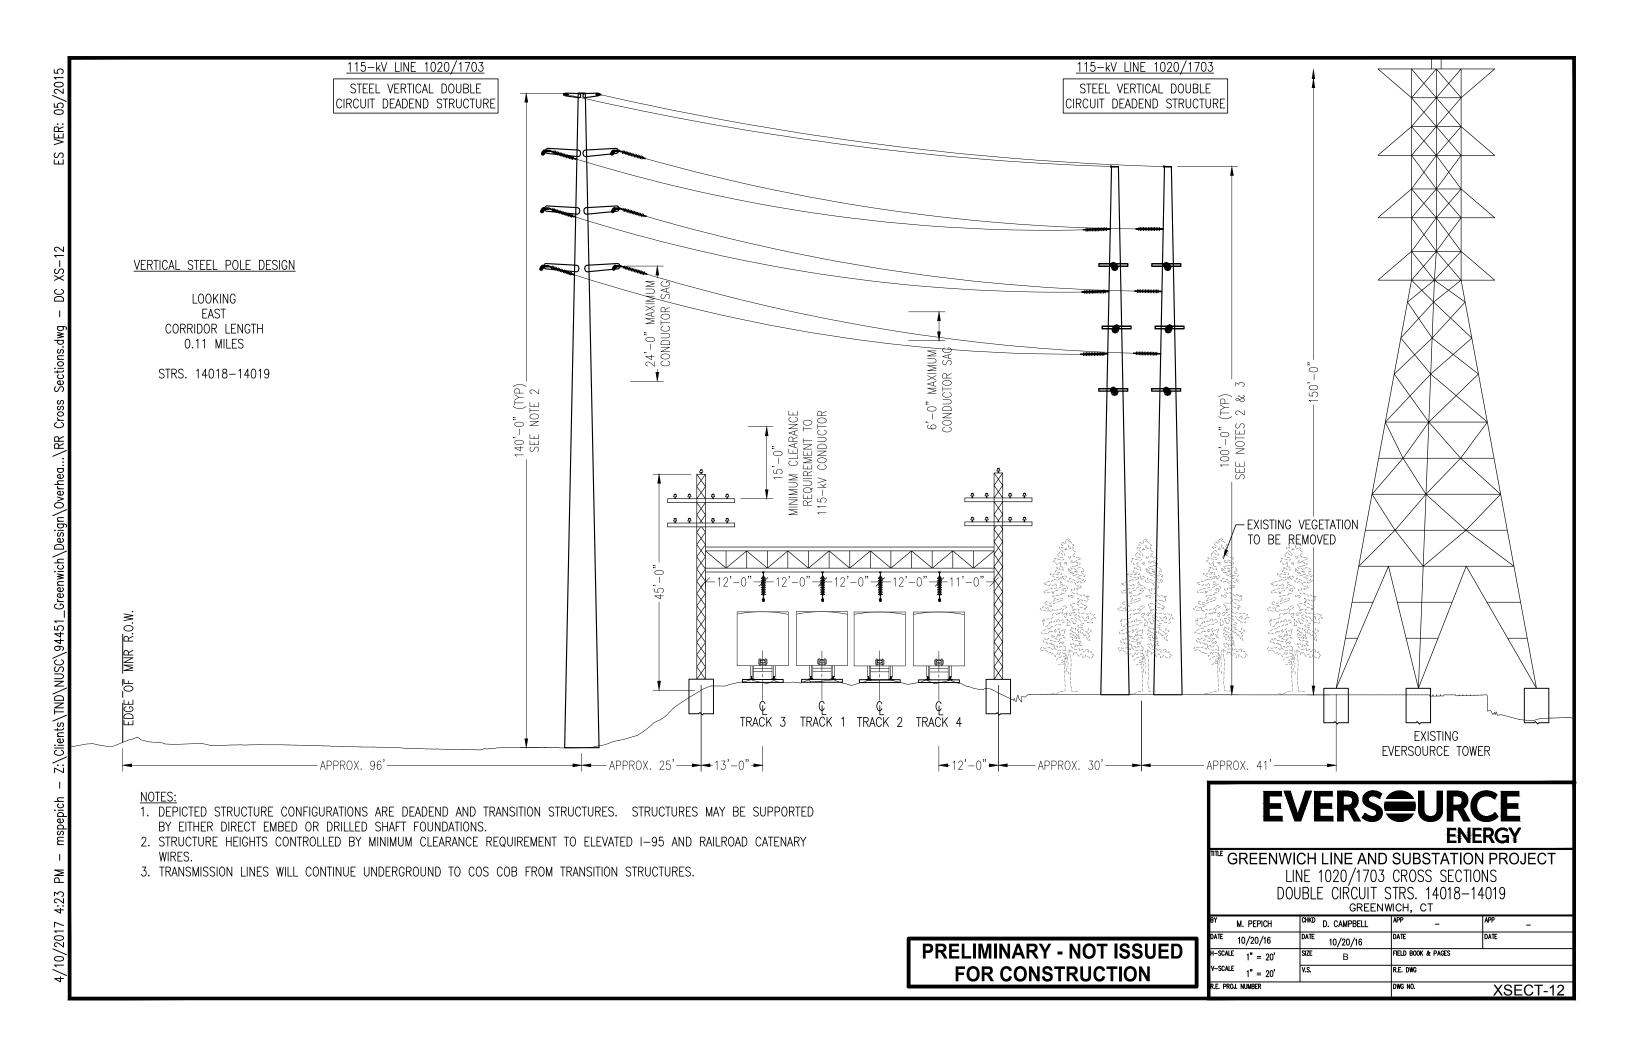

"FOR CURRENT EVERSOURCE PROPERTY RIGHTS REFER TO PROPERTY RECORD MAPPING - LOCATED IN TRANSMISSION SURVEY ENGINEERING/ROW DEPARTMENT"

1. UNDERGROUND UTILITY, STRUCTURE AND FACILITY LOCATIONS DEPICTED AND NOTED HEREON HAVE BEEN COMPILED, IN PART, FROM RECORD MAPPING SUPPLIED BY THE RESPECTIVE UTILITY COMPANIES OR GOVERNMENTAL AGENCIES, FROM PAROL TESTIMONY AND FROM OTHER SOURCES. THESE LOCATIONS MUST BE CONSIDERED AS APPROXIMATE IN NATURE. ADDITIONALLY, OTHER SUCH FEATURES MAY EXIST ON THE SITE, THE EXISTENCE OF WHICH ARE UNKNOWN TO EVERSOURCE ENERGY. THE SIZE, LOCATION AND EXISTENCE OF ALL SUCH FEATURES MUST BE FIELD DETERMINED AND VERIFIED BY THE APPROPRIATE AUTHORITIES PRIOR TO CONSTRUCTION. CALL BEFORE YOU DIG: 1.800.922.4455.





									_	•			ENERG	
								TITLE			& 1703 CO			
										_	NDERGROUN I PROFILE			
								GREENWICH, CONNECTICUT						
-								BY	GM	CHKD	AS	APP	LH	APP
				-				DATE	4/27/16	DATE	4/27/16	DATE	4/27/16	DATE
								H-SCALE	1" = 30"	SIZE	D	FIELD BC	OOK & PAGES	
	-	_	-	-	-	_	_	V-SCALE	1" = 5'	V.S.		R.E. DWG	;	
	NO.	DATE	AS BUILT REVISIONS	BY	CHK	APP	APP	R.E. PRO	J. NUMBER			NUSC0	01157	-10001PG01
_	NO.	DATE	AS BUILT REVISIONS	BI	CHK	APP	APP	_					01137	- 1000

