### **PROJECT INFORMATION**

SCOPE OF WORK: PHOENIX PARTNERSHIP IS PROPOSING TO INSTALL THE FOLLOWING

IMPROVEMENTS:

PROPOSED FOUNDATION FOR NEW TOWN, T-MOBILE AND

VERIZON WIRELESS EQUIPMENT

PROPOSED MONOPOLE TOWER

PROPOSED FENCED COMPOUND

PROPOSED TOWN ANTENNAS ON TOWER & EQUIPMENT SHELTER ON GROUND PROPOSED T-MOBILE ANTENNAS ON TOWER & EQUIPMENT ON GROUND PROPOSED VERIZON WIRELESS ANTENNAS ON TOWER & EQUIPMENT SHELTER

ON GROUND

SITE ADDRESS:

158 EDISON ROAD TRUMBULL, CT 06611

41° 14' 03.67" N 73° 13' 07.54" W ATITUDE: 41.234353° N LONGITUDE: 73.218761° W

TOWER OWNER:

PHOFNIX PARTNERSHIP 110 WASHINGTON AVENUE NORTH HAVEN, CT 06473

T-MOBILE EQUIPMENT PAD DETAILS

**VERIZON SHELTER FOUNDATION** 

**VERIZON SHELTER ELEVATION DETAILS** 

A-4 SITE SURFACE & EROSION CONTROL DETAILS

TYPE OF SITE: RAW LAND WITH TOWN,T-MOBILE AND VERIZON WIRELESS ANTENNAS

**DRAWING INDEX** 

TOWER HEIGHT: 130'-0"±

T-MOBILE ANTENNA

CENTERLINE HEIGHT: 120'-0"±

VERIZON ANTENNA

CENTERLINE HEIGHT: 110'-0"±

T-1 TITLE SHEET

C-1 COMPOUND PLAN

SITE DETAILS

C-1 SITE PLAN

A-1 ELEVATION

CURRENT USE: POLICE DEPARTMENT

PROPOSED USE: TELECOMMUNICATIONS FACILITY

# Phoenix Partnership

## **SITE NAME: CT5051** SITE NAME: POLICE STATION **EDISON ROAD**

### **DEVELOPMENT &** MANAGEMENT PLAN **DOCKET 421**

### **PROJECT TEAM**

PHOENIX PARTNERSHIP 110 WASHINGTON AVENUE NORTH HAVEN, CT 06473 CITY, STATE, ZIP: CONTACT: PHONE:

(203) 623-3287

ENGINEERING

COMPANY: HUDSON DESIGN GROUP, LLC. ADDRESS: 1600 OSGOOD STREET

BUILDING 20 NORTH, SUITE 3090

CITY, STATE, ZIP: CONTACT: NORTH ANDOVER, MA 01845 DANIEL P. HAMM, PE PHONE: (978) 557-5553 X222

daniel.hamm@hudsondesigngroupllc.com

### Phoenix Partnership

PHOENIX PARTNERSHIP 110 WASHINGTON AVENUE NORTH HAVEN, CT 06473



LICENSED ENGINEER

DATE

### **VICINITY MAP**

# 5 5 5 5

**REV** 



THIS DOCUMENT IS THE CREATION, DESIGN, PROPERTY AND COPYRIGHTED WORK OF PHOENIX PARTNERSHIP. ANY DUPLICATION OR USE WITHOUT EXPRESS WRITTEN CONSENT IS STRICTLY PROHIBITED. DUPLICATION AND USE BY GOVERNMENT AGENCIES FOR THE PURPOSES OF CONDUCTING THEIR LAWFULLY AUTHORIZED REGULATORY AND ADMINISTRATIVE FUNCTIONS IS SPECIFICALLY ALLOWED.

**GENERAL NOTES** 

- THE FACILITY IS AN UNMANNED PRIVATE AND SECURED EQUIPMENT INSTALLATION. IT IS ONLY ACCESSED BY TRAINED TECHNICIANS FOR PERIODIC ROUTINE MAINTENANCE AND THEREFORE DOES NOT REQUIRE ANY WATER OR SANITARY SEWER SERVICE. THE FACILITY IS NOT GOVERNED BY REGULATIONS REQUIRING PUBLIC ACCESS PER ADA REQUIREMENTS
- CONTRACTOR SHALL VERIFY ALL PLANS AND EXISTING DIMENSIONS AND CONDITIONS ON THE JOB SITE AND SHALL IMMEDIATELY NOTIFY THE PHOENIX PARTNERSHIP REPRESENTATIVE IN WRITING OF DISCREPANCIES BEFORE PROCEEDING WITH THE WORK OR BE RESPONSIBLE FOR SAME.

CALL BEFORE YOU DIG





1-800-922-4455 OR DIAL 811

REVISIONS		
5	08/12/15	REVISED PER COMMENTS
4	07/16/15	REVISED PER COMMENTS
3	05/28/15	REVISED PER COMMENTS
2	04/28/15	ISSUED FOR REVIEW
1	03/16/15	ISSUED FOR REVIEW
0	12/08/14	ISSUED FOR REVIEW
REV. #	DATE	DESCRIPTION

ROJECT NO.	DESIGNED BY:	DR	SCALE:	
CT5051	DRAWN BY:	SB	AS	SHOWN
0.000	CHECKED BY:	DPH		

SITE NAME:

CT5051 POLICE STATION **EDISON ROAD** 

SITE ADDRESS:


158 EDISON ROAD TRUMBULL, CT 06611

SHEET TITLE:

TITLE SHEET

SHEET NO:

| \_ 1

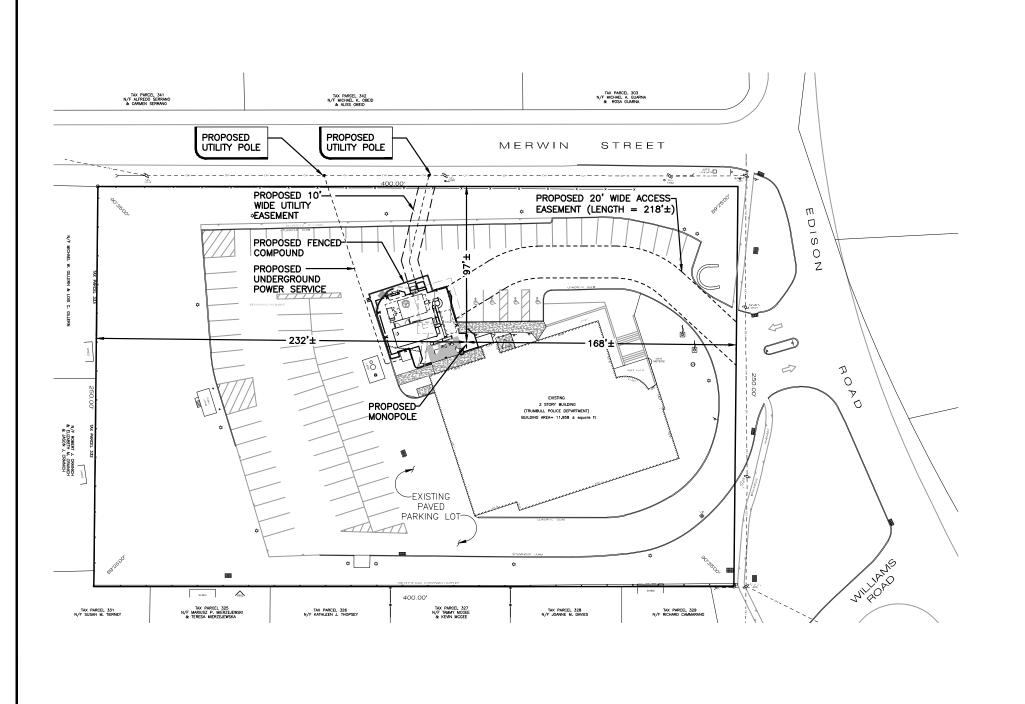

### **GENERAL NOTES:**

CENTER OF PROPOSED MONOPOLE CENTER OF TOWER: LATITUDE: N 41° 14' 03.67"

LONGITUDE: W 73° 13' 07.54"

2. PROPERTY OWNER: TOWN OF TRUMBULL CT 5866 MAIN STREET TRUMBULL, CT 06611

3. SITE NUMBER: CT5051

4. SITE ADDRESS:

158 EDISON ROAD TRUMBULL, CT 06611

PHOENIX PARTNERSHIP 5. APPLICANT: 110 WASHINGTON AVENUE

NORTH HAVEN, CT 06473

E 10, LOT 304 6. TAX MAP: 7. DEED REFERENCE: VOL. 29 PG. 587

8. PLAN REFERENCE: MAP 121

RESIDENCE ZONE A 9. ZONING:

10.ALL UNDERGROUND UTILITY INFORMATION WAS DETERMINED FROM SURFACE INVESTIGATIONS AND EXISTING PLANS OF RECORD. THE CONTRACTOR SHALL LOCATE ALL UNDERGROUND UTILITIES IN THE FIELD PRIOR TO ANY SITE WORK. CALL THE FOLLOWING FOR

ALL PRE-CONSTRUCTION NOTIFICATION 72-HOURS PRIOR TO ANY EXCAVATION ACTIVITY:

DIG SAFE SYSTEM. CALL BEFORE YOU DIG (CT): 1-800-922-4455

11.BEARING SYSTEM OF THIS PLAN IS BASED ON TRUE NORTH. TRUE NORTH WAS ESTABLISHED FROM EXISTING PLAN REFERENCE. IT IS NOT INTENDED TO BE AN EXACT REPRESENTATION OF TRUE NORTH.

12.ACCORDING TO FEDERAL EMERGENCY MANAGEMENT AGENCY MAPS, THE MAJOR IMPROVEMENTS ON THIS PROPERTY ARE LOCATED IN ZONE X

# PLAN SOURCE: ABUTTERS PLAN AND SITE PLAN BY ALL-POINTS TECHNOLOGY P.C. DATED 11/25/09

PROPERTY LINE-SUBJECT PARCEL PROPERTY LINE-ABUTTERS

CONTOURS

DRAINAGE INLET / STRUCTURE CATCH BASIN

SIGN

¢ LIGHT POLE D UTILITY POLE

--UG --- UG-- NEW UNDERGROUND UTILITIES

(BY OTHERS)

### EARTHWORK

3.8 CU YD

4.2 CU YD

APPROXIMATE COLUMN OF

CUT WITHIN COMPOUND:

APPROXIMATE COLUMN OF

FILL WITHIN COMPOUND:

APPROXIMATE # OF TREES

TO BE REMOVED >/=6" DBH:

TOTAL IMPACT AREA OF THE 2,189.4 ± SQ.FT. DISTURBED CONSTRUCTION SITE: OR 0.05 ± ACRE

### Phoenix Partnership

PHOENIX PARTNERSHIP 110 WASHINGTON AVENUE NORTH HAVEN, CT 06473



LICENSED ENGINEER

DATE

REVISIONS		
08/12/15	REVISED PER COMMENTS	
07/16/15	REVISED PER COMMENTS	
05/28/15	REVISED PER COMMENTS	
04/28/15	ISSUED FOR REVIEW	
03/16/15	ISSUED FOR REVIEW	
12/08/14	ISSUED FOR REVIEW	
DATE	DESCRIPTION	
	08/12/15 07/16/15 05/28/15 04/28/15 03/16/15 12/08/14	

DESIGNED BY: DR SCAL DRAWN BY: SB AS SHOWN CHECKED BY: DPH

SITE NAME:

CT5051 POLICE STATION **EDISON ROAD** 

SITE ADDRESS:

158 EDISON ROAD TRUMBULL, CT 06611


SHEET TITLE:


SITE PLAN


SHEET NO:


∖SITE PLAN **=** 



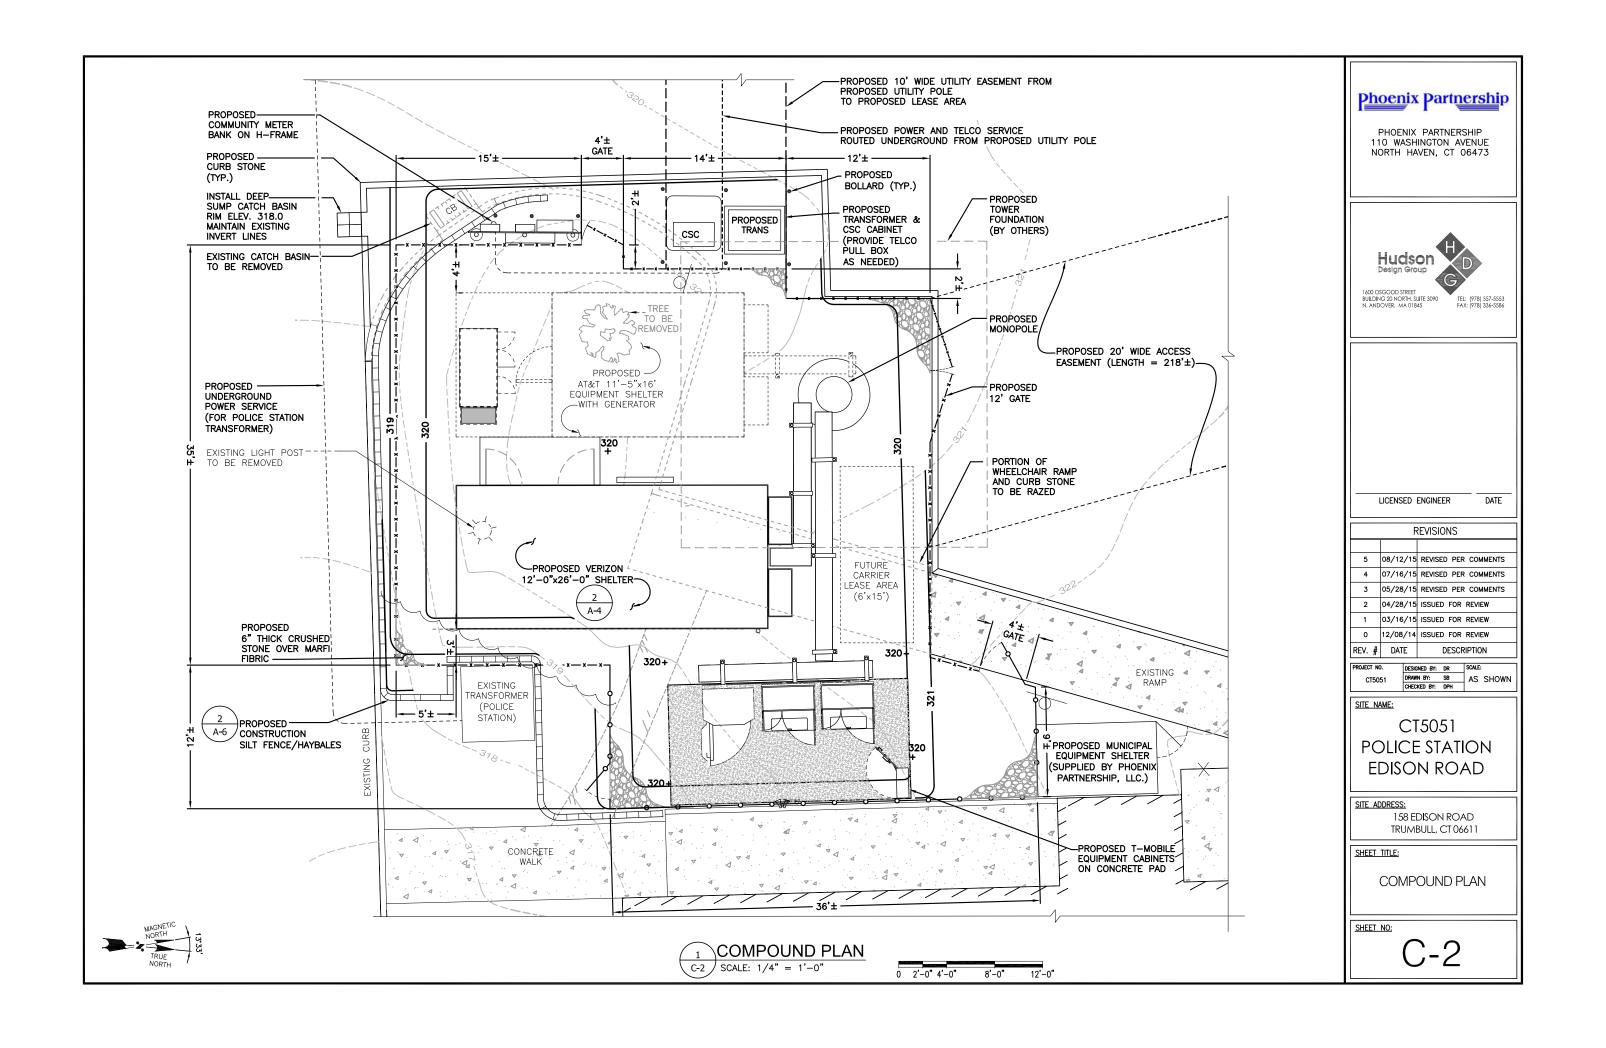

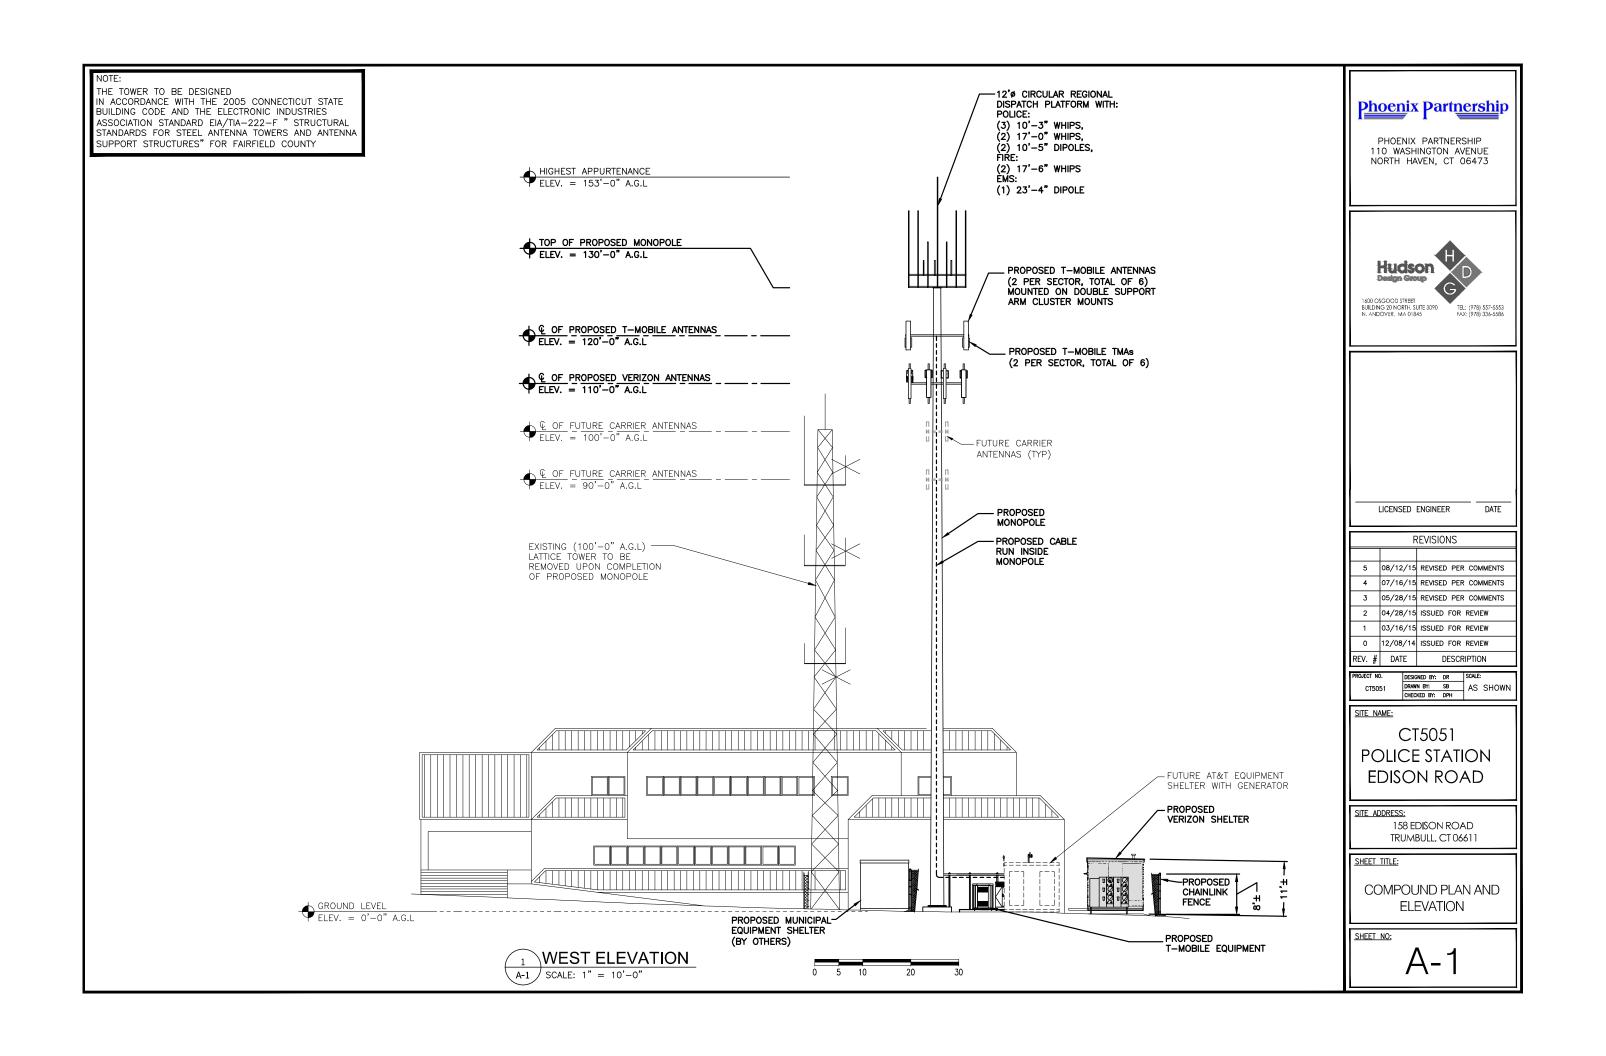

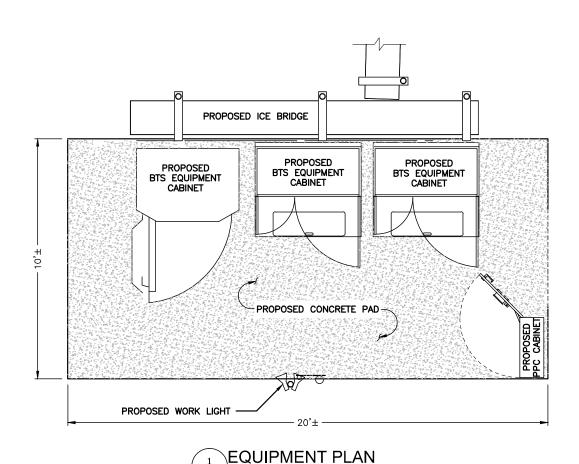

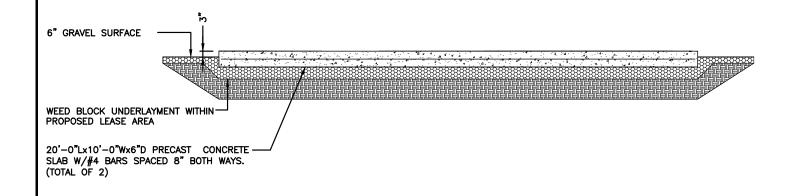

A-2 SCALE: N.T.S.

2 EQUIPMENT CONCRETE PAD DETAIL SCALE: N.T.S.

### Phoenix Partnership

PHOENIX PARTNERSHIP 110 WASHINGTON AVENUE NORTH HAVEN, CT 06473



1600 OSGOOD STREET BUILDING 20 NORTH, SUITE 3090 TEL: {9 N. ANDOVER, MA 01845 FAX: {9

FOUNDATION NOTES & CONCRETE SPECIFICATIONS

- 1. FOUNDATION AREA SHALL BE EXCAVATED TO THE DEPTH AND DIMENSIONS SHOWN ON THE PLANS. EXISTING LEDGE AND ALL OTHER EXISTING UNSUITABLE MATERIAL SHALL BE REMOVED AND LEGALLY DISPOSED OF OFF—SITE. THE SUBGRADE SHALL BE ROLLED WITH A 1—TON, VIBRATORY, WALK—BEHIND ROLLER AT A SPEED OF LESS THAN 2 FPS, 6 PASSES MINIMUM, TO PROVIDE UNYIELDING SURFACE.
- UNDERCUT SOFT OR "WEAVING" AREAS A MINIMUM OF 12 INCHES DEEP. BACKFILL UNDERCUT AREA WITH FILL MEETING THE SPECIFICATIONS OF STRUCTURAL FILL.
- CONCRETE TO HAVE A MINIMUM 28 DAY COMPRESSIVE STRENGTH (f'c)=4000
  psi. CONCRETE TO BE AIR ENTRAINED, DESIRED AIR CONTENT TO BE 6%
  (PLUS OR MINUS 2%)
- 4. REINFORCING BAR TO BE ASTM A615 GRADE 60.
- 5. WELDED WIRE FABRIC TO CONFORM TO THE REQUIREMENTS OF ASTM A185. WIRES FOR FABRIC TO CONFORM TO THE REQUIREMENTS OF ASTM A82.
- 6. COORDINATE WITH MANUFACTURER OF PREFABRICATED SHELTER FOR LOCATION OF ATTACHMENTS TO BASE SLAB.
- 7. ALL REINFORCING TO HAVE MINIMUM CONCRETE COVER PER ACI SPECIFICATIONS.
- 8. ALL CONCRETE MATERIALS AND WORKMANSHIP SHALL CONFORM TO LATEST EDITION OF ACI 318 AND APPLICABLE STATE BUILDING CODE.

LICENSED ENGINEER

DATE

	REVISIONS		
5	08/12/15	REVISED PER COMMENTS	
4	07/16/15	REVISED PER COMMENTS	
3	05/28/15	REVISED PER COMMENTS	
2	04/28/15	ISSUED FOR REVIEW	
1	03/16/15	ISSUED FOR REVIEW	
0	12/08/14	ISSUED FOR REVIEW	
REV. #	DATE	DESCRIPTION	

ROJECT NO.	DESIGNED BY:	DR	SCALE:	
CT5051	DRAWN BY:	SB	AS	SHOWN
	CHECKED BY:	DPH	1	

SITE NAME:

CT5051 POLICE STATION EDISON ROAD

SITE ADDRESS:


158 EDISON ROAD TRUMBULL, CT 06611


SHEET TITLE:


T-MOBILE EQUIPMENT PAD DETAILS


SHEET NO:

A-2

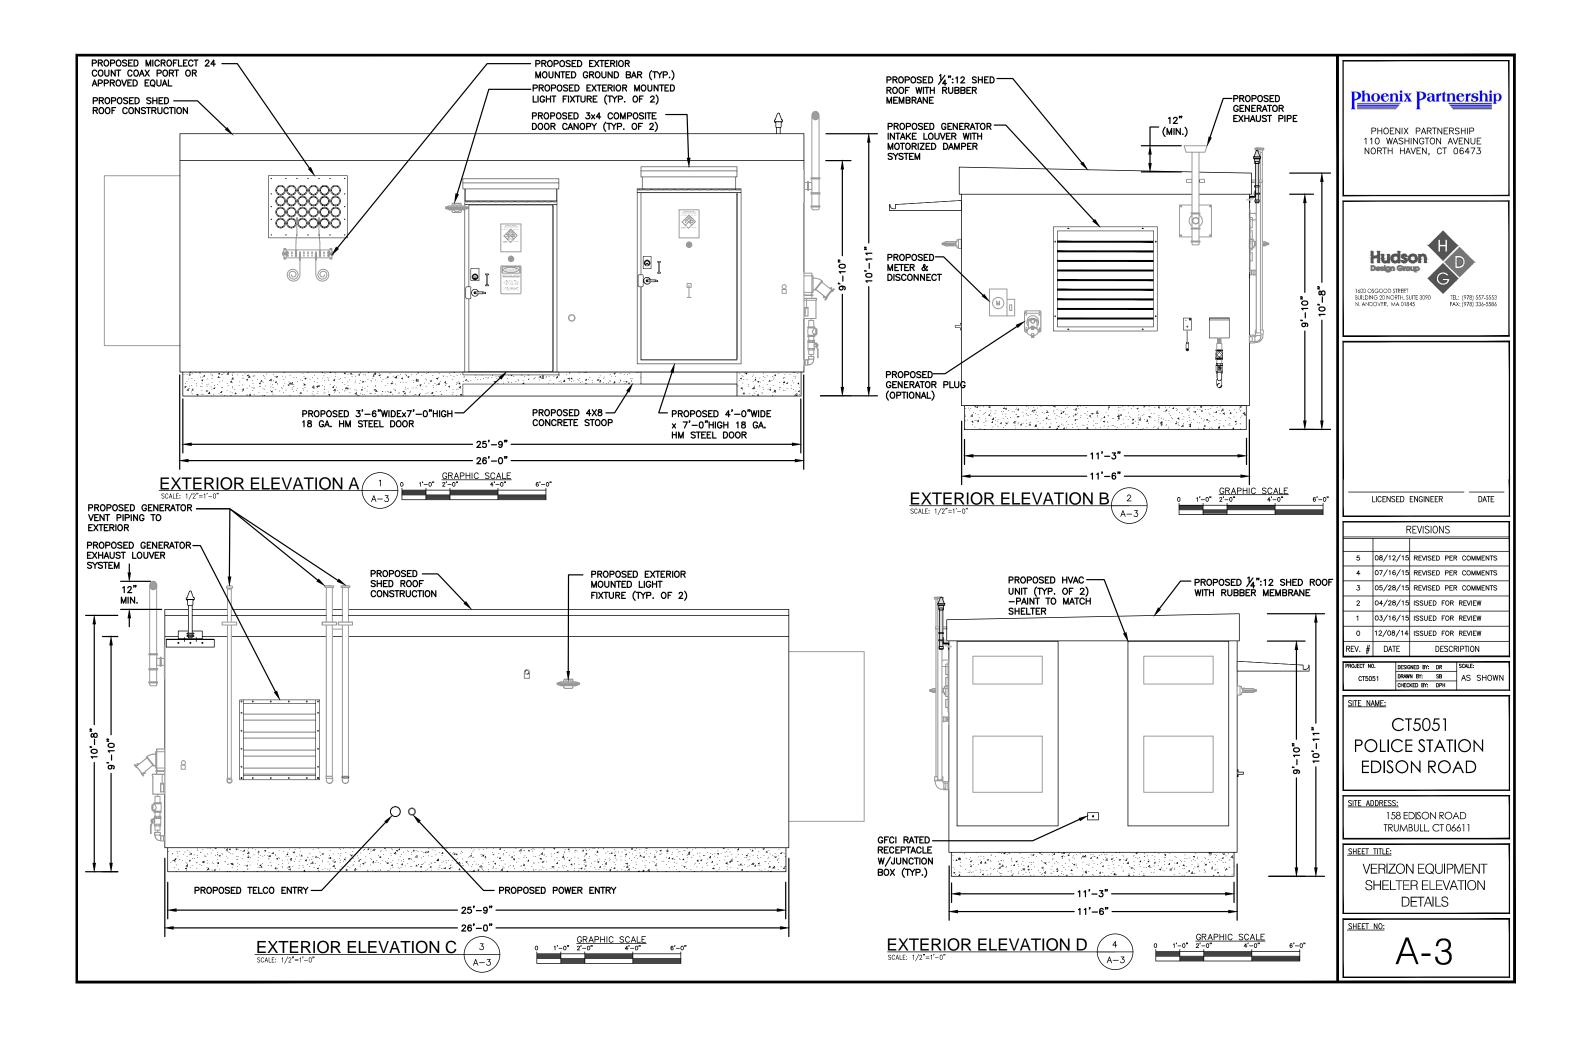

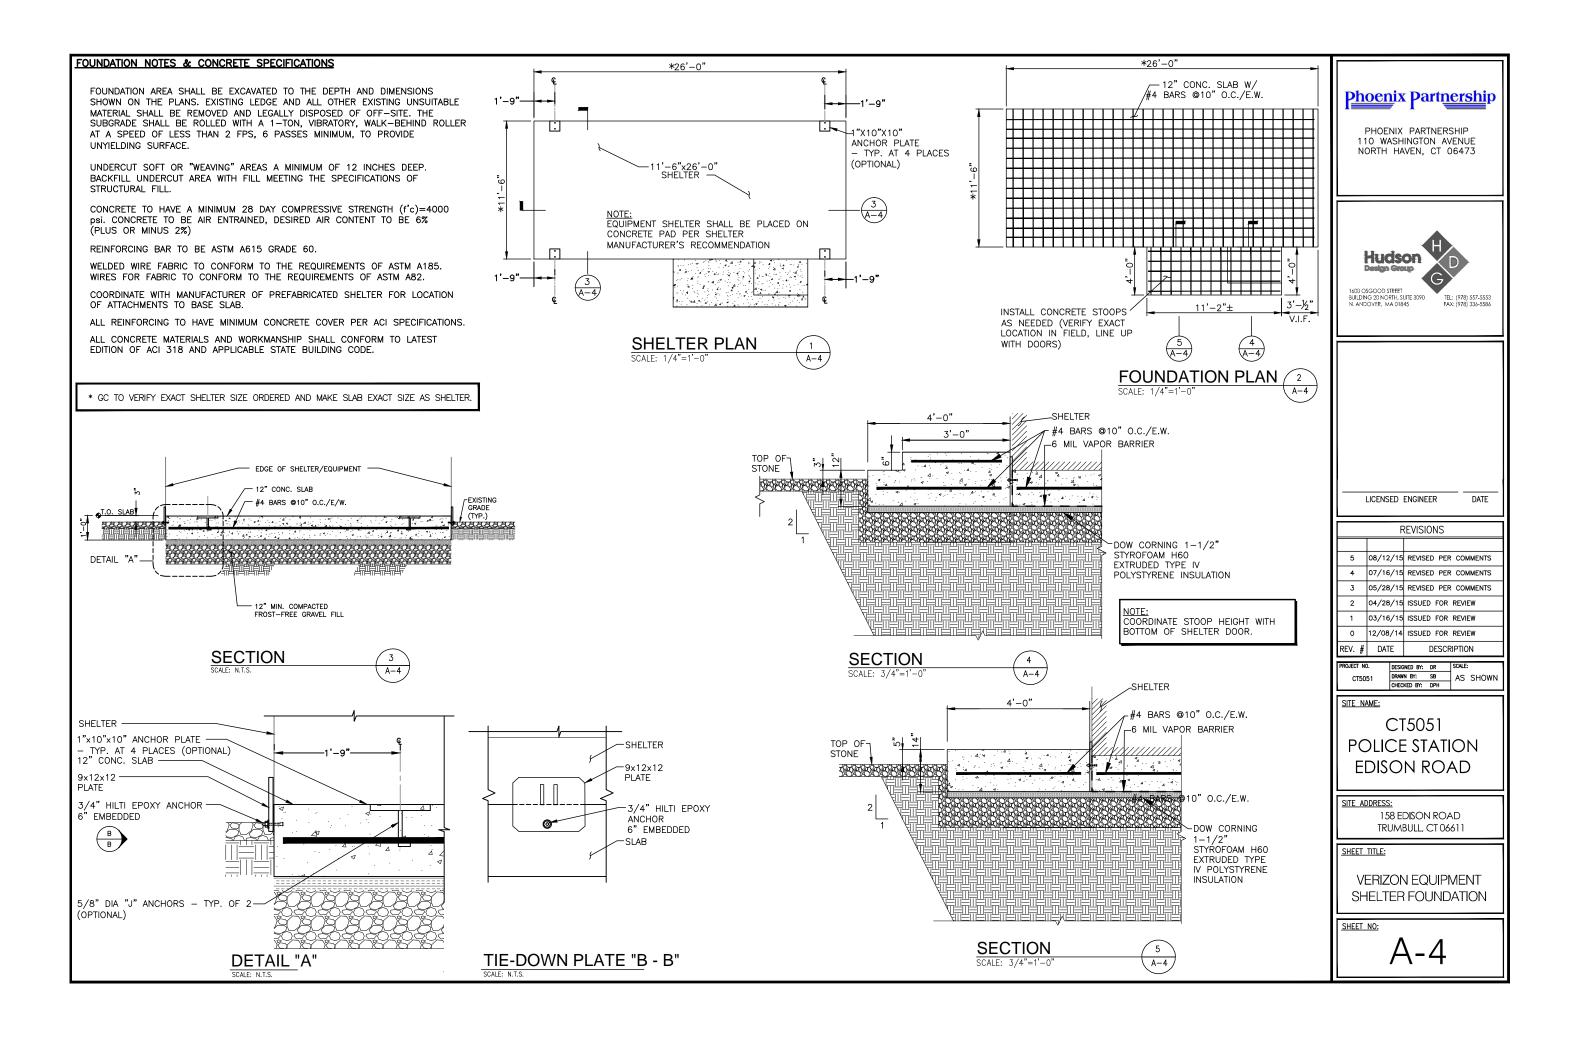


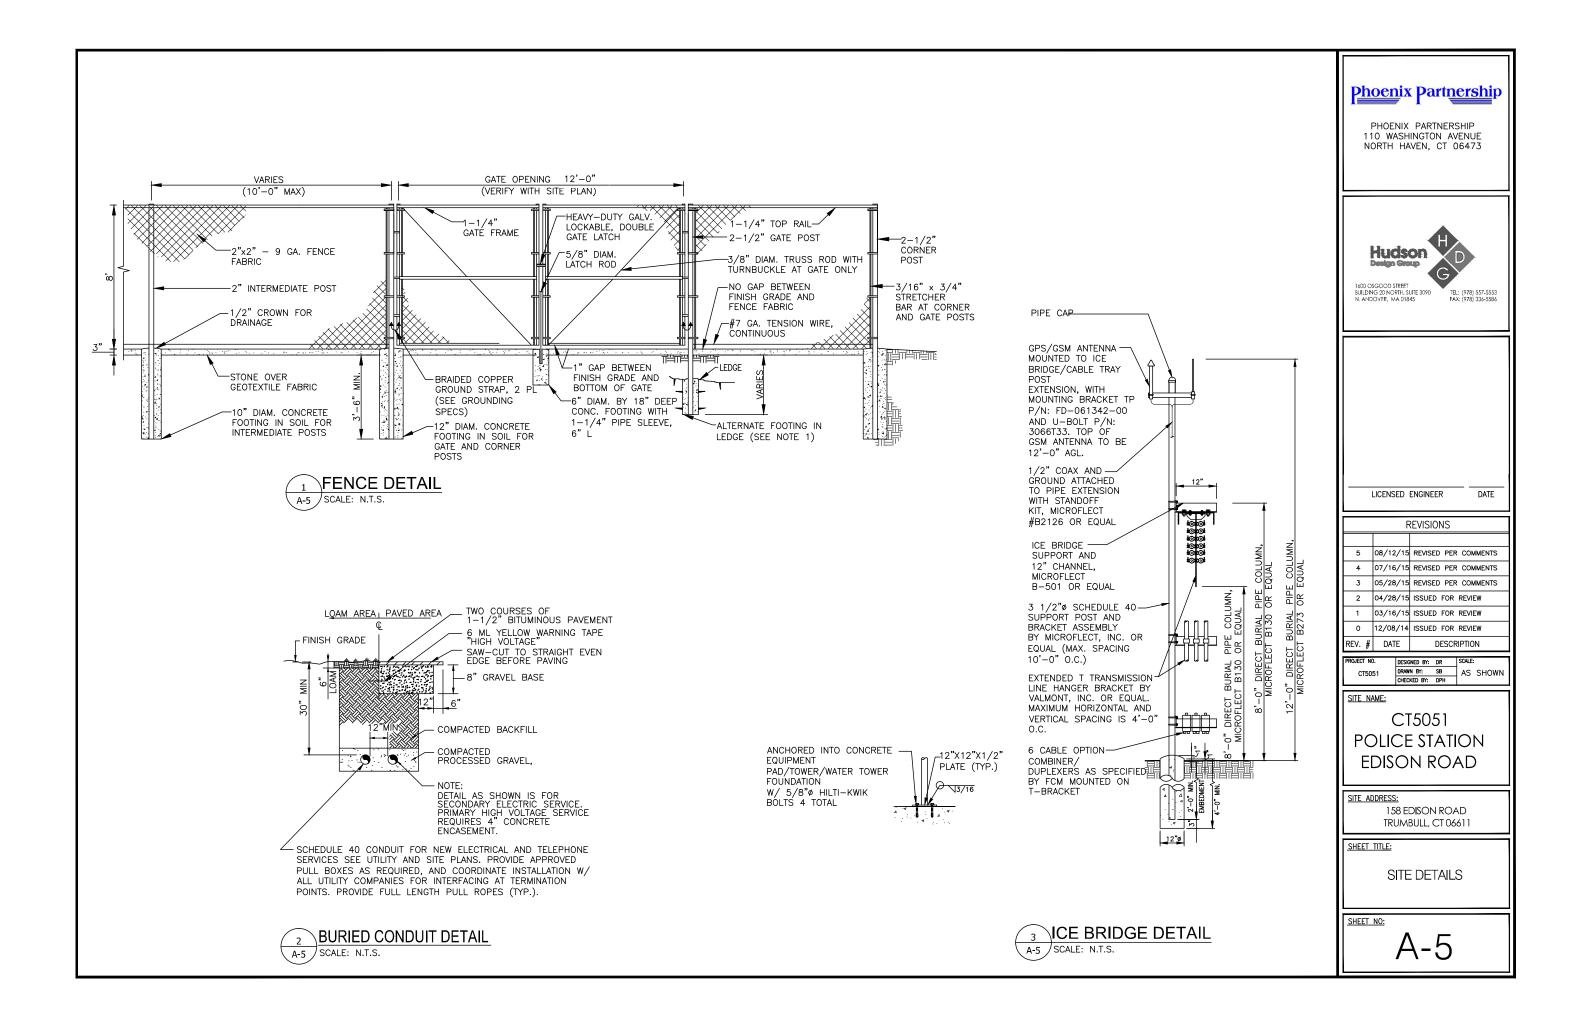

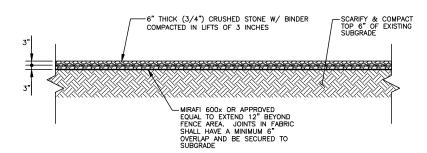





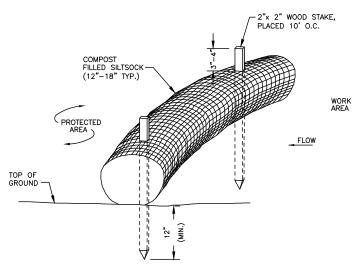


#### NOTES

- 1. SILTSOCK SHALL BE FILTREXX SILTSOXX, OR APPROVED EQUAL.
- COMPOST MATERIAL SHALL BE DISPERSED ON SITE, AS DETERMINED BY THE ENGINEER.
- 3. SILTSOCK SHALL BE INSPECTED PERIODICALLY AND AFTER ALL STORM EVENTS, AND REPAIR OR REPLACEMENT SHALL BE PERFORMED PROMPTLY AS NEEDED.
- 4. SEE SPECIFICATIONS FOR SOCK SIZE, AND COMPOST FILL, REQUIREMENTS.





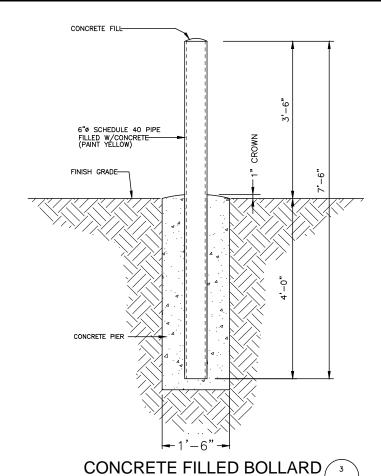

### **GENERAL CONSTRUCTION SEQUENCE:**

THIS IS A GENERAL CONSTRUCTION SEQUENCE OUTLINE SOME ITEMS OF WHICH MAY NOT APPLY TO PARTICULAR SITES.

- 1) CLEAR AND GRUB AREAS OF PROPOSED CONSTRUCTION.
- INSTALL TEMPORARY SEDIMENT AND EROSION CONTROL MEASURES AS REQUIRED.
- 3) REMOVE AND STOCKPILE TOPSOIL. STOCKPILE SHALL BE SEEDED TO PREVENT EROSION.
- 4) CONSTRUCT CLOSED DRAINAGE SYSTEM. PROTECT CULVERT INLETS AND CATCH BASINS WITH SEDIMENTATION BARRIERS.
- 5) CONSTRUCT ROADWAYS AND PERFORM SITE GRADING, PLACING HAY BALES AND SILTATION FENCES AS REQUIRED TO CONTROL SOIL EROSION.
- 6) INSTALL UNDERGROUND UTILITIES.
- 7) BEGIN TEMPORARY AND PERMANENT SEEDING AND MULCHING. ALL CUT AND FILL SLOPES SHALL BE SEEDED OR MULCHED IMMEDIATELY AFTER THEIR CONSTRUCTION. NO AREA SHALL BE LEFT UNSTABILIZED FOR A TIME PERIOD OF MORE THAN 30
- 8) DAILY, OR AS REQUIRED, CONSTRUCT, INSPECT, AND IF NECESSARY, RECONSTRUCT TEMPORARY BERMS, DRAINS, DITCHES, SILT FENCES AND SEDIMENT TRAPS INCLUDING MULCHING AND SEEDING.
- 9) BEGIN EXCAVATION FOR AND CONSTRUCTION OF TOWERS AND PLATFORMS.
- 10) FINISH PAVING ALL ROADWAYS, DRIVES, AND PARKING AREAS.
- 11) COMPLETE PERMANENT SEEDING AND LANDSCAPING.
- 12) NO STORM WATER FLOW SHALL BE DIVERTED TO ANY WETLANDS UNTIL A HEALTHY STAND OF GRASS HAS BEEN ESTABLISHED IN REGRADED AREAS.
- 13) AFTER GRASS HAS BEEN FULLY GERMINATED IN ALL SEEDED AREAS, REMOVE ALL TEMPORARY EROSION CONTROL MEASURES.

### **EROSION CONTROL MEASURES:**

- 1) DISTURBED AREAS SHALL BE KEPT TO THE MINIMUM AREA NECCESSARY TO CONSTRUCT THE ROADWAYS AND ASSOCIATED DRAINAGE FACILITIES.
- HAY BALE BARRIERS AND SEDIMENT TRAPS SHALL BE INSTALLED AS REQUIRED. BARRIERS AND TRAPS ARE TO BE MAINTAINED AND CLEANED UNTIL ALL SLOPES HAVE A HEALTHY STAND OF GRASS.
- 3) BALED HAY AND MULCH SHALL BE MOWINGS OF ACCEPTABLE HERBACEOUS GROWTH, FREE FROM NOXIOUS WEEDS OR WOODY STEMS, AND SHALL BE DRY. NO SALT HAY SHALL BE USED.
- 4) FILL MATERIAL SHALL BE FREE FROM STUMPS, WOOD, ROOTS FTC.
- 5) STOCKPILED MATERIALS SHALL BE PLACED ONLY IN AREAS SHOWN ON THE PLANS. STOCKPILES SHALL BE PROTECTED BY SILTATION FENCE AND SEEDED TO PREVENT EROSION. THESE MEASURES SHALL REMAIN UNTIL ALL MATERIAL HAS BEEN PLACED OR DISPOSED OFF SITE.
- 6) ALL DISTURBED AREAS SHALL BE LOAMED AND SEEDED. A MINIMUM OF 4 INCHES OF LOAM SHALL BE INSTALLED WITH NOT LESS THAN ONE POUND OF SEED PER 50 SQUARE YARDS OF AREA.
- APPLICATION OF GRASS SEED, FERTILIZERS AND MULCH SHALL BE ACCOMPLISED BY BROADCAST SEEDING OR HYDROSEEDING AT THE RATES OUTLINED BELOW:

LIMESTONE:75-100 LBS./1,000 SQUARE FEET.
FERTILIZER:RATE RECOMMENDED BY MANUFACTURER.
MULCH: HAY MULCH APPROXIMATELY 3 TONS/ACRE UNLESS
EROSION CONTROL MATTING I SUSED.

SEED MIX (SLOPES LESS THAN 4:1)	LBS./ACRE
CREEPING RED FESCUE	20
TALL FESCUE	20
REDTOP	2
	42
SLOPE MIX (SLOPES GREATER THAN 4:1)	LBS./ACRE
CREEPING RED FESCUE	20
TALL FESCUE	20
BIRDSFOOT TREEFOIL	_8_
	48

### TREATMENT SWALE PLANTING SPECIFICATIONS

TALL FESCUE 20 LBS/ACRE 0R 0.45 LBS/10,000 SF CREEPING RED FESCUE 20 LBS/ACRE 0R 0.45 LBS/10,000 SF BIRDSFOOT TREFOIL 8 LBS/ACRE 0R 0.20 LBS/10,000 SF

LIME AND FERTILIZER SHOULD BE APPLIED PRIOR TO OR AT TIME OF SEEDING AND INCORPORATED INTO THE SOIL. THE FOLLOWING RATES ARE RECOMMENDED:

AGRICULTURAL LIMESTONE 2 TONS/ACRE OR 100 LBS/1,000 SF NITROGEN (N) 50 LBS/ACRE OR 1.1 LBS/10,000 SF POTASH (K20) 100 LBS/ACRE OR 2.2 LBS/10,000 SF (THIS IS EQUIVALENT TO 500 LBS/ACRE OF 10–20–20 FERTILIZER OR 1,000 LBS/ACRE OF 10–20–20 FERTILIZER OR 1,000 LBS/ACRE OF 10–20–20 FERTILIZER OR 1,000 LBS/ACRE OF 5–10–10).

- 8) AFTER ALL DISTURBED AREAS HAVE BEEN STABILIZED THE TEMPORARY EROSION CONTROL MEASURES ARE TO BE REMOVED.
- 9) PAVED ROADWAYS MUST BE KEPT CLEAN AT ALL TIMES.
- 10) ALL CATCH BASIN INLETS WILL BE PROTECTED WITH LOW POINT SEDIMENTATION BARRIER.
- 11) ALL STORM DRAINAGE OUTLETS WILL BE STABILIZE AND CLEANED AS REQUIRED, BEFORE THE DISCHARGE POINTS BECOME OPERATIONAL.
- 12) ALL DEWATERING OPERATIONS MUST DISCHARGE DIRECTLY INTO A SEDIMENT FILTER AREA.
- 13) NO DISCHARGE SHALL BE DIRECTED TOWARDS ANY PROPOSED DITCHES, SWALES, OR PONDS UNTIL THEY HAVE BEEN PROPERLY STABILIZED.

### Phoenix Partnership

PHOENIX PARTNERSHIP 110 WASHINGTON AVENUE NORTH HAVEN, CT 06473



FAX: (978) 336-55

DATE

LICENSED ENGINEER

REVISIONS

5 08/12/15 REVISED PER COMMENTS

4 07/16/15 REVISED PER COMMENTS

3 05/28/15 REVISED PER COMMENTS

2 04/28/15 ISSUED FOR REVIEW

1 03/16/15 ISSUED FOR REVIEW

0 12/08/14 ISSUED FOR REVIEW

REV. # DATE DESCRIPTION

PROJECT NO. | DESIGNED BY: DR | SCALE: | SCALE:

SITE NAME:

CT5051 POLICE STATION EDISON ROAD

SITE ADDRESS:

158 EDISON ROAD TRUMBULL, CT 06611

SHEET TITLE:

SITE SURFACE & EROSION CONTROL DETAILS

SHEET NO:

A-6