#### PROJECT INFORMATION

SCOPE OF WORK:

PHOENIX PARTNERSHIP IS PROPOSING TO INSTALL THE FOLLOWING

IMPROVEMENTS:

PROPOSED FOUNDATION FOR NEW TOWN, T-MOBILE EQUIPMENT AND

VERIZON WIRELESS

PROPOSED MONOPOLE TOWER PROPOSED FENCED COMPOUND

PROPOSED TOWN ANTENNAS ON TOWER & EQUIPMENT SHELTER ON GROUND PROPOSED T-MOBILE ANTENNAS ON TOWER & EQUIPMENT ON GROUND PROPOSED VERIZON WIRELESS ANTENNAS ON TOWER & EQUIPMENT SHELTER

158 EDISON ROAD TRUMBULL, CT 06611 SITE ADDRESS:

LATITUDE: 41.234353° N 41° 14' 03.67" N 73° 13' 07.54" W LONGITUDE: 73.218761° W

TOWER OWNER:

PHOFNIX PARTNERSHIP 110 WASHINGTON AVENUE NORTH HAVEN, CT 06473

TYPE OF SITE: RAW LAND WITH TOWN,T-MOBILE AND VERIZON WIRELESS ANTENNAS

**DRAWING INDEX** 

TOWER HEIGHT: 130'-0"±

T-MOBILE ANTENNA

CENTERLINE HEIGHT: 120'-0"±

T-1 TITLE SHEET

C-1 COMPOUND PLAN

C-1 SITE PLAN

A-1 ELEVATION

A-5 SITE DETAILS

VERIZON ANTENNA CENTERLINE HEIGHT: 110'-0"±

POLICE DEPARTMENT CURRENT USE:

PROPOSED USE: TELECOMMUNICATIONS FACILITY

# Phoenix Partnership

# **SITE NAME: CT5051** SITE NAME: POLICE STATION **EDISON ROAD**

# **DEVELOPMENT &** MANAGEMENT PLAN **DOCKET 421**

### **PROJECT TEAM**

CITY, STATE, ZIP:

PHOENIX PARTNERSHIP 110 WASHINGTON AVENUE NORTH HAVEN, CT 06473 KEITH COPPINS (203) 623-3287

**ENGINEERING** 

COMPANY:

CONTACT:

PHONE:

CITY, STATE, ZIP:


HUDSON DESIGN GROUP, LLC. ADDRESS: 1600 OSGOOD STREET BUILDING 20 NORTH, SUITE 3090 NORTH ANDOVER, MA 01845 DANIEL P. HAMM. PE (978) 557-5553 X222

daniél.hamm@hudsondesigngroupllc.com

# Phoenix Partnership

PHOENIX PARTNERSHIP 110 WASHINGTON AVENUE NORTH HAVEN, CT 06473



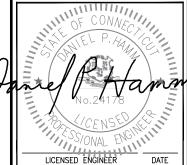

### **VICINITY MAP**

# 3 3 3 A-2 T-MOBILE EQUIPMENT PAD DETAILS **VERIZON SHELTER ELEVATION DETAILS VERIZON SHELTER FOUNDATION** 3 3 A-4 SITE SURFACE & EROSION CONTROL DETAILS

**REV** 



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**GENERAL NOTES** 

THE FACILITY IS AN UNMANNED PRIVATE AND SECURED EQUIPMENT INSTALLATION, IT IS ONLY ACCESSED BY TRAINED TECHNICIANS FOR REQUIRE ANY WATER OR SANITARY SEWER SERVICE. THE FACILITY IS NOT GOVERNED BY REGULATIONS REQUIRING PUBLIC ACCESS PER ADA REQUIREMENTS.

OF CONDUCTING THEIR LAWFULLY AUTHORIZED REGULATORY AND ADMINISTRATIVE FUNCTIONS IS SPECIFICALLY ALLOWED.

CONTRACTOR SHALL VERIFY ALL PLANS AND EXISTING DIMENSIONS AND CONDITIONS ON THE JOB SITE AND SHALL IMMEDIATELY NOTIFY THE PHOENIX PARTNERSHIP REPRESENTATIVE IN WRITING OF DISCREPANCIES BEFORE PROCEEDING WITH THE WORK OR BE RESPONSIBLE FOR SAME.

CALL BEFORE YOU DIG





1-800-922-4455 OR DIAL 811

		REVISIONS			
	-				
S					
	3	05/28/15	REVISED PER COMMENTS		
	2	04/28/15	ISSUED FOR REVIEW		
	1	03/16/15	ISSUED FOR REVIEW		
	0	12/08/14	ISSUED FOR REVIEW		
	REV. #	DATE	DESCRIPTION		
	1				

PROJECT NO.	DESIGNED BY:	DR	SCALE:	
CT5051	DRAWN BY:	SZB	AS	SHOWN
	CHECKED BY:	DPH	1	

SITE NAME:

CT5051 **POLICE STATION EDISON ROAD** 

SITE ADDRESS:


158 EDISON ROAD TRUMBULL, CT 06611

SHEET TITLE:

TITLE SHEET

SHEET NO:

T-1

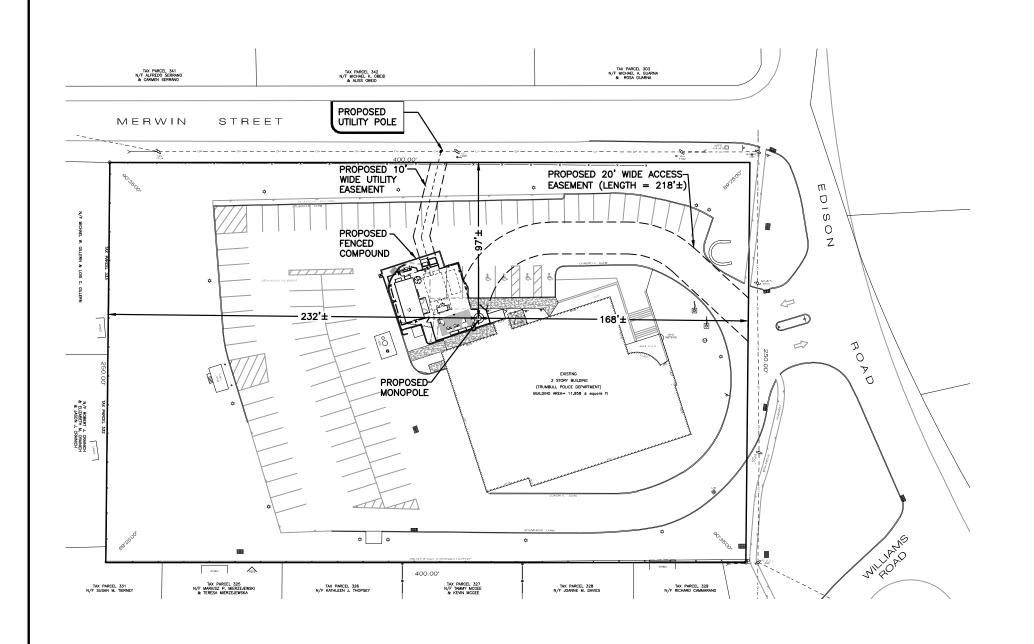

# **GENERAL NOTES:**

CENTER OF PROPOSED MONOPOLE CENTER OF TOWER: LATITUDE: N 41° 14' 03.67"

LONGITUDE: W 73° 13' 07.54"

2. PROPERTY OWNER: TOWN OF TRUMBULL CT 5866 MAIN STREET

TRUMBULL, CT 06611

3. SITE NUMBER: CT5051

158 EDISON ROAD 4. SITE ADDRESS:

TRUMBULL, CT 06611

PHOENIX PARTNERSHIP . APPLICANT: 110 WASHINGTON AVENUE NORTH HAVEN, CT 06473

E 10, LOT 304 S. TAX MAP:

. DEED REFERENCE: VOL. 29 PG. 587

8. PLAN REFERENCE: MAP 121 RESIDENCE ZONE A 9. ZONING:

10.ALL UNDERGROUND UTILITY INFORMATION WAS DETERMINED FROM SURFACE INVESTIGATIONS AND EXISTING PLANS OF RECORD. THE CONTRACTOR SHALL LOCATE ALL UNDERGROUND UTILITIES IN THE FIELD PRIOR TO ANY SITE WORK. CALL THE FOLLOWING FOR ALL PRE-CONSTRUCTION NOTIFICATION 72-HOURS PRIO

TO ANY EXCAVATION ACTIVITY: DIG SAFE SYSTEM. CALL BEFORE YOU DIG

(CT): 1-800-922-4455

1.BEARING SYSTEM OF THIS PLAN IS BASED ON TRUE NORTH. TRUE NORTH WAS ESTABLISHED FROM EXISTING PLAN REFERENCE. IT IS NOT INTENDED TO BE AN EXACT REPRESENTATION OF TRUE NORTH.

2.ACCORDING TO FEDERAL EMERGENCY MANAGEMENT AGENCY MAPS, THE MAJOR IMPROVEMENTS ON THIS PROPERTY ARE LOCATED IN ZONE X

PLAN SOURCE: ABUTTERS PLAN AND SITE PLAN BY ALL-POINTS TECHNOLOGY P.C. DATED 11/25/09

#### LEGEND

PROPERTY LINE-SUBJECT PARCEL PROPERTY LINE-ABUTTERS

CONTOURS

DRAINAGE INLET / STRUCTURE 

CATCH BASIN

SIGN

 $\dot{\alpha}$ LIGHT POLE

D UTILITY POLE NEW UNDERGROUND UTILITIES --UG --- UG--

(BY OTHERS)

### EARTHWORK

APPROXIMATE COLUMN OF

3.8 CU YD CUT WITHIN COMPOUND:

APPROXIMATE COLUMN OF

FILL WITHIN COMPOUND: 4.2 CU YD

APPROXIMATE # OF TREES

TO BE REMOVËD >/=6" DBH:

TOTAL IMPACT AREA OF THE 2,189.4 ± SQ.FT. DISTURBED CONSTRUCTION SITE: OR 0.05 ± ACRE

# Phoenix Partnership

PHOENIX PARTNERSHIP 110 WASHINGTON AVENUE NORTH HAVEN, CT 06473





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CT5051	DRAWN BY:	SZB	AS SHOWN
0.0001	CHECKED BY:	DPH	1

SITE NAME:

CT5051 **POLICE STATION EDISON ROAD** 

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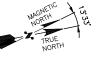
158 EDISON ROAD TRUMBULL, CT 06611


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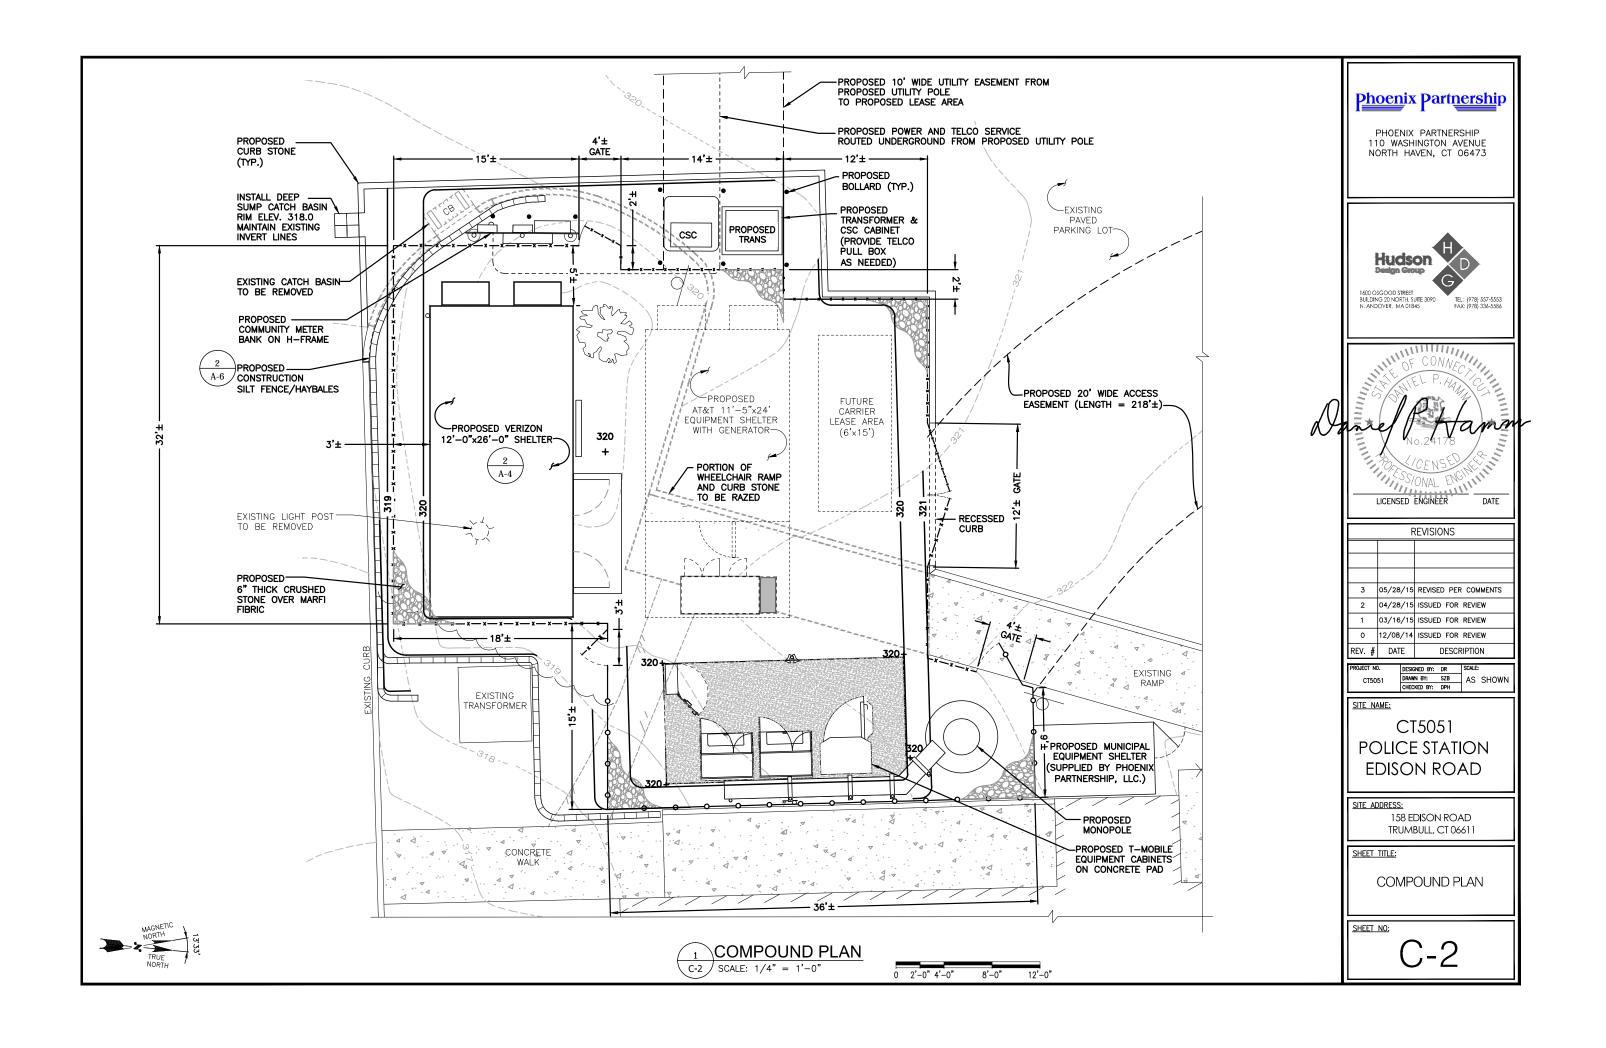
SITE PLAN


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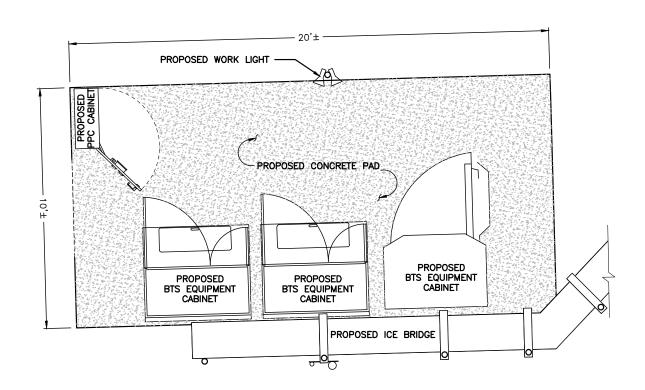
C-1








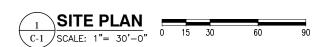

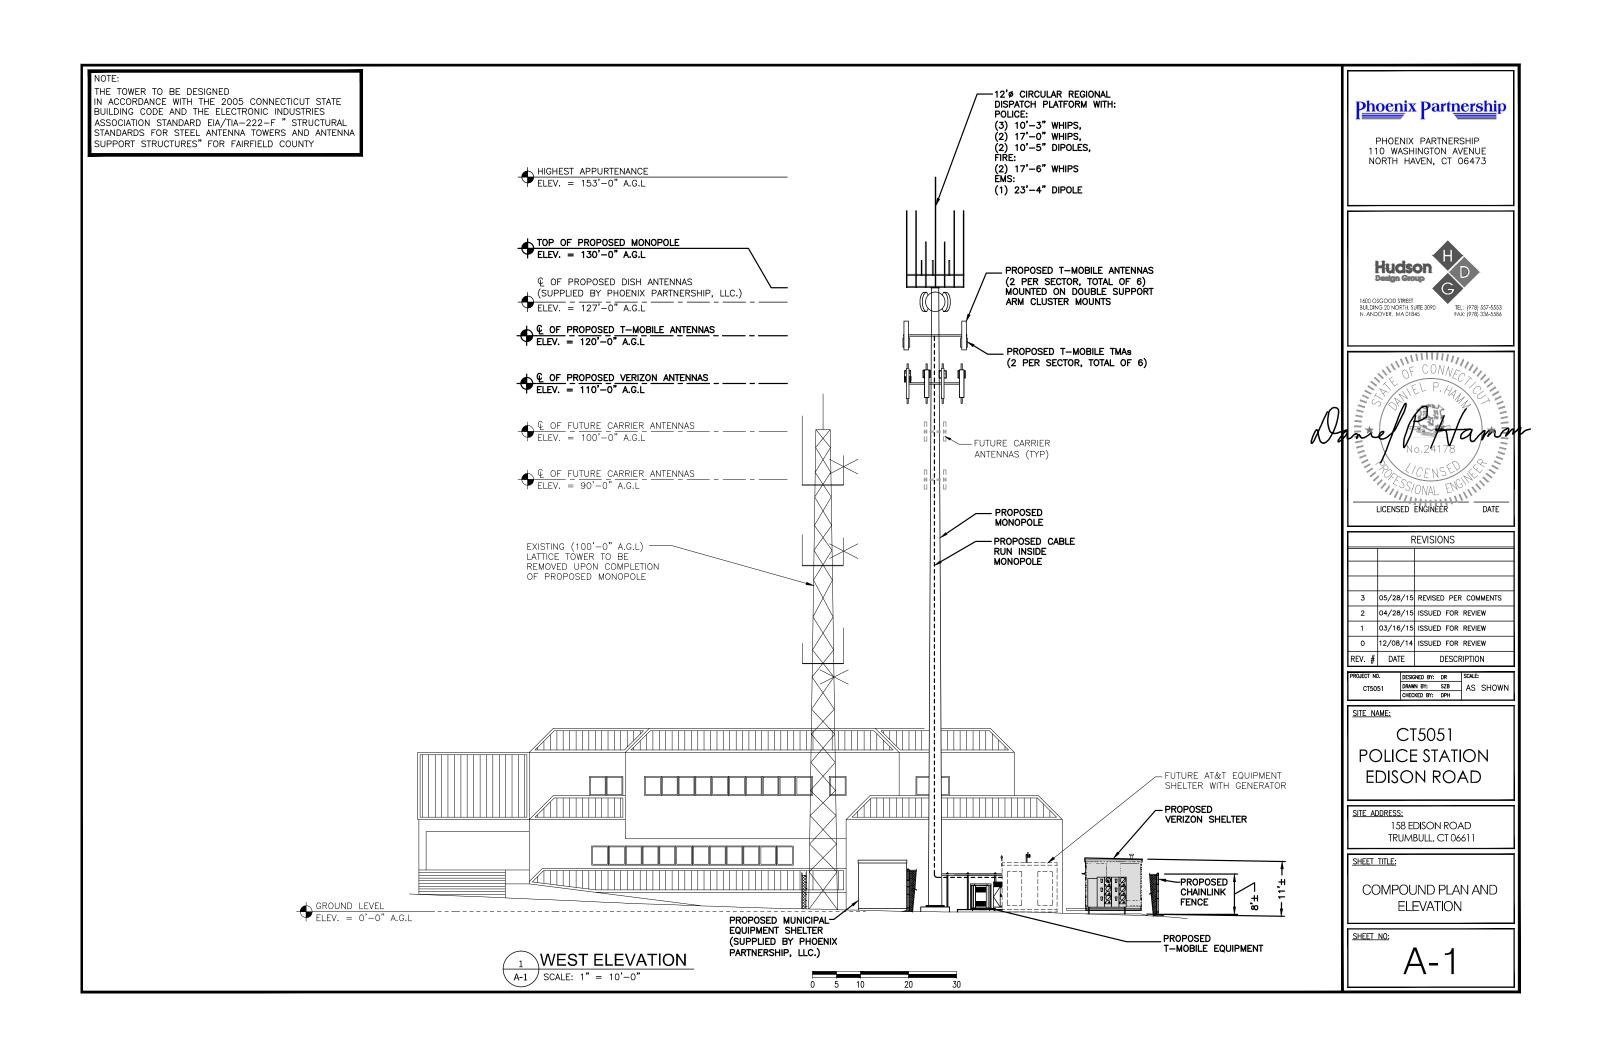



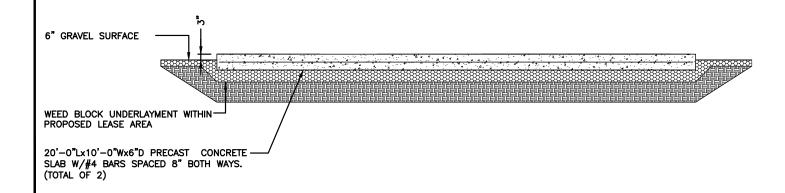


# 2 EQUIPMENT CONCRETE PAD DETAIL A-2 SCALE: N.T.S.

# Phoenix Partnership

PHOENIX PARTNERSHIP 110 WASHINGTON AVENUE NORTH HAVEN, CT 06473



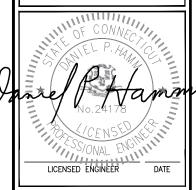

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SITE ADDRESS:

158 EDISON ROAD TRUMBULL, CT 06611

SHEET TITLE:


T-MOBILE EQUIPMENT PAD DETAILS


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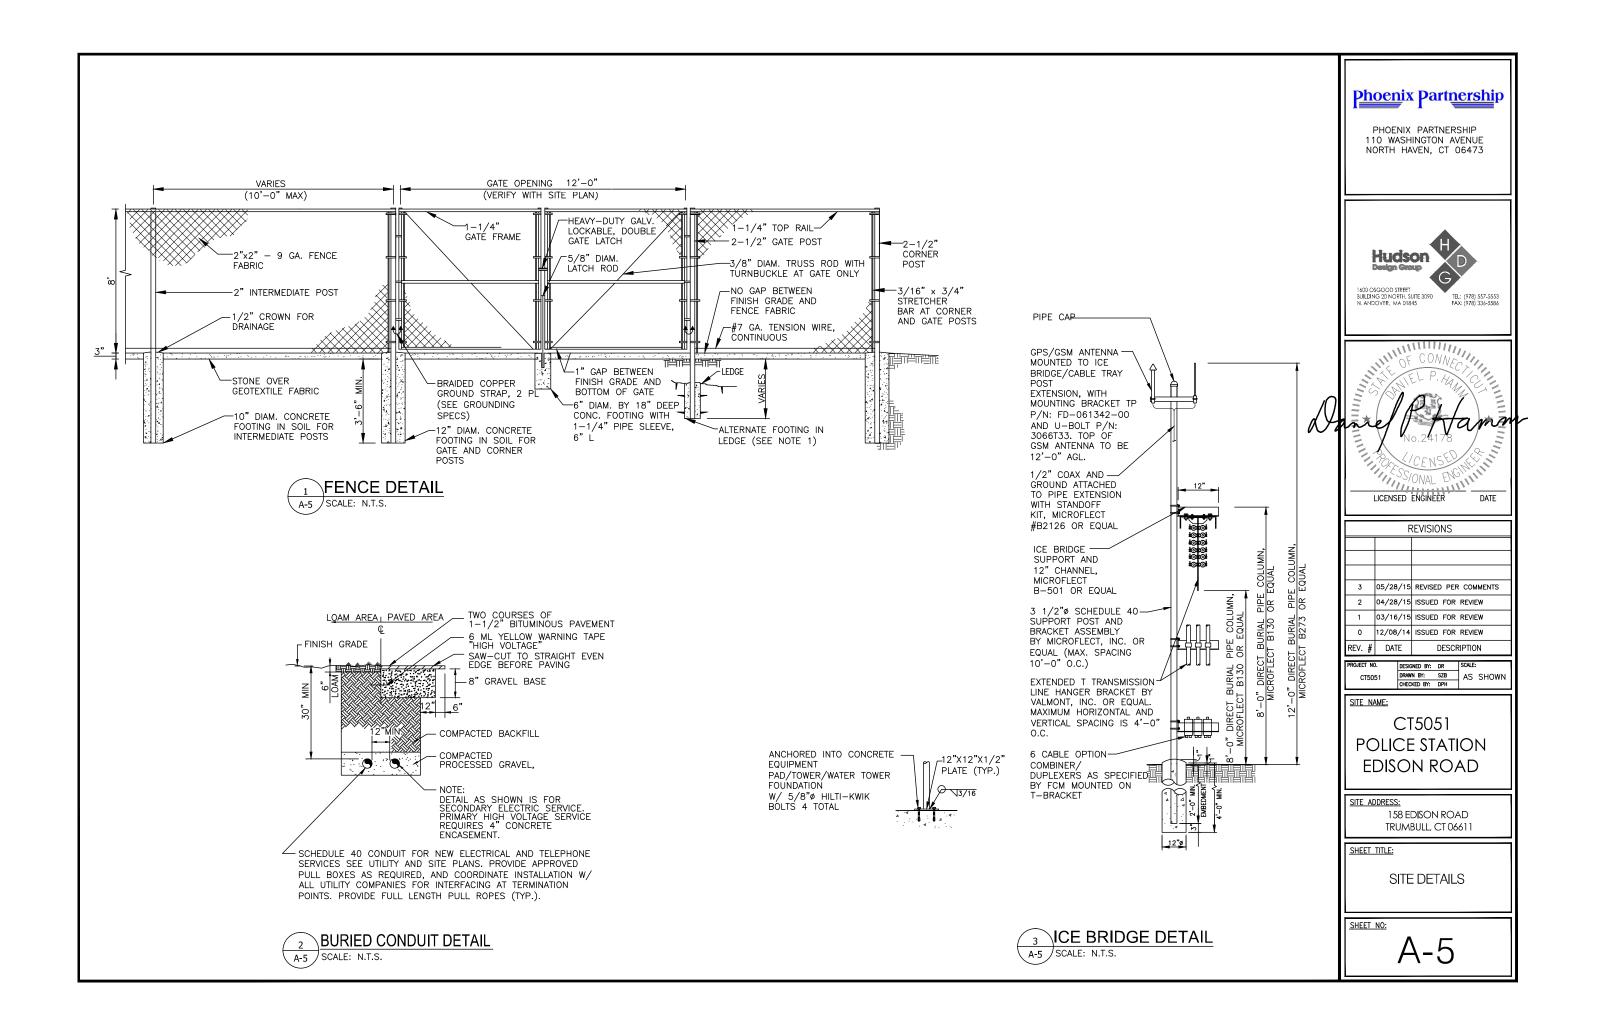
A-2


## FOUNDATION NOTES & CONCRETE SPECIFICATIONS

- 1. FOUNDATION AREA SHALL BE EXCAVATED TO THE DEPTH AND DIMENSIONS SHOWN ON THE PLANS. EXISTING LEDGE AND ALL OTHER EXISTING UNSUITABLE MATERIAL SHALL BE REMOVED AND LEGALLY DISPOSED OF OFF-SITE. THE SUBGRADE SHALL BE ROLLED WITH A 1-TON, VIBRATORY, WALK-BEHIND ROLLER AT A SPEED OF LESS THAN 2 FPS, 6 PASSES MINIMUM, TO PROVIDE UNVIELDING SURFACE.
- UNDERCUT SOFT OR "WEAVING" AREAS A MINIMUM OF 12 INCHES DEEP. BACKFILL UNDERCUT AREA WITH FILL MEETING THE SPECIFICATIONS OF STRUCTURAL FILL.
- CONCRETE TO HAVE A MINIMUM 28 DAY COMPRESSIVE STRENGTH (f'c)=4000
  psi. CONCRETE TO BE AIR ENTRAINED, DESIRED AIR CONTENT TO BE 6%
  (PLUS OR MINUS 2%)
- 4. REINFORCING BAR TO BE ASTM A615 GRADE 60.
- 5. WELDED WIRE FABRIC TO CONFORM TO THE REQUIREMENTS OF ASTM A185. WIRES FOR FABRIC TO CONFORM TO THE REQUIREMENTS OF ASTM A82.
- 6. COORDINATE WITH MANUFACTURER OF PREFABRICATED SHELTER FOR LOCATION OF ATTACHMENTS TO BASE SLAB.
- 7. ALL REINFORCING TO HAVE MINIMUM CONCRETE COVER PER ACI SPECIFICATIONS.
- 8. ALL CONCRETE MATERIALS AND WORKMANSHIP SHALL CONFORM TO LATEST EDITION OF ACI 318 AND APPLICABLE STATE BUILDING CODE.




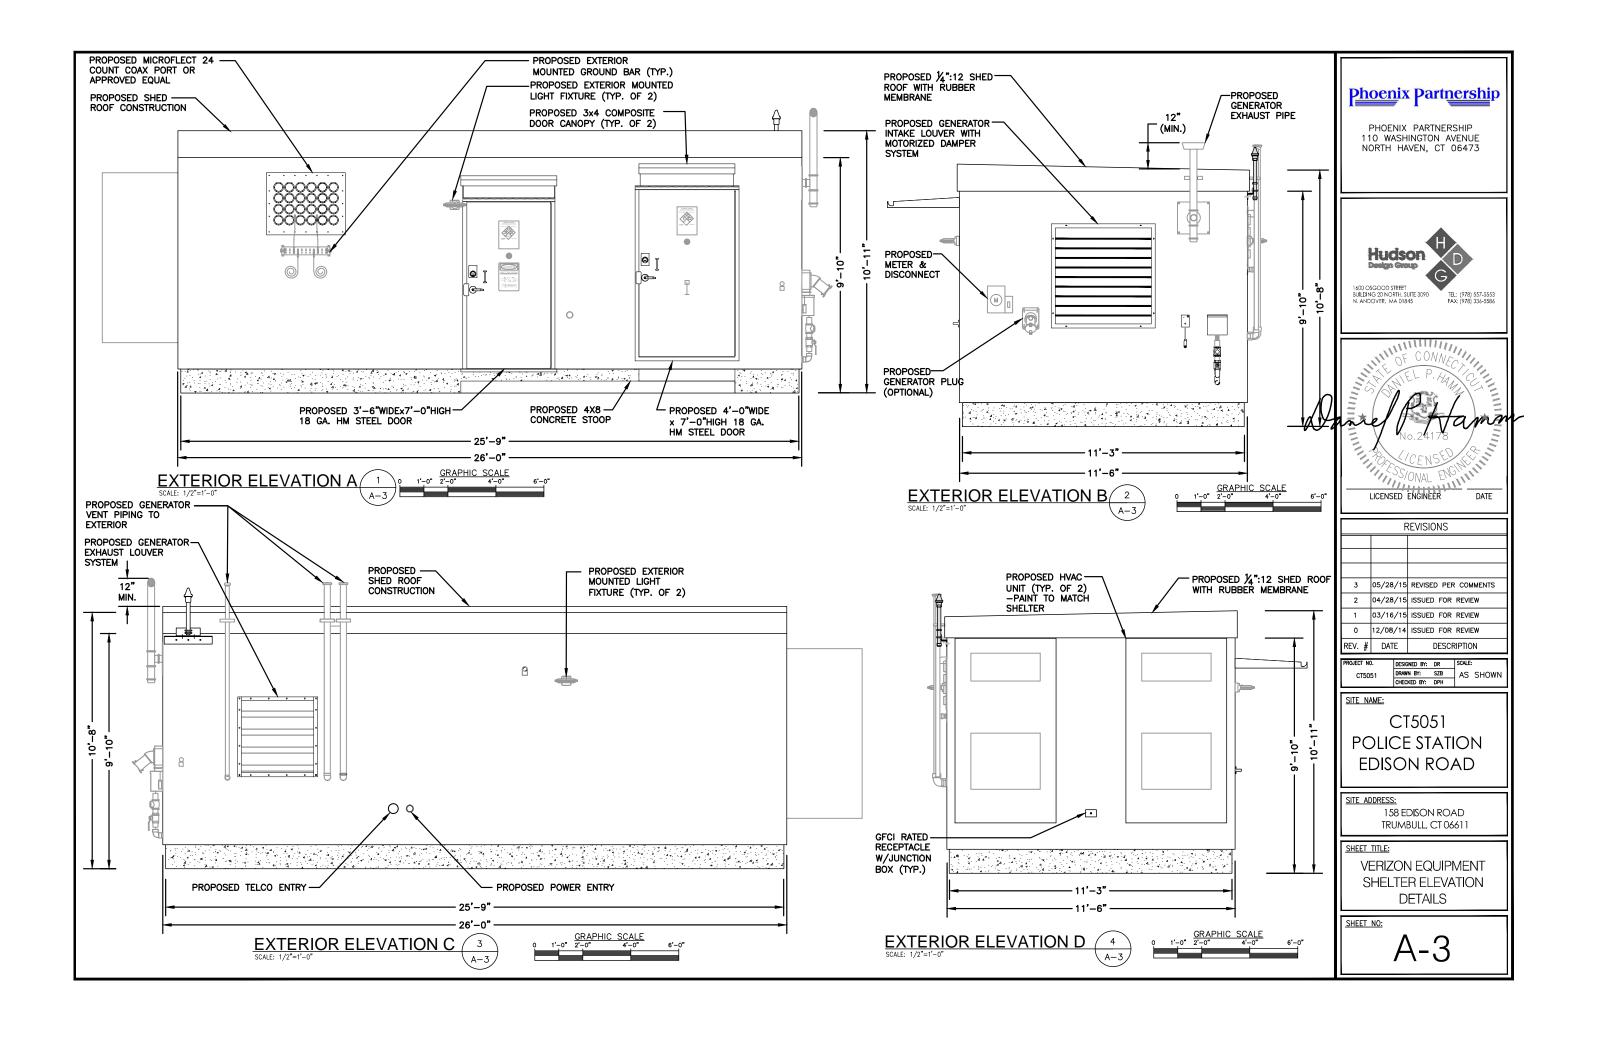

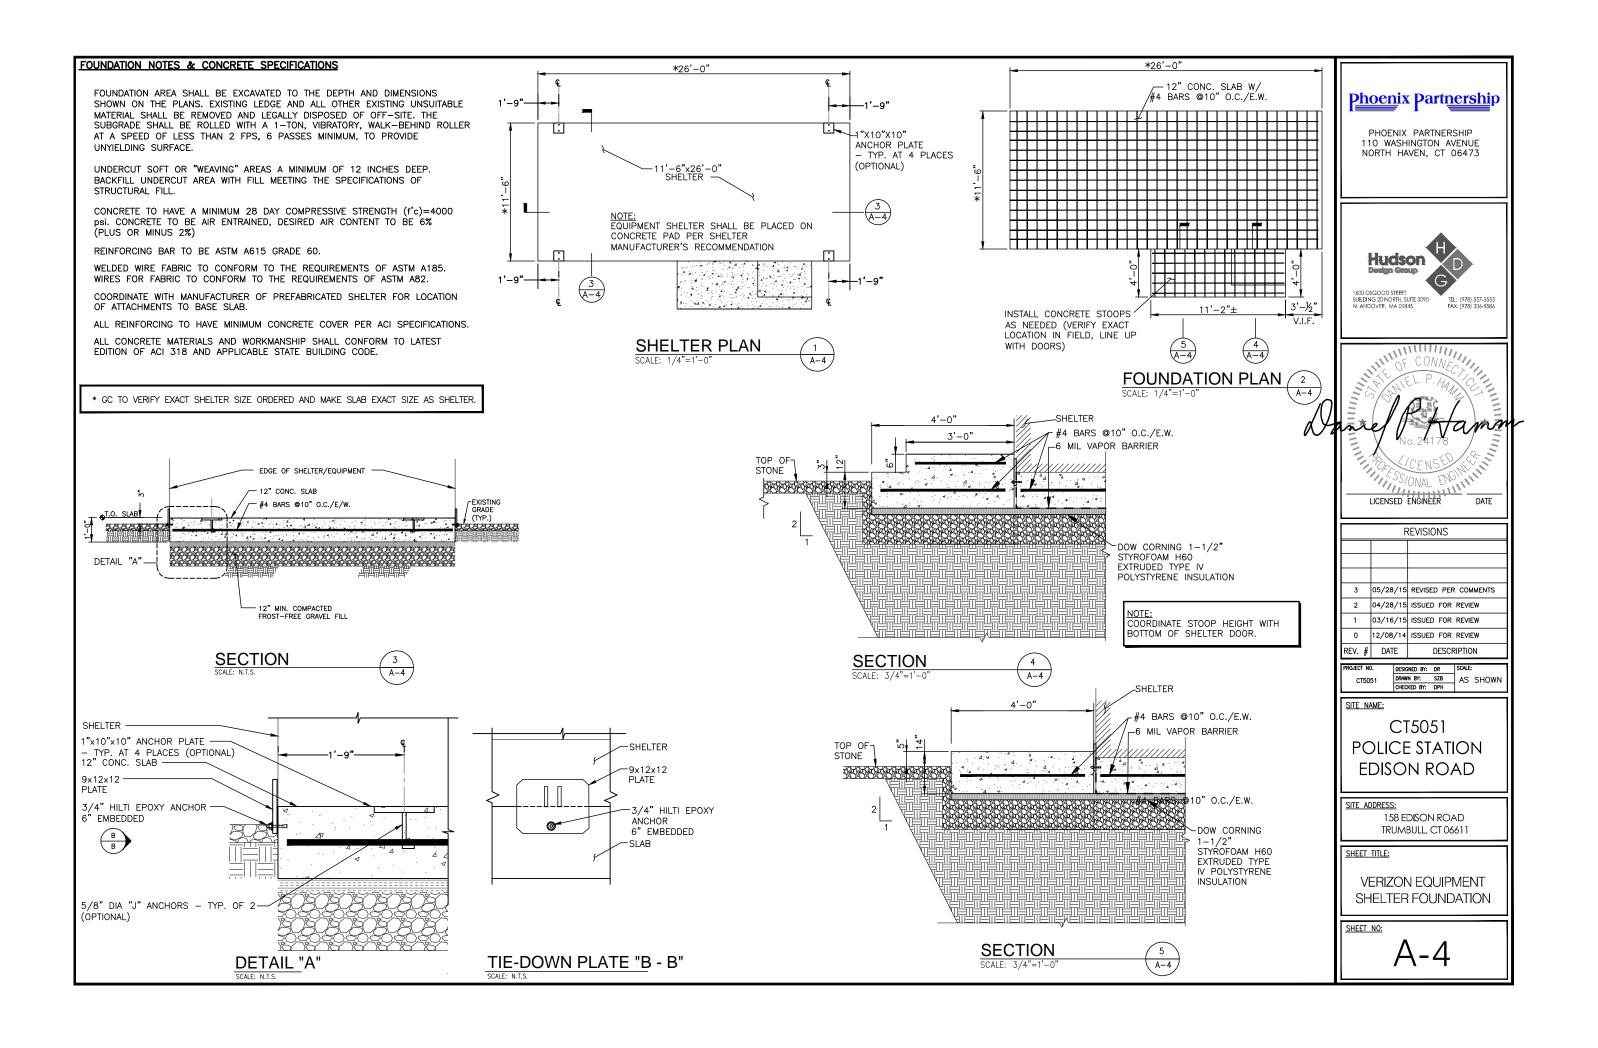

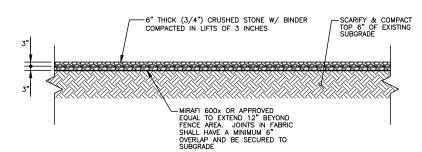




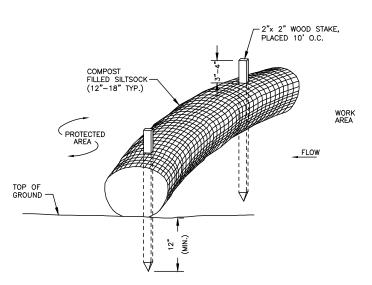

### NOTES:

- 1. SILTSOCK SHALL BE FILTREXX SILTSOXX, OR APPROVED EQUAL.
- 2. COMPOST MATERIAL SHALL BE DISPERSED ON SITE, AS DETERMINED BY THE ENGINEER.
- 3. SILTSOCK SHALL BE INSPECTED PERIODICALLY AND AFTER ALL STORM EVENTS, AND REPAIR OR REPLACEMENT SHALL BE PERFORMED PROMPTLY AS NEEDED.
- 4. SEE SPECIFICATIONS FOR SOCK SIZE, AND COMPOST FILL,



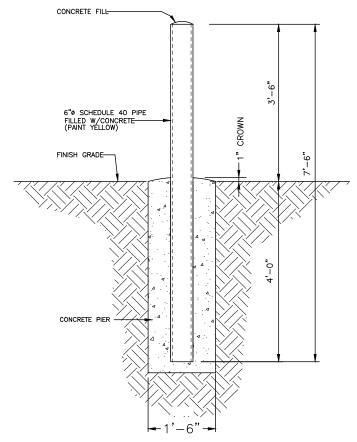

# CONCRETE FILLED BOLLARD SCALE: N.T.S. A-6

#### **GENERAL CONSTRUCTION SEQUENCE:**

THIS IS A GENERAL CONSTRUCTION SEQUENCE OUTLINE SOME ITEMS OF WHICH MAY NOT APPLY TO PARTICULAR SITES.

- 1) CLEAR AND GRUB AREAS OF PROPOSED CONSTRUCTION
- INSTALL TEMPORARY SEDIMENT AND EROSION CONTROL MEASURES AS REQUIRED.
- 3) REMOVE AND STOCKPILE TOPSOIL. STOCKPILE SHALL BE SEEDED TO PREVENT EROSION.
- 4) CONSTRUCT CLOSED DRAINAGE SYSTEM. PROTECT CULVERT INLETS AND CATCH BASINS WITH SEDIMENTATION BARRIERS.
- 5) CONSTRUCT ROADWAYS AND PERFORM SITE GRADING, PLACING HAY BALES AND SILTATION FENCES AS REQUIRED TO CONTROL SOIL EROSION.
- 6) INSTALL UNDERGROUND UTILITIES.
- 7) BEGIN TEMPORARY AND PERMANENT SEEDING AND MULCHING. ALL CUT AND FILL SLOPES SHALL BE SEEDED OR MULCHED IMMEDIATELY AFTER THEIR CONSTRUCTION. NO AREA SHALL BE LEFT UNSTABILIZED FOR A TIME PERIOD OF MORE THAN 30
- 8) DAILY, OR AS REQUIRED, CONSTRUCT, INSPECT, AND IF NECESSARY, RECONSTRUCT TEMPORARY BERMS, DRAINS, DITCHES, SILT FENCES AND SEDIMENT TRAPS INCLUDING MULCHING AND SEEDING.
- 9) BEGIN EXCAVATION FOR AND CONSTRUCTION OF TOWERS AND PLATFORMS.
- 10) FINISH PAVING ALL ROADWAYS, DRIVES, AND PARKING AREAS.
- 11) COMPLETE PERMANENT SEEDING AND LANDSCAPING.
- 12) NO STORM WATER FLOW SHALL BE DIVERTED TO ANY WETLANDS UNTIL A HEALTHY STAND OF GRASS HAS BEEN ESTABLISHED IN REGRADED AREAS.
- 13) AFTER GRASS HAS BEEN FULLY GERMINATED IN ALL SEEDED AREAS, REMOVE ALL TEMPORARY EROSION CONTROL MEASURES.

### **EROSION CONTROL MEASURES:**

- DISTURBED AREAS SHALL BE KEPT TO THE MINIMUM AREA NECCESSARY TO CONSTRUCT THE ROADWAYS AND ASSOCIATED DRAINAGE FACILITIES.
- HAY BALE BARRIERS AND SEDIMENT TRAPS SHALL BE INSTALLED AS REQUIRED. BARRIERS AND TRAPS ARE TO BE MAINTAINED AND CLEANED UNTIL ALL SLOPES HAVE A HEALTHY STAND OF GRASS.
- 3) BALED HAY AND MULCH SHALL BE MOWINGS OF ACCEPTABLE HERBACEOUS GROWTH, FREE FROM NOXIOUS WEEDS OR WOODY STEMS, AND SHALL BE DRY. NO SALT HAY SHALL BE USED.
- FILL MATERIAL SHALL BE FREE FROM STUMPS, WOOD, ROOTS. ETC.
- 5) STOCKPILED MATERIALS SHALL BE PLACED ONLY IN AREAS SHOWN ON THE PLANS. STOCKPILES SHALL BE PROTECTED BY SILTATION FENCE AND SEEDED TO PREVENT EROSION. THESE MEASURES SHALL REMAIN UNTIL ALL MATERIAL HAS BEEN PLACED OR DISPOSED OFF SITE.
- 6) ALL DISTURBED AREAS SHALL BE LOAMED AND SEEDED. A MINIMUM OF 4 INCHES OF LOAM SHALL BE INSTALLED WITH NOT LESS THAN ONE POUND OF SEED PER 50 SQUARE YARDS OF AREA.
- APPLICATION OF GRASS SEED, FERTILIZERS AND MULCH SHALL BE ACCOMPLISHED BY BROADCAST SEEDING OR HYDROSEEDING AT THE RATES OUTLINED BELOW:

LIMESTONE:75-100 LBS./1,000 SQUARE FEET.
FERTILIZER:RATE RECOMMENDED BY MANUFACTURER.
MULCH: HAY MULCH APPROXIMATELY 3 TONS/ACRE UNLESS
EROSION CONTROL MATTING IS USED.

EED MIX (SLOPES LESS THAN 4:1)	LBS./ACRE
CREEPING RED FESCUE	20
TALL FESCUE	20
REDTOP	2
	42
LOPE MIX (SLOPES GREATER THAN 4:1)	LBS./ACRE
CREEPING RED FESCUE	20
TALL FESCUE	20
BIRDSFOOT TREEFOIL	8
	48

#### TREATMENT SWALE PLANTING SPECIFICATIONS

TALL FESCUE 20 LBS/ACRE 0R 0.45 LBS/10,000 SF CREEPING RED FESCUE 20 LBS/ACRE 0R 0.45 LBS/10,000 SF BIRDSFOOT TREFOIL 8 LBS/ACRE 0R 0.20 LBS/10,000 SF

LIME AND FERTILIZER SHOULD BE APPLIED PRIOR TO OR AT TIME OF SEEDING AND INCORPORATED INTO THE SOIL. THE FOLLOWING RATES ARE RECOMMENDED:

AGRICULTURAL LIMESTONE 2 TONS/ACRE OR 100 LBS/1,000 SF NITROGEN (N) 50 LBS/ACRE OR 1.1 LBS/10,000 SF PHOSPHATE (P205) 100 LBS/ACRE OR 2.2 LBS/10,000 SF POTASH (K20) 100 LBS/ACRE OR 2.2 LBS/10,000 SF (THIS IS EQUIVALENT TO 500 LBS/ACRE OF 10-20-20 FERTILIZER OR 1,000 LBS/ACRE OF 5-10-10).

- AFTER ALL DISTURBED AREAS HAVE BEEN STABILIZED THE
  TEMPORARY EROSION CONTROL MEASURES ARE TO BE REMOVED.
- 9) PAVED ROADWAYS MUST BE KEPT CLEAN AT ALL TIMES.
- 10) ALL CATCH BASIN INLETS WILL BE PROTECTED WITH LOW POINT SEDIMENTATION BARRIER.
- 11) ALL STORM DRAINAGE OUTLETS WILL BE STABILIZE AND CLEANED AS REQUIRED, BEFORE THE DISCHARGE POINTS BECOME OPERATIONAL.
- 12) ALL DEWATERING OPERATIONS MUST DISCHARGE DIRECTLY INTO A SEDIMENT FILTER AREA.
- 13) NO DISCHARGE SHALL BE DIRECTED TOWARDS ANY PROPOSED DITCHES, SWALES, OR PONDS UNTIL THEY HAVE BEEN PROPERLY STABILIFED

# <u>Phoen</u>ix Part<u>nershi</u>p

PHOENIX PARTNERSHIP 110 WASHINGTON AVENUE NORTH HAVEN, CT 06473





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CT5051 POLICE STATION EDISON ROAD

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SHEET TITLE:

SITE SURFACE & EROSION CONTROL DETAILS

SHEET NO:

A-6