

# **DEVELOPMENT & MANAGEMENT PLAN AVON**

**SITE # 1257 DOCKET# 373** 

**224 LOVELY STREET AVON, CT 06067** 

SITE TYPE: RAW LAND - MONOPOLE

# SITE INFORMATION:

APPLICANT: NEW CINGULAR WIRELESS PCS, LLC (AT&T MOBILITY) 500 ENTERPRISE DRIVE, SUITE 3A ROCKY HILL, CT 06067 SITE ADDRESS: 224 LOVELY STREET AVON, CT 06001 COUNTY: HARTFORD LATITUDE: N 41° 47' 58.03" LONGITUDE: W 72° 53' 16.34" COUNTY: HARTFORD TAX ID PARCEL NUMBER: MAP 22, BLOCK 1, LOT 8 PROPERTY OWNER: ST. MATTHEWS LUTHERAN CHURCH 224 LOVELY STREET ZONING CLASSIFICATION: ZONE R-30 ZONING JURISDICTION: TOWN OF AVON ARCHITECT / ENGINEER: HUDSON DESIGN GROUP LLC 1600 OSGOOD STREET BUILDING 20 NORTH, SUITE 2-101

## SITE SPECIFIC NOTES:


- TOWER COLOR TO BE A MATTE FINISH WITH THE FINAL PAINT COLOR SELECTION MADE BY THE TOWN PLANNER NO LATER THAN 10 DAYS AFTER THE COUNCIL'S MODIFIED DECISION & ORDER FROM THE COLORS PROVIDED BY AT&T THAT SHALL BE APPROVED TOWER MANUFACTURER PAINTS AND CLOSEST APPROXIMATE
- DECIDIOUS TREE TRUNK COLORS.

  NO PERMANENT DIESEL OR GAS GENERATORS PERMITTED.

  ROUTINE MAINTENANCE BY AT&T, ITS SUBTENANTS AND AGENTS TO BE PERFORMED M-F BETWEEN THE HOURS OF 9-5.

  TOWER HEIGHT IS LIMITED TO 110' UNLESS THE TOWN OF AVON CONSENTS TO ANY PROPOSED EXPANSION THEREOF IN THE FUTURE IN ITS SOLE DISCRETION AND PRIOR TO ANY REQUEST TO THE SITING COUNCIL INVOLVING A PROPOSED EXPANSION BY THE
- PROPOSED CLEARWIRE & POCKET EQUIPMENT SHALL BE PLACED INSIDE "MINI SHELTERS" TO MATCH AT&T SHELTER (AT CO-LOCATING CARRIERS EXPENSE)

# VICINITY MAP

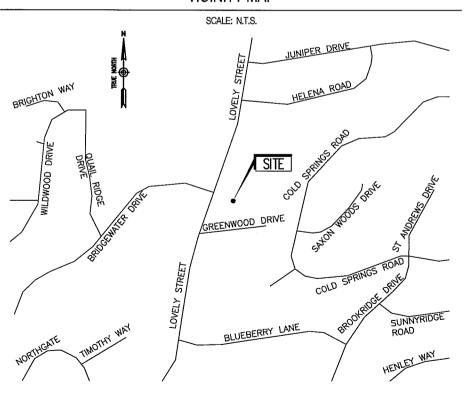

## DRIVING DIRECTIONS

START OUT GOING NORTHEAST ON ENTERPRISE DR TOWARD CAPITOL BLVD. 0.4 MI. TURN LEFT ONTO CAPITOL BLVD. 0.3 MI. TURN LEFT ONTO WEST ST. 0.3 MI. MERGE ONTO I-91 S VIA THE RAMP ON THE LEFT TOWARD NEW HAVEN. 1.7 MI MAP, MERGE ONTO CT-9 N VIA EXIT 22N TOWARD NEW BRITAIN, 11.1 MI, MERGE ONTO I-84 W/US-6 W VIA EXIT 32 ON THE LEFT TOWARD WATERBURY. 1.2 ML MERGE ONTO CT-4 W/FARMINGTON AVE VIA EXIT 39 TOWARD FARMINGTON. 5.8 MI. TURN RIGHT ONTO LOVELY ST/CT-177. 2.9 MI. 224 LOVELY ST IS ON THE RIGHT.

# **APPROVALS**

LANDLORD:	
FIELD CONST. MGR:	
RF ENGINEER:	
SITE ACQUISITION AGENT:	
ARCHITECT/ENGINEER:	

## SHEET INDEX

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# DO NOT SCALE DRAWINGS

CONTRACTOR SHALL VERIFY ALL PLANS AND EXISTING DIMENSIONS AND CONDITIONS ON THE JOB SITE AND SHALL IMMEDIATELY NOTIFY THE PROJECT OWNER'S REPRESENTATIVE IN WRITING OF DISCREPANCIES BEFORE PROCEEDING WITH THE WORK OR BE RESPONSIBLE FOR SAME.

# PROJECT DESCRIPTION

- THIS IS AN UNMANNED AND RESTRICTED ACCESS EQUIPMENT AND WILL BE USED FOR THE TRANSMISSION OF RADIO SIGNAL FOR THE PURPOSE OF PROVIDING PUBLIC CELLULAR SERVICE.
- THIS FACILITY WILL CONSUME NO UNRECOVERABLE ENERGY.
- NO POTABLE WATER SUPPLY IS TO BE PROVIDED AT THIS LOCATION.
- NO WASTE WATER WILL BE GENERATED AT THIS LOCATION. NO SOLID WASTE WILL BE GENERATED AT THIS LOCATION.
- MAINTENANCE CREW (TYPICALLY ONE PERSON) WILL MAKE AN AVERAGE OF ONE TRIP PER MONTH AT ONE HOUR PER VISIT.



500 ENTERPRISE DRIVE ROCKY HILL, CT 06067

Hudson



1600 OSGOOD STREET BUILDING 20 NORTH, SUITE 2-101 N. ANDOVER, MA 01845

ENGINEER/LAND SURVEYOR

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	REVISIONS				
3		08/05/10	REVISE ACCESS EASEMENT & COMPOUND		
2		04/13/10	REVISE SHELTER DETAILS		
1		03/31/10	REVISE EASEMENTS		
0		03/09/10	ISSUED FOR REVIEW		
REV.	#	DATE	DESCRIPTION		

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1257-AVON

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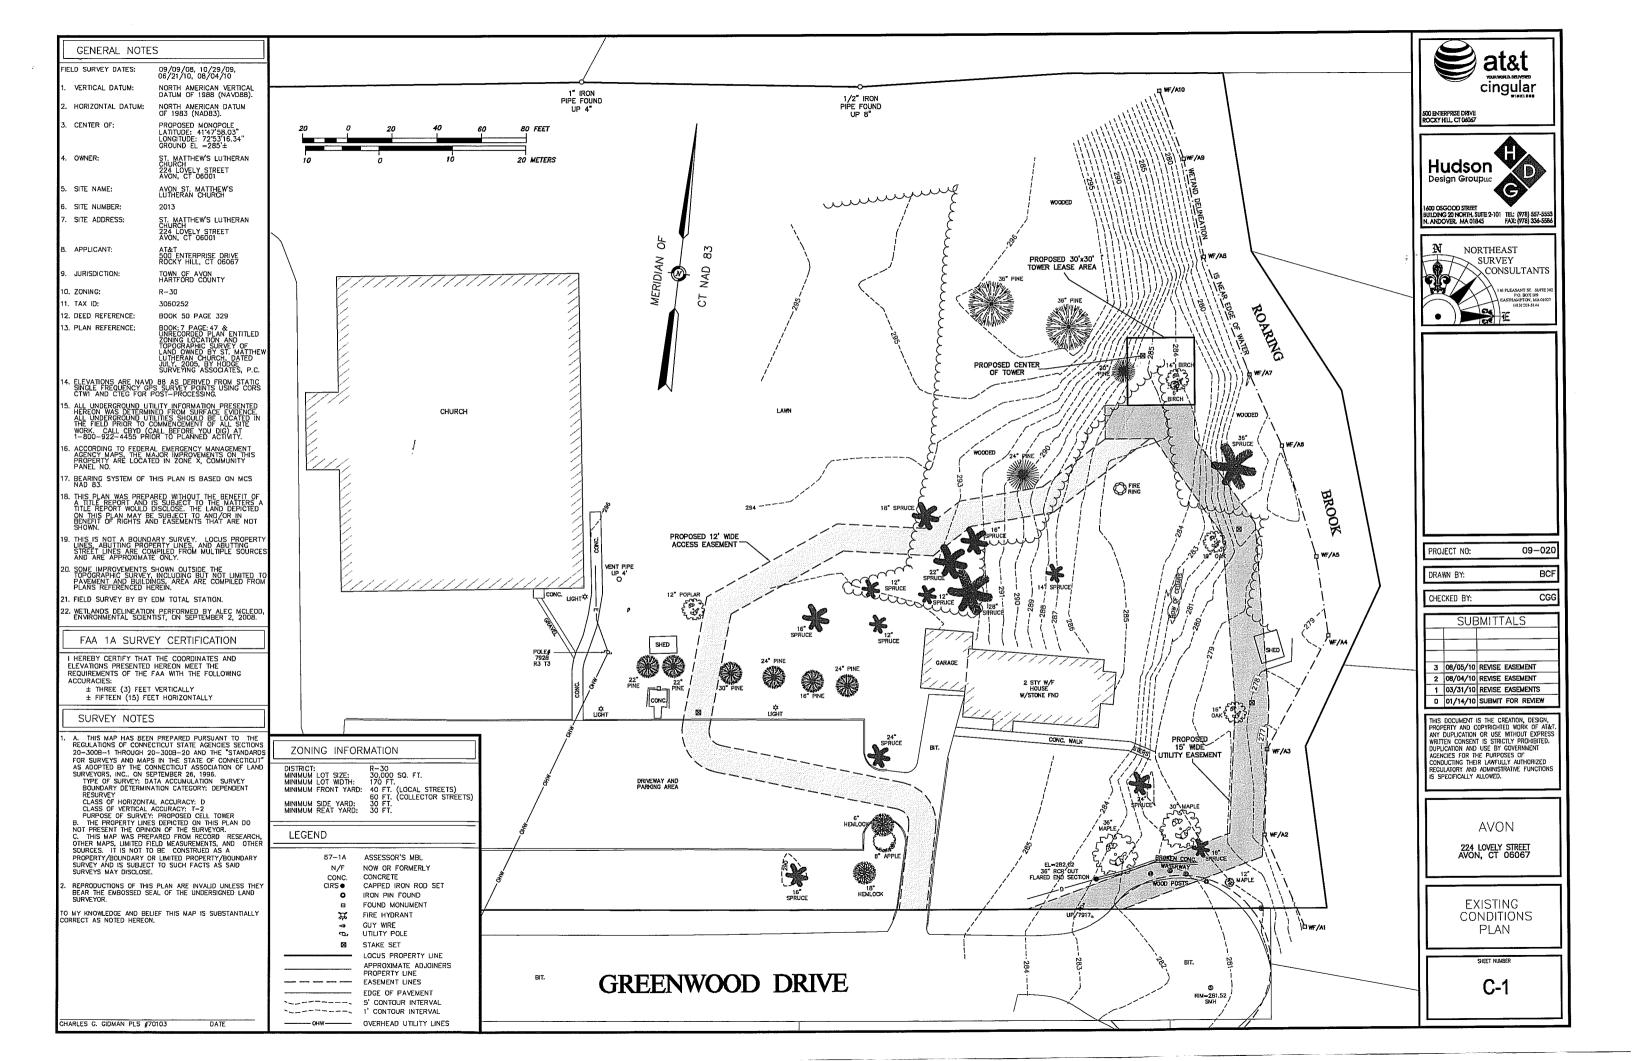
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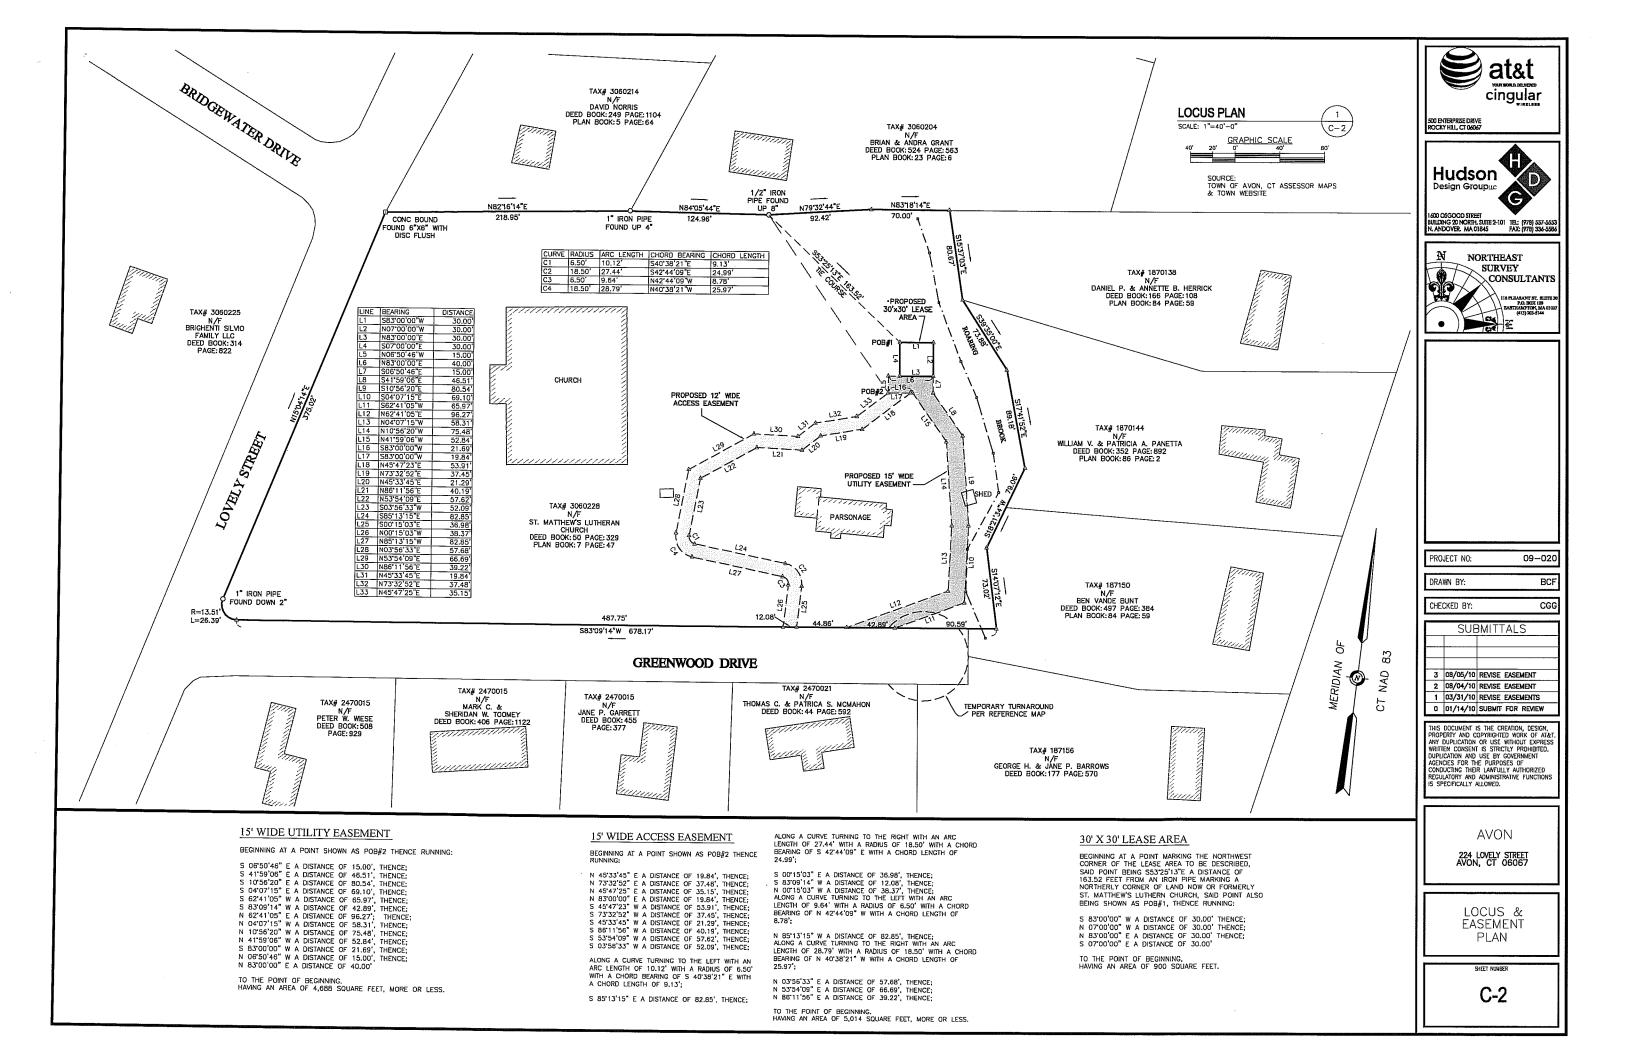
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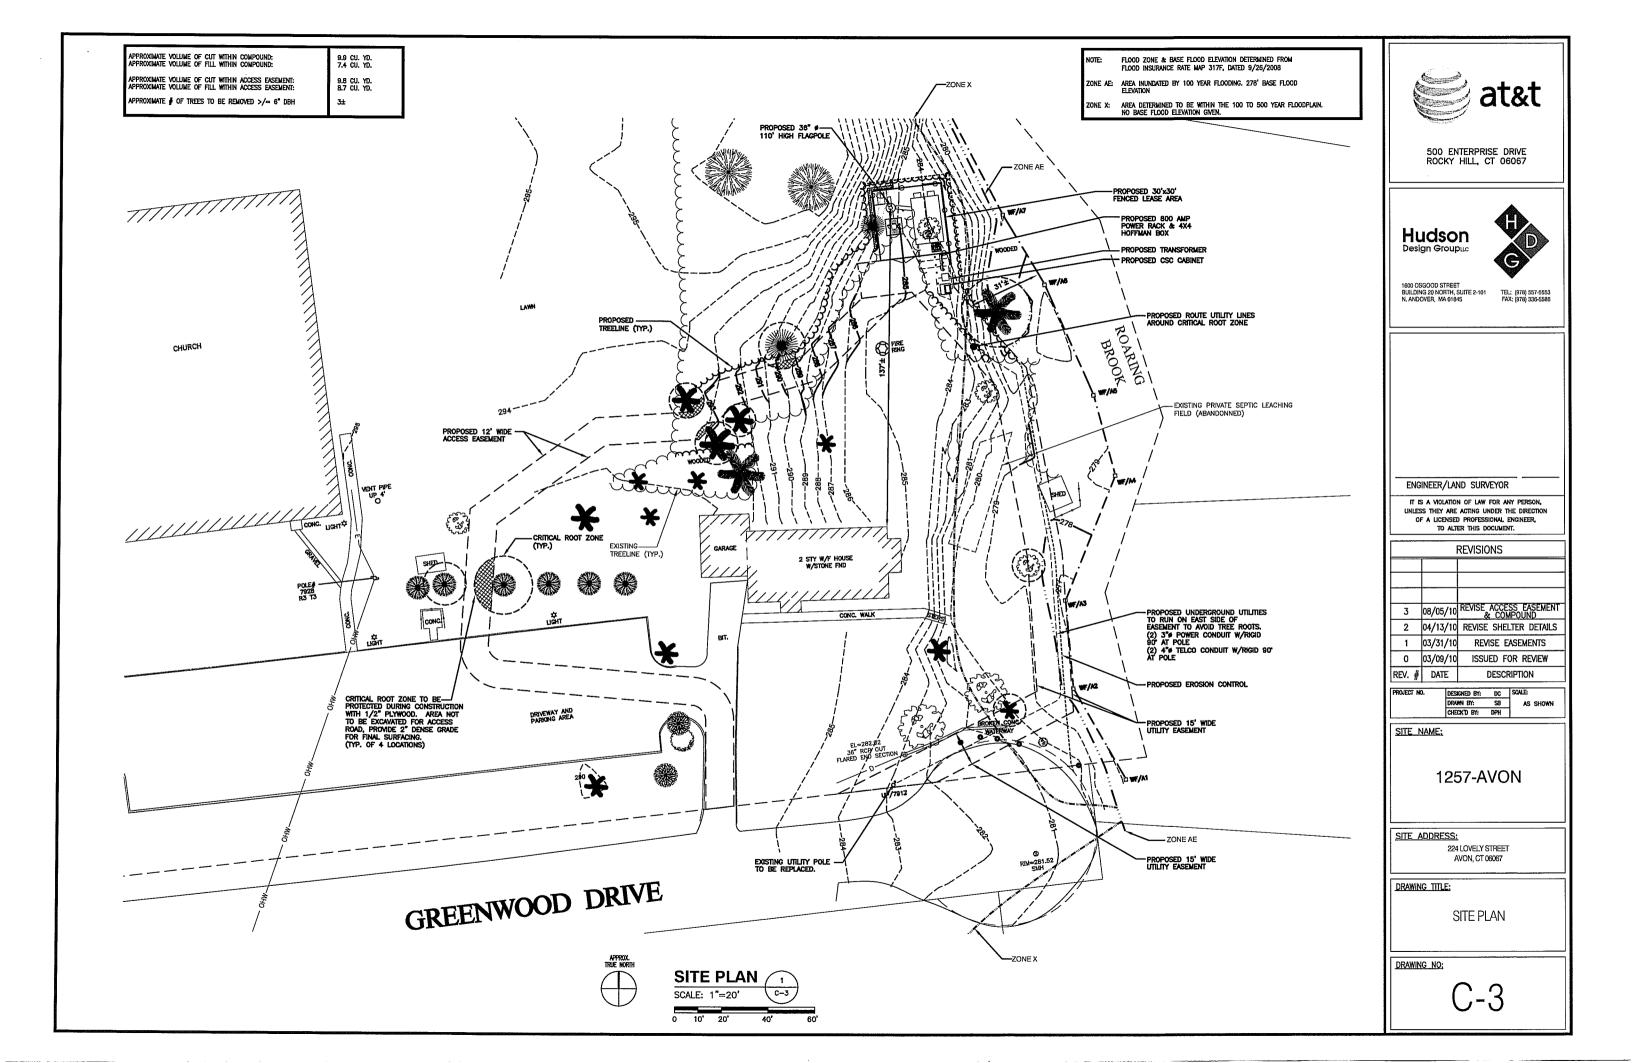
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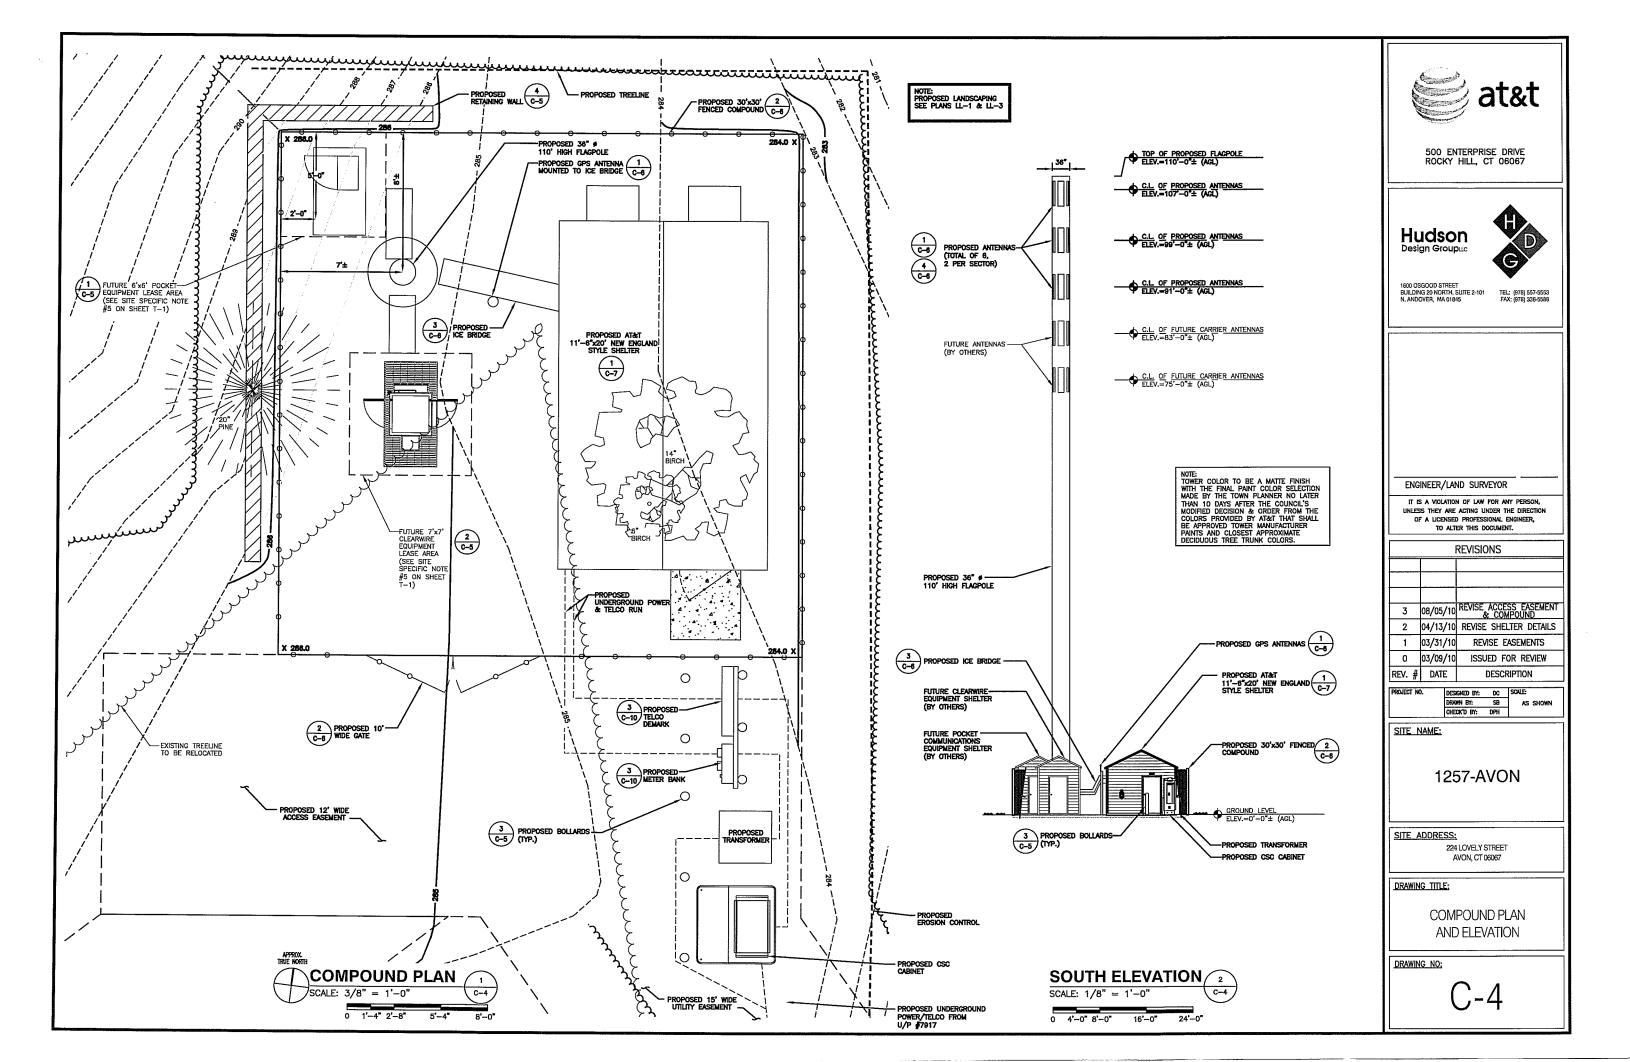
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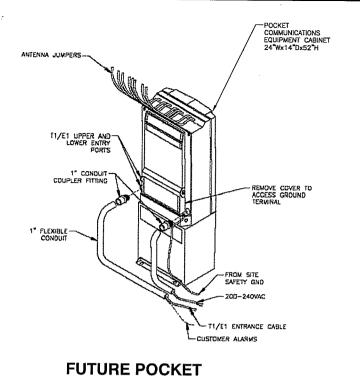
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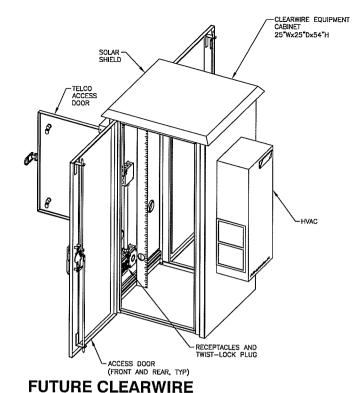













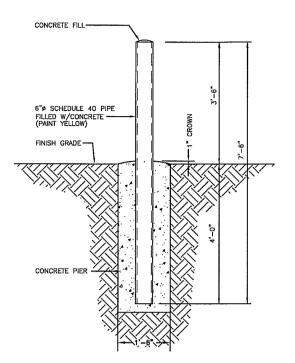

BOLLARD DETAIL
SCALE: N.T.S.

COMMUNICATIONS
EQUIPMENT CABINET

SCALE: N.T.S.

EQUIPMENT CABINET SCALE: N.T.S.

IMPERMEABLE CONCRETE OR ASPHALT LINING 4" THICK MINIMUM -OPTIONAL ALLAN-BLOCK CAPSTONE The state of the s IMPERMEABLE FILL TO MINIMUM THICKNESS OF 6 12" ALLAN — BLOCK UNIT 4'-5"± EXPOSED WALL HEIGHT WELL-GRADED GRANULAR WALL ROCK 0.25 in TO 1.5 in LESS THAN 10% FINES RETAINED SOIL -3'-0" GEOGRID REINFORCEMENT INSTALLED EVERY 2 COURSES FINISHED GRADE-(FORTRAC 35/20-20) -WINNING COLOR -4" PERFORATED TOE DRAINS PITCH TO OPEN AT OUTFALL (MIN) —12 in (MIN)

RETAINING WALL DETAIL 4
SCALE: N.T.S. 4
0-5

## RETAINING WALL NOTES:

C-5

- 1. STRIP VEGETATION AND ORGANIC SOIL FROM WALL AND GEOSYNTHETIC ALIGNMENT.
- 2. BENCH CUT ALL EXCAVATED SLOPES.
- 3. DO NOT OVER EXCAVATE UNLESS DIRECTED BY SITE SOIL ENGINEER TO REMOVE UNSUITABLE SOIL
- SITE SOIL ENGINEER SHALL VERIFY FOUNDATION SOILS AS BEING COMPETENT PER THE DESIGN STANDARDS AND PARAMETERS.
- 5. BASE SHALL CONSIST OF COMPACTED GRAVEL, 6" THICK MIN.
- CONTRACTOR MAY OPT FOR A LEAN CONCRETE PAD. CONCRETE PAD SHALL BE UNREINFORCED, 4"
  THICK.
- 7. MINIMUM EMBEDMENT OF WALL BELOW FINISH GRADE SHALL BE 2 COURSES OF BLOCK".
- FOLLOW APPLICABLE PROVISIONS OF THE MANUFACTURER'S INSTALLATION INSTRUCTIONS AND WRITTEN SPECIFICATIONS.
- 9. NO. 8 CRUSHED STONE SHALL BE INSTALLED BEHIND THE WALL UP TO 18" FROM THE TOP OF THE WALL. CRUSHED STONE SHALL NOT EXTEND BELOW FINISHED GRADE IN FRONT OF WALL.
- 10. WHERE DRAIN PIPE IS USED, PROVIDE OUTLETS MAX. 40 FT C-C.
- 11. FOR UNITS TO BE EMBEDDED, COMPACT FILL IN FRONT OF UNITS AT THE SAME TIME BACKFILL BEHIND UNITS IS COMPACTED.
- COMPACTION TESTS SHALL BE TAKEN AS THE WALL IS INSTALLED. THE MINIMUM NUMBER OF TESTS SHALL BE DETERMINED BY THE ENGINEER,
- 13. COMPACTION SHALL BE TO 95% OF MAXIMUM STANDARD PROCTOR DENSITY. (ASTM D-698)
- 14. SEE SHOP DRAWINGS FOR GEOSYNTHETIC TYPE, LENGTH AND LOCATION REQUIRED.
- GEOSYNTHETIC SHALL BE THE TYPE AND LENGTH AS SHOWN ON SHOP DRAWINGS.
   GEOSYNTHETIC TIGHT PRIOR TO BACKFILLING.
- GEOSYNTHETIC SHALL BE PLACED WITH STRONGEST DIRECTION PERPENDICULAR TO WALL FOLLOW GEOSYNTHETIC MANUFACTURER'S INSTALLATION INSTRUCTIONS AND WRITTEN SPECIFICATIONS.
- 17. THE CONTRACTOR SHALL SUBMIT A SHOP DRAWING SHOWING THE COMPLETE WALL SYSTEM AND ALL DETAILS BASED ON THE ACTUAL SOILS IN THE FIELD THESE SHOP DRAWINGS SHALL BE SIGNED AND SEALED BY A PROFESSIONAL ENGINEER LICENSED IN THE STATE OF CONNECTICUT
- IF CONDITIONS ARE DIFFERENT THAN THOSE STATED IN THESE DRAWINGS AND SPECIFICATIONS, THE CONTRACTOR MUST CONTACT ENGINEER PRIOR TO PROCEEDING WITH THE CONSTRUCTION OF THE WALL.
- IF WALL LEVELING PAD REQUIRES FILL IT SHALL BE COMPACTED GRAVEL FROM BOTTOM OF EXCAVATION TO SUITABLE SOIL TO BOTTOM OF WALL.



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Hudson Design Groupuc



1600 OSGOOD STREET BUILDING 20 NORTH, SUITE 2-101 N. ANDOVER. MA 01845

TEL: (978) 557-5553 FAX: (978) 336-5586

ENGINEER/LAND SURVEYOR

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REV. #	DATE	DESCRIPTION			

ROJECT NO.	DESIGNED BY:	DESIGNED BY: DC	
	DRAWN BY:	S8	AS SHOW
	CHECK'D BY:	DPH	1

SITE NAME:

1257-AVON

SITE ADDRESS:


224 LOVELY STREET AVON, CT 06067


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**DETAILS** 

DRAWING NO:

C-5



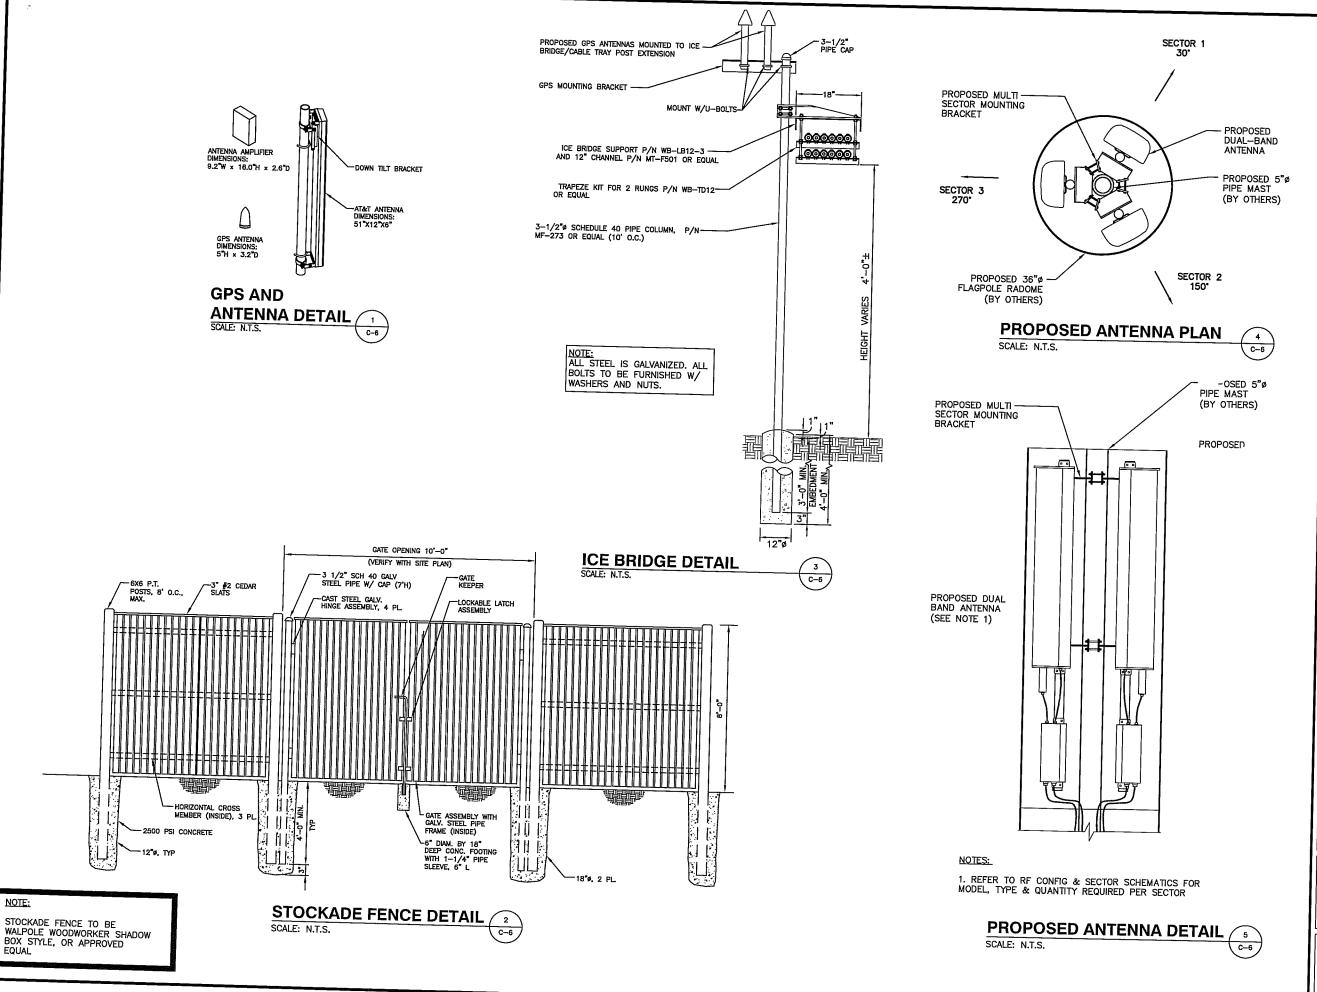

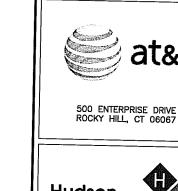

1600 OSGOOD STREET
BUILDING 20 NORTH, SUITE 2-101
N. ANDOVER, MA 01845
TEL: (978) 557-5533
FAX: (976) 336-5866

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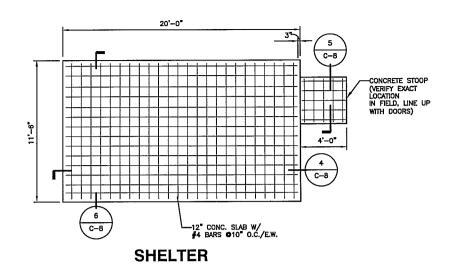
DETAILS

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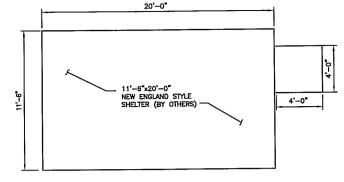
## FOUNDATION NOTES & CONCRETE SPECIFICATIONS

- 1. FOUNDATION AREA SHALL BE EXCAVATED TO THE DEPTH AND DIMENSIONS SHOWN ON THE PLANS. EXISTING LEDGE AND ALL OTHER EXISTING UNSUITABLE MATERIAL SHALL BE REMOVED AND LEGALLY DISPOSED OF OFF—SITE. THE SUBGRADE SHALL BE ROLLED WITH A 1—TON, VIBRATORY, WALK—BEHIND ROLLER AT A SPEED OF LESS THAN 2 FPS, 6 PASSES MINIMUM, TO PROVIDE UNYIFI DING SURFACE.
- UNDERCUT SOFT OR "WEAVING" AREAS A MINIMUM OF 12 INCHES DEEP. BACKFILL UNDERCUT AREA WITH FILL MEETING THE SPECIFICATIONS OF STRUCTURAL FILL (SEE NOTE #3)
- 3. Concrete to have a minimum 28 day compressive strength (f'c)=4000 psi. Concrete to be air entrained, desired air content to be 6%
- 4. BAR REINFORCING TO BE ASTM A615 GRADE 60.
- WELDED WIRE FABRIC TO CONFORM TO THE REQUIREMENTS OF ASTM A185. WIRES FOR FABRIC TO CONFORM TO THE REQUIREMENTS OF ASTM A82.
- 6. COORDINATE WITH MANUFACTURER OF PREFABRICATED SHELTER FOR LOCATION OF ATTACHMENTS TO BASE SLAB.
- 7. ALL REINFORCING TO HAVE 2" MINIMUM CONCRETE COVER.
- 8. ALL CONCRETE MATERIALS AND WORKMANSHIP SHALL CONFORM TO LATEST EDITION OF ACI 318 BUILDING CODE AND BOCA NATIONAL BUILDING CODE.




**FOUNDATION PLAN** 


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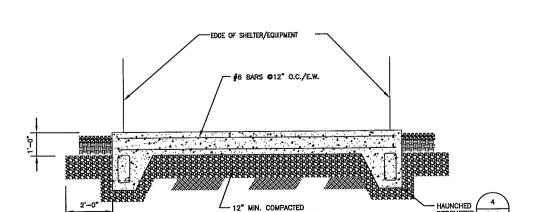







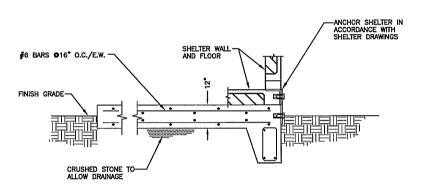




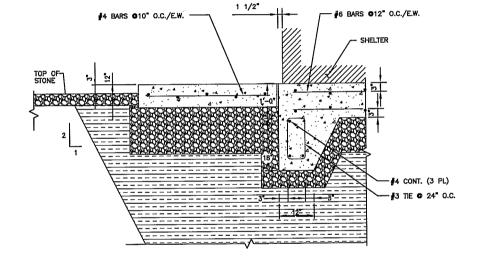

**SECTION** SCALE: 3/4" = 1'-0"

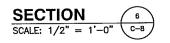

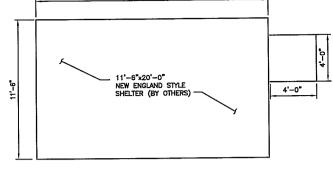



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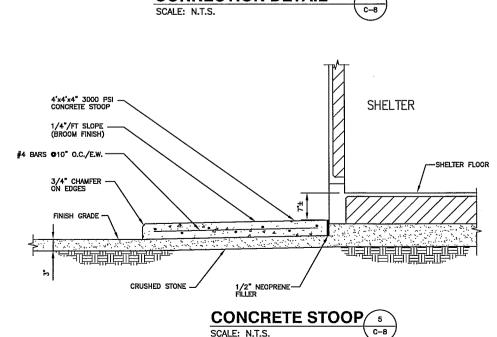
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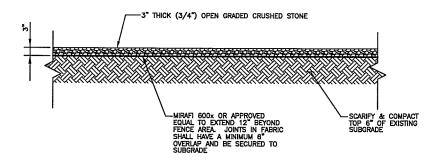
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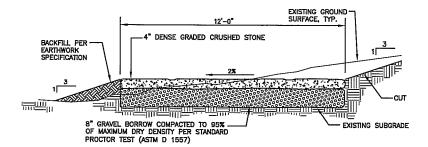
SHELTER FOUNDATION & PAD DETAILS

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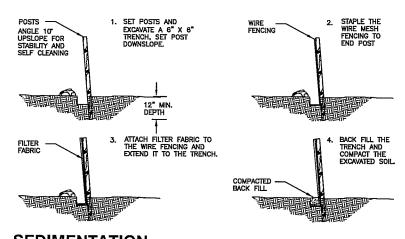















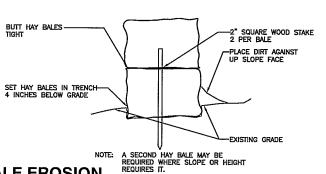

**HAYBALE EROSION CONTROL BARRIER** 

C-9

C-9

## EROSION CONTROL

## CONSTRUCTION SEQUENCE

- 1) NOTIFY THE TOWN INLAND WETLANDS AGENT AT LEAST ONE WEEK PRIOR TO THE PRE-CONSTRUCTION MEETING.
- COMPLETE A "CALL BEFORE YOU DIG" PRIOR TO ANY ON SITE ACTIVITY. RECALL EVERY 30 DAYS.
- 3) CUT AND STUMP AREAS OF PROPOSED CONSTRUCTION.
- 4) INSTALL TEMPORARY SEDIMENT AND EROSION CONTROL MEASURES AS REQUIRED.
- 5) WOOD CHIPS GENERATED FROM CLEARING ACTIVITIES MAY BE USED AS A TEMPORARY STABILIZATION MEASURE IN ADDITION TO SILT FENCING & HAY BALES.
- INSTALL HAY BALES TO "BACK UP" SILTATION FENCE ALONG ALL DOWNGRADIENT WETLANDS BOUNDARIES.
- 7) ESTABLISH ROADWAY CENTERLINE WITH GRADE STAKES AND OFF SETS.
- 8) STOCKPILE EXCAVATED SOILS A MINIMUM OF 75 FEET FROM ANY WETLAND AREA
- CONSTRUCT CLOSED DRAINAGE SYSTEM. PROTECT CULVERT INLETS WITH SEDIMENTATION BARRIERS.
- 10) ROUGH GRADE DITCH STARTING FROM THE DOWNGRADIENT LOCATION
- 11) INSTALL STONE LINING AND LEVEL SPREADERS AT CULVERT OUTLETS
- 13) CONSTRUCT ROADWAYS AND PERFORM SITE GRADING, PLACING HAY BALES AND SILTATION FENCES AS REQUIRED TO CONTROL SOIL EROSION.
- 14) EXCAVATE FOR ANY SUBSURFACE UTILITIES.
- 15) STOCKPILE EXCAVATED SOILS A MINIMUM OF 75 FEET FROM ANY WETLAND AREA.
- 16) ESTABLISH SEDIMENT AND EROSION CONTROLS AROUND STOCKPILE SOILS
- 17) INSTALL UTILITY SERVICES
- 18) INSTALL STORM DRAINAGE STARTING AT THE MOST DOWNGRADIENT LOCATION.
- 19) INSTALL ALL RIP RAP AT OUTLETS FOR STORM DRAINAGE.
- 20) INSTALL HAY BALE PROTECTION TO STORM DRAINAGE INLETS.
- 21) INSTALL ROAL
- 22) BEGIN TEMPORARY AND PERMANENT SEEDING AND MULCHING, ALL CUT AND FILL SLOPES SHALL BE SEEDED OR MULCHED IMMEDIATELY AFTER THEIR CONSTRUCTION. NO AREA SHALL BE LEFT UNSTRABILIZED FOR A TIME PERIOD OF MORE THAN 30 DAYS.
- 23) DAILY, OR AS REQUIRED, CONSTRUCT, INSPECT, AND IF NECESSARY, RECONSTRUCT TEMPORAR BERMS, DRAINS, DITCHES, SILT FENCES AND SEDIMENT TRAPS INCLUDING MULCHING AND SEEDING.
- 24) BEGIN EXCAVATION FOR AND CONSTRUCTION OF TOWERS AND PLATFORMS.
- 25) FINISH PAVING ALL ROADWAYS, DRIVES, AND PARKING AREAS
- 26) COMPLETE PERMANENT SEEDING AND LANDSCAPING
- 27) NO FLOW SHALL BE DIVERTED TO ANY WETLANDS UNTIL A HEALTHY STAND OF GRASS HAS BEEN ESTABLISHED IN REGRADED AREAS.
- 28) AFTER GRASS HAS BEEN FULLY GERMINATED IN ALL SEEDED AREAS, REMOVE ALL TEMPORARY EROSION CONTROL MEASURES.

## IMPACT OF STORMWATER DURING CONSTRUCTION ACTIVITY

ALL SEDIMEN'T CONTROLS, INCLUDING SILTATION FENCES AND HAY BALES MUST BE INSPECTED WEEKLY OR IMMEDIATELY AFTER A STORMWATER RUNOFF GENERATING EVENT. ALL SEDIMENT CONTROLS MUST BE MAINTAINED IN AN EFFECTIVE CONDITION.

IN THE EVENT THAT STORMWATER IS FLOWING IN THE EXISTING/PROPOSED DRAINAGE SWALE, THE FOLLOWING MUST BE NOTED:

- 1) BY INSTALLING THE STORM DRAINAGE STARTING AT THE MOST DOWNGRADIENT LOCATION, AND BY CONSTRUCTION THE DITCH STARTING AT THE MOST DOWNGRADIENT LOCATION, STORMWATER FLOW WILL NOT BE IMPOUNDED DURING THE CONSTRUCTION ACTIVITY.
- 2) ADDITIONAL MEASURES MUST BE TAKEN DURING TIMES OF RAIN OR FLOW. THESE INCLUDE THE CESSATION OF ALL CONSTRUCTION ACTIVITY IN THE DRAINAGE SWALES AT TIMES OF "HEAVY RAIN" OR "SIGNIFICANT FLOW" WHICH HAVE THE POTENTIAL TO CAUSE SOIL SCOURING. IN THE ABSENCE OF AN ON SITE AGREEMENT WITH THE TOWN INLAND WETLANDS AGENT.

## CONSTRUCTION SPECIFICATIONS - SILT FENCE

- 1) THE GEOTEXTILE FABRIC SHALL MEET THE DESIGN CRITERIA FOR SILT FENCES.
- 2) THE FABRIC SHALL BE EMBEDDED A MINIMUM OF 8 INCHES INTO THE GROUND AND THE SOIL COMPACTED OVER THE EMBEDDED FABRIC.
- 3) WOVEN WIRE FENCE SHALL BE FASTENED SECURELY TO THE FENCE POSTS WITH WIRE TIES OR STAPLES.
- 4) FILTER CLOTH SHALL BE FASTENED SECURELY TO THE WOVEN WIRE FENCE WITH TIES SPACED EVERY 24 INCHES AT THE TOP, MID—SECTION AND BOTTOM.
- 5) WHEN TWO SECTIONS OF FILTER CLOTH ADJOIN EACH OTHER, THEY SHALL BE OVERLAPPED BY 6 INCHES, FOLDED, AND STAPLED.
- 6) FENCE POSTS SHALL BE A MINIMUM OF 36 INCHES LONG AND DRIVEN A MINIMUM OF 16 INCHES INTO THE GROUND. WOOD POSTS SHALL BE OF SOUND QUALITY HARDWOOD AND SHALL HAVE A MINIMUM CROSS SECTIONAL AREA OF 3.0 SQUARE INCHES.
- MAINTENANCE SHALL BE PERFORMED AS NEEDED TO PREVENT BULGES IN THE SILT FENCE DUE TO DEPOSITION OF SEDIMENT.

## MAINTENANCE - SILT FENCE

- 1) SILT FENCES SHALL BE INSPECTED IMMEDIATELY AFTER EACH RAINFALL AND AT LEAST DAILY DURING PROLONGED RAINFALL. ANY REPAIRS THAT ARE REQUIRED SHALL BE MADE
- 2) IF THE FABRIC ON A SILT FENCE SHOULD DECOMPOSE OR BECOME INEFFECTIVE DURING THE EXPECTED LIFE OF THE FENCE, THE FABRIC SHALL BE REPLACED PROMPTLY.
- 3) SEDIMENT SHOULD BE INSPECTED AFTER EVERY STORM EVENT. THE DEPOSITS SHOULD BE REMOVED WHEN THEY REACHED APPROXIMATELY ONE—HALF THE HEIGHT OF THE BARRIER.
- 4) SEDIMENT DEPOSITS THAT ARE REMOVED OR LEFT IN PLACE AFTER THE FABRIC HAS BEEN REMOVED SHALL BE GRADED TO CONFORM WITH THE EXISTING TOPOGRAPHY AND VEGETATED.

#### EROSION CONTROL MEASURES:

THE CONTRACTOR (TO BE NAMED PRIOR TO ANY WORK BEING PERFORMED) IS ASSIGNED THE RESPONSIBILITY FOR IMPLEMENTING THIS EROSION AND SEDIMENT CONTROL PLAN. THIS RESPONSIBILITY INCLUDES THE INSTALLATION AND MAINTENANCE OF CONTROL MEASURES, INFORMING ALL PARTIES ENGAGED ON THE CONSTRUCTION SITE OF THE REQUIREMENTS AND OBJECTIVES OF THE PLAN, NOTIFYING THE PLANNING AND ZONING OFFICE OF ANY TRANSFER OF THIS RESPONSIBILITY, AND FOR CONVEYING A COPY OF THE EROSION AND SEDIMENT CONTROL PLAN IF THE TITLE TO THE LAND IS TRANSFERRED.

- DISTURBED AREAS SHALL BE KEPT TO THE MINIMUM AREA NECESSARY TO CONSTRUCT THE ROADWAYS AND ASSOCIATED DRAINAGE FACILITIES.
- 2) HAY BALE BARRIERS AND SEDIMENT TRAPS SHALL BE INSTALLED AS REQUIRED. BARRIERS AND TRAPS ARE TO BE MAINTAINED AND CLEANED UNTIL ALL SLOPES HAVE A HEALTHY STAND OF GRASS.
- BALED HAY AND MULCH SHALL BE MOWINGS OF ACCEPTABLE HERBACEOUS GROWTH, FREE FROM NOXIOUS WEEDS OR WOODY STEMS, AND SHALL BE DRY. NO SALT HAY SHALL BE USED.
- 4) FILL MATERIAL SHALL BE FREE FROM STUMPS, WOOD, ROOTS, ETC.
- 5) STOCKPILED MATERIALS SHALL BE PLACED ONLY IN NON RESTRICTED WETLAND AREAS ON PLANS. STOCKPILES SHALL BE PROTECTED BY SILTATION FENCE AND SEEDED TO PREVENT EROSION. THESE MEASURES SHALL REMAIN UNTIL ALL MATERIAL HAS BEEN PLACED OR DISPOSED OFF SITE.
- 6) ALL DISTURBED AREAS SHALL BE LOAMED AND SEEDED. A MINIMUM OF 4 INCHES OF LOAM SHALL BE INSTALLED WITH NOT LESS THAN ONE POUND OF SEED PER 50 SQUARE YARDS OF AREA. SLOPES 2:1 OR GRATED TO BE STABILISED WITH TURF REINFORCEMENT MAT TYPE P300P NORTH AMERICAN GREEN
- 7) APPLICATION OF GRASS SEED, FERTILIZERS AND MULCH SHALL BE ACCOMPLISHED BY BROADCAST SEEDING OR HYDROSEEDING AT THE RATES OUTLINED BELOW:

LIMESTONE: 75-100 LBS./1,000 SQUARE FEET.
FFRTILIZER: RATE RECOMMENDED BY MANUFACTURER.

SEED MIX (SLOPES LESS THAN 4:1)
CREEPING RED FESCUE
TALL FESCUE
RED TOP LBS./ACRE

SLOPE MIX (SLOPES GREATER TAN 4:1)
CREEPING RED FESCUE
TALL FESCUE

- 8) AFTER ALL DISTURBED AREAS HAVE BEEN STABILIZED THE TEMPORARY EROSION CONTROL MEASURES ARE TO BE REMOVED.
- 9) PAVED ROADWAYS MUST BE KEPT CLEAN AT ALL TIMES.
- 10) ALL CATCH BASIN INLETS WILL BE PROTECTED WITH LOW POINT SEDIMENTION BARRIEFS.
- 11) ALL STORM DRAINAGE OUTLETS WILL BE STABILIZED AND CLEANED AS REQUIRED, BEFORE THE DISCHARGE POINTS BECOME OPERATIONAL
- 12) ALL DEWATERING OPERATIONS MUST DISCHARGE DIRECTLY INTO A SEDIMENT FILTER AREA.
- NO DISCHARGE SHALL BE DIRECTED TOWARDS ANY PROPOSED DITCHES, SWALES, OR PONDS UNTIL THEY HAVE BEEN PROPERLY STABILIZED.

# CONSTRUCTION SPECIFICATIONS - STRAW OR HAY BALES

1) BALES SHALL BE PLACED IN A ROW WITH THE ENDS TIGHTLY ADJOINING

- 2) EACH BALE SHALL BE EMBEDDED IN THE GROUND A MINIMUM OF 4 INCHES.
- BALES SHALL BE ANCHORED IN PLACE BY AT LEAST TWO STAKES DRIVEN THROUGH THE BALE. THE STAKES SHALL BE DRIVEN AT LEAST 18 INCHES INTO THE GROUND.
- BARRIERS SHALL BE INSPECTED AFTER EVERY RAINFALL AND PROMPTLY REPAIRED FOR REPLACED AS NECESSARY.
- 5) BALES SHALL BE REMOVED WHEN NO LONGER NEEDED AND THE SEDIMENT COLLECTED SHALL BE DISPOSED OF PROPERLY.

# MAINTENANCE - STRAW OR HAY BALES

- STRAW OR HAY BALES SHALL BE INSPECTED IMMEDIATELY AFTER EACH RAINFALL AND AT LEAST DAILY DURING PROLONGED RAINFALL.
- 2) CLOSE ATTENTION SHALL BE PAID TO THE REPAIR OF DAMAGED BALES, UNDERCUTTING BENEATH THE BALES, AND FLOW AROUND THE END OF THE BALES.
- NECESSARY REPAIRS OR REPLACEMENT OF BALES SHALL BE ACCOMPLISHED PROMPTLY.
- 4) SEDIMENT DEPOSITS SHOULD BE CHECKED AFTER EACH RAINFALL. THE DEPOSITS SHOULD BE REMOVED WHEN THE LEVEL OF DEPOSITION REACHES APPROXIMATELY ONE—HALF OF THE HEIGHT OF THE TABLE.
- 5) SEDIMENT DEPOSITS THAT ARE REMOVED OR LEFT IN PLACE AFTER THE BARRIER HAS BEEN DISMANTLED SHALL BE GRADED TO CONFORM WITH THE EXISTING TOPOGRAPHY AND VEGETATED USING THE APPROPRIATE VEGETATIVE BMP.



500 ENTERPRISE DRIVE ROCKY HILL, CT 06067

Hudson Desig.



BUILDING 20 NORTH, SUITE 2-101 N. ANDOVER, MA 01845

ENGINEER/LAND SURVEYOR

IT IS A VIOLATION OF LAW FOR ANY PERSON UNLESS THEY ARE ACTING UNDER THE DIRECTION OF A LICENSED PROFESSIONAL ENGINEER, TO ALTER THIS DOCUMENT.

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	REVISIONS				
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			REVISE ACCESS EASEMEN & COMPOUND		
ı	2	04/13/10	REVISE SHELTER DETAILS		
I	1	03/31/10	REVISE EASEMENTS		
l	0	03/09/10	ISSUED FOR REVIEW		
ľ	REV. #	DATE	DESCRIPTION		

DESIGNED BY: DC SCALE AS SHOWN CHECK'D BY: DPH

SITE NAME:

1257-AVON

SITE ADDRESS:


224 LOVELY STREET AVON, CT 06067


DRAWING TITLE:


**EROSION CONTROL NOTES** AND DETAILS

DRAWING NO:

MAKE ALL CONNECTIONS AS PER UTILITY COMPANY'S REQUIREMENTS.

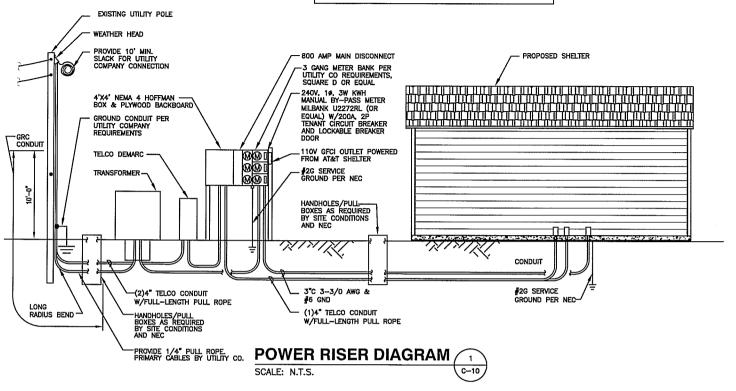

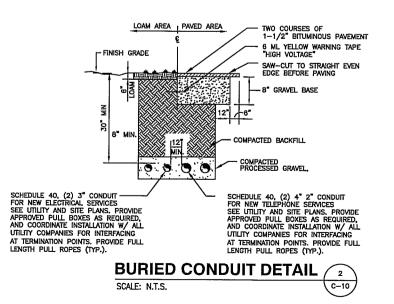

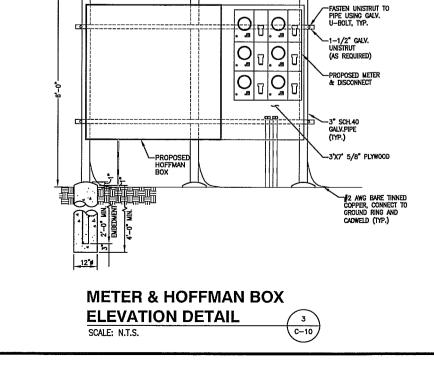



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Hudson Design Groupus



1600 OSGOOD STREET BUILDING 20 NORTH, SUITE 2-101 N. ANDOVER, MA 01845

TEL: (978) 557-5553 FAX: (978) 336-5586

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REVISIONS				
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PROJECT NO.	DESIGNED BY:	DC	SCALE:
	DRAWN BY:	58	AS SHOWN
	CHECK'D BY:	DPH	1

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224 LOVELY STREET AVON, CT 06067

DRAWING TITLE:

ELECTRICAL RISER AND DETAILS

DRAWING NO:

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