



GPS AND ANTENNA DETAIL C

NOTE:
STOCKADE FENCE TO BE
WALPOLE WOODWORKER SHADOW
BOX STYLE, OR APPROVED
EQUAL



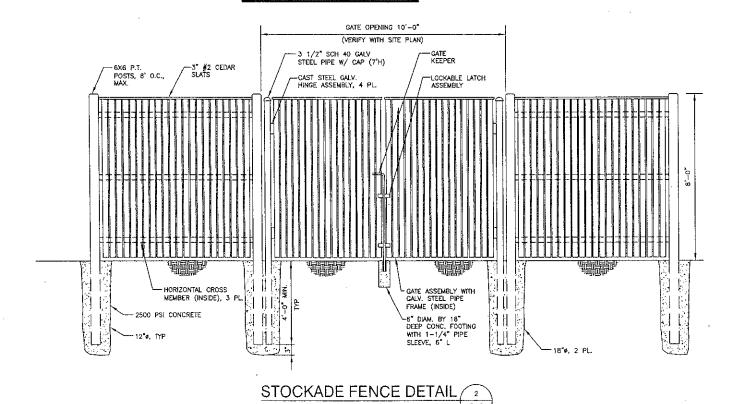

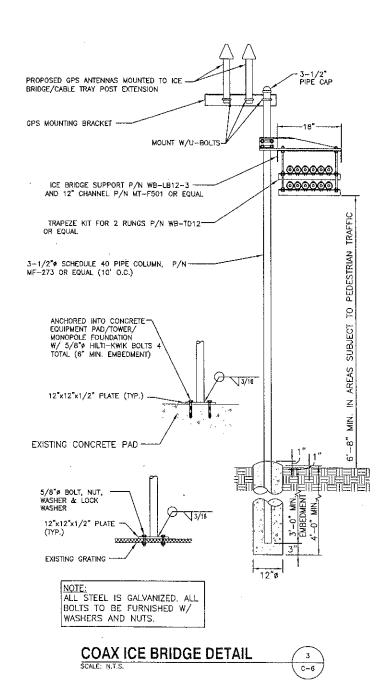

500 ENTERPRISE DRIVE ROCKY HILL, CT 06067

Hudson Design Groupes



1600 OSGOOD STREET BUILDING 20 NORTH, SUITE 2-101 N. ANDOVER, MA 01845

EL: (978) 557-5553 AX: (978) 336-5586

OF CONNECTION OF

ENGINEER/LAND SURVEYOR

IT IS A VIOLATION OF LAW FOR ANY PERSON, UNLESS THEY ARE ACTING UNDER THE DIRECTION OF A LICENSED PROFESSIONAL ENGINEER, TO ALTER THIS DOCUMENT.

REVISIONS					
*					
	_				
2	04/13/10	REVISE SHELTER DETAILS			
11	03/31/10	REVISE EASEMENTS			
0	03/09/10	ISSUED FOR REVIEW			
REV.#	DATÉ	DESCRIPTION			

PROJECT NO. DESIGNED 81; DC SCALE:

DRAWN 81; S8 AS SHOWN
CHECK'D 81; DPH

SITE NAME:

1257-AVON

SITE ADDRESS:


224 LOVELY STREET AVON, CT 06067

DRAWING TITLE:

DETAILS


DRAWING NO:

C-6

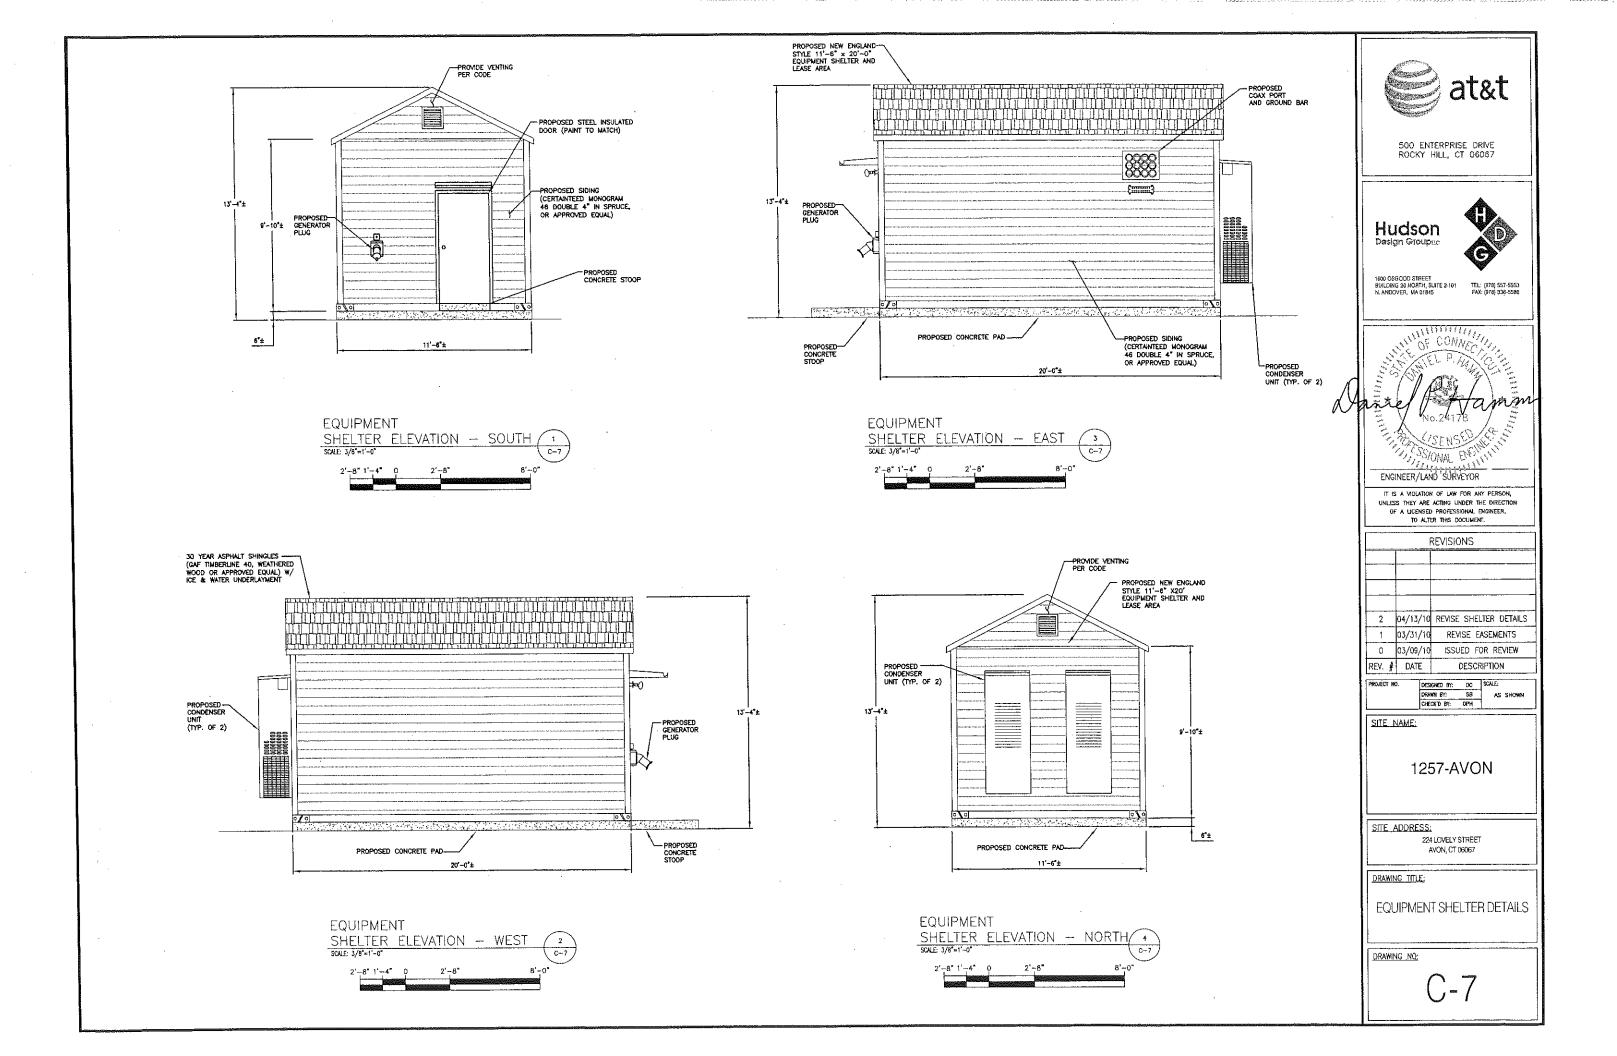


## FOUNDATION NOTES & CONCRETE SPECIFICATIONS


- FOUNDATION AREA SHALL BE EXCAVATED TO THE DEPTH AND DIMENSIONS SHOWN ON THE PLANS. EXISTING LEDGE AND ALL OTHER EXISTING UNSUITABLE MATERIAL SHALL BE REMOVED AND LEGALLY DISPOSED OF OFF-SITE. THE SUBGRADE SHALL BE ROLLED WITH A 1-TON, VIBRATORY, WALK-BEHIND ROLLER AT A SPEED OF LESS THAN 2 FPS, 6 PASSES MINIMUM, TO PROVIDE LINYIELDING SURFACE.
- UNDERCUT SOFT OR "WEAVING" AREAS A MINIMUM OF 12 INCHES DEEP, BACKFILL UNDERCUT AREA WITH FILL MEETING THE SPECIFICATIONS OF STRUCTURAL FILL (SEE NOTE #3)
- 3. CONCRETE TO HAVE A MINIMUM 28 DAY COMPRESSIVE STRENGTH (f'c)=4000 PSI, CONCRETE TO BE AIR ENTRAINED, DESIRED AIR CONTENT TO BE 6% (PLUS OR MINUS 2%)
- 4. BAR REINFORCING TO BE ASTM A615 GRADE 60.
- 5. WELDED WIRE FABRIC TO CONFORM TO THE REQUIREMENTS OF ASTM A185. WIRES FOR FABRIC TO CONFORM TO THE REQUIREMENTS OF ASTM A82.
- 6. COORDINATE WITH MANUFACTURER OF PREFABRICATED SHELTER FOR LOCATION
- 7. ALL REINFORCING TO HAVE 2" MINIMUM CONCRETE COVER.
- 8. ALL CONCRETE MATERIALS AND WORKMANSHIP SHALL CONFORM TO LATEST EDITION OF ACI 318 BUILDING CODE AND BOCA NATIONAL BUILDING CODE.

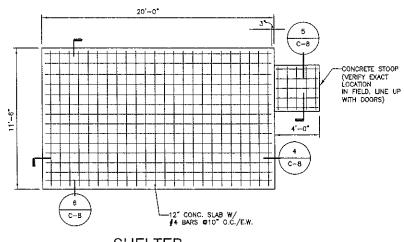


**SHELTER** FOUNDATION PLAN

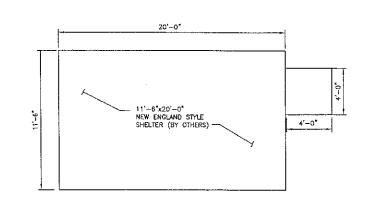


SHELTER PLAN

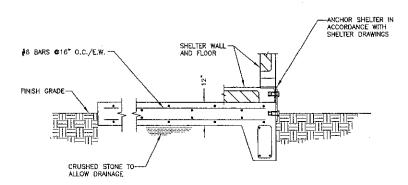


**CONCRETE SLAB CONNECTION DETAIL** SCALE: N.T.S. C~8

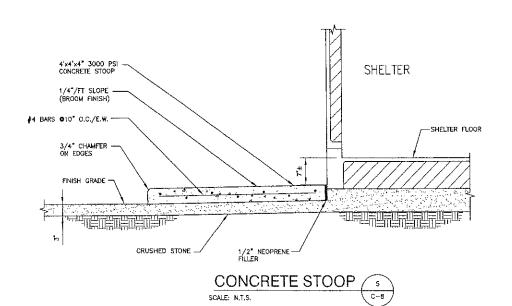

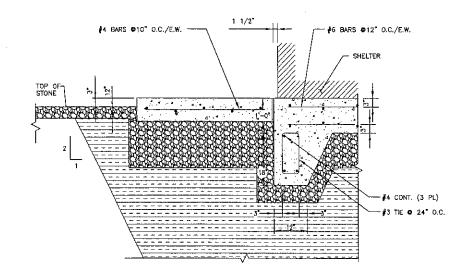



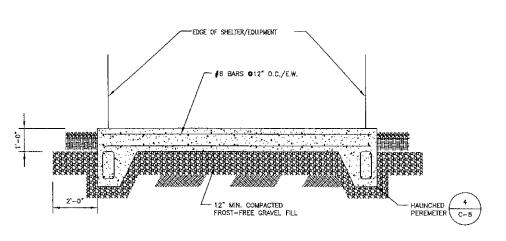


SECTION /



500 ENTERPRISE DRIVE ROCKY HILL, CT 06067

Hudson



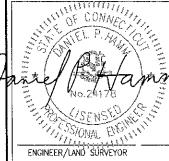

IT IS A VIOLATION OF LAW FOR ANY PERSON, UNLESS THEY ARE ACTING UNDER THE DIRECTION OF A LICENSED PROFESSIONAL ENGINEER, TO ALTER THIS DOCUMENT.

REVISIONS					
2	04/13/10	REVISE SHELTER DETAILS			
1	03/31/10	REVISE EASEMENTS			
0	03/09/10	ISSUED FOR REVIEW			
EV. #	DATE	DESCRIPTION			

DESKONED BY: DC S DRAWN BY: SB

SITE NAME:

1257-AVON


SITE ADDRESS:

224 LOVELY STREET AVON, CT 06067

DRAWING TITLE:


SHELTER FOUNDATION & PAD DETAILS


DRAWING NO:

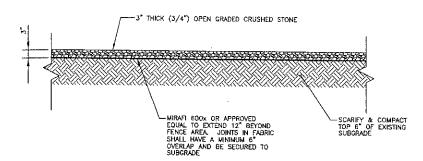







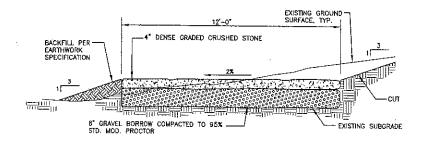

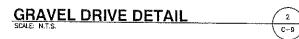

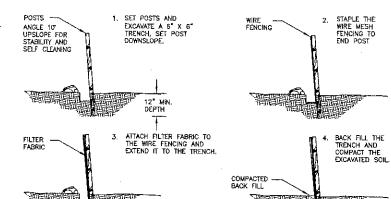



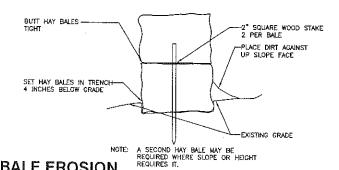

HAYBALE EROSION CONTROL BARRIER

(4 C-9

#### EROSION CONTROL

#### CONSTRUCTION SEQUENCE

- NOTIFY THE TOWN INLAND WETLANDS AGENT AT LEAST ONE WEEK PRIOR TO THE PRE-CONSTRUCTION MEETING.
- COMPLETE A "CALL BEFORE YOU DIG" PRIOR TO ANY ON SITE ACTIVITY. RECALL EVERY 30 DAYS.
- 3) CUT AND STUMP AREAS OF PROPOSED CONSTRUCTION
- 4) INSTALL TEMPORARY SEDIMENT AND EROSION CONTROL MEASURES AS REQUIRED.
- 5) WOOD CHIPS GENERATED FROM CLEARING ACTIVITIES MAY BE USED AS A TEMPORARY STABILIZATION MEASURE IN ADDITION TO SILT FENCING & HAY BALES.
- 6) INSTALL HAY BALES TO "BACK UP" SILTATION FENCE ALONG ALL DOWNGRADIENT WETLANDS BOUNDARIES.
- 7) ESTABLISH ROADWAY CENTERLINE WITH GRADE STAKES AND OFF SETS.
- 8) STOCKPILE EXCAVATED SOILS A MINIMUM OF 75 FEET FROM ANY WETLAND AREA.
- 9) CONSTRUCT CLOSED DRAINAGE SYSTEM. PROTECT CULVERT INLETS WITH SEDIMENTATION BARRIERS.
- 10) ROUGH GRADE DITCH STARTING FROM THE DOWNGRADIENT LOCATION
- 11) INSTALL STONE LINING AND LEVEL SPREADERS AT CULVERT OUTLETS
- 12) STABILIZE GRADED SLOPES
- 1.3) CONSTRUCT ROADWAYS AND PERFORM SITE GRADING, PLACING HAY BALES AND SILTATION FENCES AS REQUIRED TO CONTROL SOIL EROSION.
- 14) EXCAVATE FOR ANY SUBSURFACE UTILITIES.
- 15) STOCKPILE EXCAVATED SOILS A MINIMUM OF 75 FEET FROM ANY WETLAND AREA.
- 16) ESTABLISH SEDIMENT AND EROSION CONTROLS AROUND STOCKPILE SOILS.
- 17) INSTALL UTILITY SERVICES
- 18) INSTALL STORM DRAINAGE STARTING AT THE MOST DOWNGRADIENT LOCATION.
- 19) INSTALL ALL RIP RAP AT OUTLETS FOR STORM DRAINAGE.
- 20) INSTALL HAY BALE PROTECTION TO STORM DRAINAGE INLETS.
- 21) INSTALL ROAD
- 22) BEGIN TEMPORARY AND PERMANENT SEEDING AND MULCHING. ALL CUT AND FILL SLOPES SHALL BE SEEDED OR MULCHED IMMEDIATELY AFTER THEIR CONSTRUCTION. NO AREA SHALL BE LEFT UNSTABILIZED FOR A TIME PERIOD OF MORE THAN 30 DAYS.
- 23) DALLY, OR AS REQUIRED, CONSTRUCT, INSPECT, AND IF NECESSARY, RECONSTRUCT TEMPORARY BERMS, DITCHES, SILT FENCES AND SEDIMENT TRAPS INCLUDING MULCHING AND SECONG.
- 24) BEGIN EXCAVATION FOR AND CONSTRUCTION OF TOWERS AND PLATFORMS.
- 25) FINISH PAVING ALL ROADWAYS, DRIVES, AND PARKING AREAS.
- 26) COMPLETE PERMANENT SEEDING AND LANDSCAPING.
- 27) NO FLOW SHALL BE DIVERTED TO ANY WETLANDS UNTIL A HEALTHY STAND OF GRASS HAS BEEN ESTABLISHED IN REGRADED AREAS.
- 28) AFTER GRASS HAS BEEN FULLY GERMINATED IN ALL SEEDED AREAS, REMOVE ALL TEMPORARY EROSION CONTROL MEASURES.

## IMPACT OF STORMWATER DURING CONSTRUCTION ACTIVITY

ALL SEDIMENT CONTROLS, INCLUDING SILTATION FENCES AND HAY BALES MUST BE INSPECTED WEEKLY OR IMMEDIATELY AFTER A STORMWATER RUNOFF GENERATING EVENT. ALL SEDIMENT CONTROLS MUST BE MAINTAINED IN AN EFFECTIVE CONDITION.

IN THE EVENT THAT STORMWATER IS FLOWING IN THE EXISTING/PROPOSED DRAINAGE SWALE, THE FOLLOWING MUST BE NOTED:

- BY INSTALLING THE STORM DRAINAGE STARTING AT THE MOST DOWNGRADIENT LOCATION, AND BY CONSTRUCTION THE DITCH STARTING AT THE MOST DOWNGRADIENT LOCATION, STORMWATER FLOW MILL NOT BE IMPOUNDED DURING THE CONSTRUCTION ACTIVITY.
- 2) ADDITIONAL MEASURES MUST BE TAKEN DURING TIMES OF RAIN OR FLOW. THESE INCLUDE THE CESSATION OF ALL CONSTRUCTION ACTIVITY IN THE DRAINAGE SYALES AT TIMES OF "HEAVY RAIN" OR "SIGNIFICANT FLOW" WHICH HAVE THE POTENTIAL TO CAUSE SOIL SCOURING. IN THE ABSENCE OF AN ON SITE AGREEMENT WITH THE TOWN INLAND WETLANDS AGENT.

### CONSTRUCTION SPECIFICATIONS - SILT FENCE

- 1) THE GEOTEXTILE FABRIC SHALL MEET THE DESIGN CRITERIA FOR SILT FENCES.
- THE FABRIC SHALL BE EMBEDDED A MINIMUM OF 8 INCHES INTO THE GROUND AND THE SOIL COMPACTED OVER THE EMBEDDED FABRIC.
- WOVEN WIRE FENCE SHALL BE FASTENED SECURELY TO THE FENCE POSTS WITH WIRE TIES OR STAPLES.
- FILTER CLOTH SHALL BE FASTENED SECURELY TO THE WOVEN WIRE FENCE WITH TIES SPACED EVERY 24 INCHES AT THE TOP, MID-SECTION AND BOTTOM.
- WHEN TWO SECTIONS OF FILTER CLOTH ADJOIN EACH OTHER, THEY SHALL BE OVERLAPPED BY 6 INCHES, FOLDED, AND STAPLED.
- 6) FENCE POSTS SHALL BE A MINIMUM OF 36 INCHES LONG AND DRIVEN A MINIMUM OF 16 INCHES INTO THE GROUND, WOOD POSTS SHALL BE OF SOUND QUALITY HARDWOOD AND SHALL HAVE A MINIMUM CROSS SECTIONAL AREA OF 3.0 SQUARE INCHES.
- 7) MAINTENANCE SHALL BE PERFORMED AS NEEDED TO PREVENT BULGES IN THE SILT FENCE DUE TO DEPOSITION OF SEDIMENT.

#### MAINTENANCE - SILT FENCE

- SILT FENCES SHALL BE INSPECTED IMMEDIATELY AFTER EACH RAINFALL AND AT LEAST DAILY DURING PROLONGED RAINFALL ANY REPAIRS THAT ARE REQUIRED SHALL BE MADE IMMEDIATELY.
- IF THE FABRIC ON A SILT FENCE SHOULD DECOMPOSE OR BECOME INEFFECTIVE DURING THE EXPECTED LIFE OF THE FENCE, THE FABRIC SHALL BE REPLACED PROMPTLY.
- 3) SEDIMENT SHOULD BE INSPECTED AFTER EVERY STORM EVENT, THE DEPOSITS SHOULD BE REMOVED WHEN THEY REACHED APPROXIMATELY ONE—HALF THE HEIGHT OF THE BARRIER.
- 4) SEDIMENT DEPOSITS THAT ARE REMOVED OR LEFT IN PLACE AFTER THE FABRIC HAS BEEN REMOVED SHALL BE GRADED TO CONFORM WITH THE EXISTING TOPOGRAPHY AND VEGETATED.

#### EROSION CONTROL MEASURES:

THE CONTRACTOR (TO BE NAMED PRIOR TO ANY WORK BEING PERFORMED) IS ASSIGNED THE RESPONSIBILITY FOR IMPLEMENTING THIS EROSION AND SEDIMENT CONTROL PLAN. THIS RESPONSIBILITY INCLUDES THE INSTALLATION AND MAINTENANCE OF CONTROL MEASURES, INFORMING ALL PARTIES ENGAGED ON THE CONSTRUCTION STOFF OF THE REQUIREMENTS AND OBJECTIVES OF THE PLAN, NOTIFYING THE PLANNING AND ZONING OFFICE OF ANY TRANSFER OF THIS RESPONSIBILITY, AND FOR CONVEYING A COPY OF THE EROSION AND SEDIMENT CONTROL PLAN IF THE TITLE TO THE LAND IS TRANSFERRED.

- DISTURBED AREAS SHALL BE KEPT TO THE MINIMUM AREA NECESSARY
   TO CONSTRUCT THE ROADWAYS AND ASSOCIATED DRAINAGE FACILITIES.
- HAY BALE BARRIERS AND SEDIMENT TRAPS SHALL BE INSTALLED AS REQUIRED. BARRIERS AND TRAPS ARE TO BE MAINTAINED AND CLEANED UNTIL ALL SLOPES HAVE A HEALTHY STAND OF GRASS.
- BALED HAY AND MULCH SHALL BE MOWINGS OF ACCEPTABLE HERBACEOUS GROWTH, FREE FROM NOXIOUS WEEDS OR WOODY STEMS, AND SHALL BE DRY. NO SALT HAY SHALL BE USED.
- 4) FILL MATERIAL SHALL BE FREE FROM STUMPS, WOOD, ROOTS, ETC.
- 5) STOCKPILED MATERIALS SHALL BE PLACED ONLY IN NON RESTRICTED WETLAND AREAS ON PLANS. STOCKPILES SHALL BE PROTECTED BY SILTATION FENCE AND SEEDED TO PREVENT EROSION. THESE MEASURES SHALL REMAIN UNTIL ALL MATERIAL HAS BEEN PLACED OR DISPOSED OFF SITE.
- 6) ALL DISTURBED AREAS SHALL BE LOAMED AND SEEDED. A MINIMUM OF 4 INCHES OF LOAM SHALL BE INSTALLED WITH NOT LESS THAN ONE POUND OF SEED PER 50 SQUARE YARDS OF AREA. SLOPES 2:1 OR GRATED TO BE STABILISED WITH TURE REINFORCEMENT MAT TYPE P300P NORTH AMERICAN GREEN (1-800-772-2040), OR ENGINEER APPROVED EQUAL.
- 7) APPLICATION OF GRASS SEED, FERTILIZERS AND MULCH SHALL BE ACCOMPLISHED BY BROADCAST SEEDING OR HYDROSEEDING AT THE RATES OUTLINED BELOW:

LMESTONE: 75-100 LBS./1,000 SQUARE FEET.
FERTILIZER: RATE RECOMMENDED BY MANUFACTURER.
MULCH: HAY MULCH APPROXIMATELY 3 TONS/ACRE UNLESS
EROSION CONTROL MATTING IS USED.

SEED\_MIX (SLOPES LESS THAN 4:1)
CREEPING RED FESCUE
20
21

- 8) AFTER ALL DISTURBED AREAS HAVE BEEN STABILIZED THE TEMPORARY EROSION CONTROL MEASURES ARE TO BE REMOVED.
- 9) PAVED ROADWAYS MUST BE KEPT CLEAN AT ALL TIMES.
- 10) ALL CATCH BASIN INLETS WILL BE PROTECTED WITH LOW POINT SEDIMENTION BARRIER.
- ALL STORM DRAINAGE OUTLETS WILL BE STABILIZED AND CLEANED AS REQUIRED, BEFORE THE DISCHARGE POINTS BECOME OPERATIONAL.
- ALL DEWATERING OPERATIONS MUST DISCHARGE DIRECTLY INTO A SEDIMENT FILTER AREA.
- 13) NO DISCHARGE SHALL BE DIRECTED TOWARDS ANY PROPOSED DITCHES, SWALES, OR PONDS UNTIL THEY HAVE BEEN PROPERLY STABILIZED.

## CONSTRUCTION SPECIFICATIONS - STRAW OR HAY BALES

- 1) BALES SHALL BE PLACED IN A ROW WITH THE ENDS TIGHTLY ADJOINING.
- 2) EACH BALE SHALL BE EMBEDDED IN THE GROUND A MINIMUM OF 4 INCHES.
- BALES SHALL BE ANCHORED IN PLACE BY AT LEAST TWO STAKES DRIVEN THROUGH THE BALE. THE STAKES SHALL BE DRIVEN AT LEAST 16 INCHES INTO THE GROUND.
- BARRIERS SHALL BE INSPECTED AFTER EVERY RAINFALL AND PROMPTLY REPAIRED FOR REPLACED AS NECESSARY.
- BALES SHALL BE REMOVED WHEN NO LONGER NEEDED AND THE SEDIMENT COLLECTED SHALL BE DISPOSED OF PROPERLY.

#### MAINTENANCE - STRAW OR HAY BALES

- STRAW OR HAY BALES SHALL BE INSPECTED IMMEDIATELY AFTER EACH RAINFALL AND AT LEAST DAILY DURING PROLONGED RAINFALL.
- CLOSE ATTENTION SHALL BE PAID TO THE REPAIR OF DAMAGED BALES, UNDERCUTTING BENEATH THE BALES, AND FLOW AROUND THE END OF THE BALES.
- 3) NECESSARY REPAIRS OR REPLACEMENT OF BALES SHALL BE ACCOMPLISHED PROJECTLY
- 4) SEDIMENT DEPOSITS SHOULD BE CHECKED AFTER EACH RANFALL THE DEPOSITS SHOULD BE REMOVED WHEN THE LEYEL OF DEPOSITION REACHES APPROXIMATELY ONE-HALF OF THE HEIGHT OF THE TABLE.
- 5) SEDIMENT DEPOSITS THAT ARE REMOVED OR LEFT IN PLACE AFTER THE BARRIER HAS BEEN DISMANTLED SHALL BE GRADED TO CONFORM WITH THE EXISTING TOPOGRAPHY AND VEGETATED USING THE APPROPRIATE VEGETATIVE BMP.



500 ENTERPRISE DRIVE ROCKY HILL, CT 06067

Hudson Design Groupus



1600 OSGOOD STREET BUILDING 20 NORTH, SUITE 2-101 N. ANDOVER, MA 01845

of CONNECTION OF

ENGINEER/LAND SÜRVEYOR

IT IS A VIOLATION OF LAW FOR ANY PERSON, UNLESS THEY ARE ACTING UNDER THE DIRECTION OF A LICENSED PROFESSIONAL ENGINEER, TO ALTER THIS DOCUMENT.

PONAL

REVISIONS

2 04/13/10 REVISE SHELTER DETAILS
1 03/31/10 REVISE EASEMENTS
0 03/09/10 ISSUED FOR REVIEW
REV. # DATE DESCRIPTION

PROJECT NO. DESKONED BY: DC SCALE:

DRAWN BY: SB AS SHOWN
CHECK'D BY: DPH

SITE NAME:

1257-AVON

SITE ADDRESS:

224 LOVELY STREET AVON, CT 06067

DRAWING TITLE:


EROSION CONTROL NOTES
AND DETAILS

DRAWING NO:


C-9

MAKE ALL CONNECTIONS AS PER UTILITY COMPANY'S REQUIREMENTS EXISTING UTILITY POLE - PROVIDE 10' MIN. SLACK FOR LITILITY COMPANY CONNECTION - 800 AMP MAIN DISCONNECT - PROPOSED SHELTER -3 GANG METER BANK PER UTILITY CO REQUIREMENTS, SQUARE D OR EQUAL 240V. 16, 3W KWH
MANUAL BY-PASS METER
MILBANK U2272RL (OR
EGUAL) W/200A, 2P
TENANT CIRCUIT BREAKER
AND LOCKABLE BREAKER
DOOR 4'X4' NEMA 4 HOFFMAN — BOX & PLYWOOD BACKBOARD GRC CONDUIT 110V GFCI OUTLET POWERED FROM AT&T SHELTER TELCO DEMARC -#2G SERVICE GROUND PER NEC TRANSFORMER. HANDHOLES/PULL——BOXES AS REQUIRED BY SITE CONDITIONS AND NEC CONDUIT \_\_\_ 3°C 3−3/0 A₩G & #6 GND -(2)4" TELCO CONDUCT #2G SERVICE GROUND PER NEC-W/FULL-LENGTH PULL ROPE (1)4" TELCO CONDUIT

POWER RISER DIAGRAM

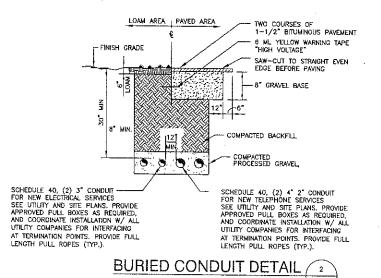

NOTE:
DETAIL AS SHOWN IS FOR
SECONDARY ELECTRIC SERVICE.
PRIMARY HIGH VOLTAGE SERVICE.
REQUIRES 4" CONCRETE
ENCASEMENT.

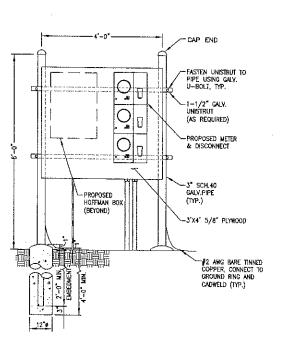

METER & HOFFMAN BOX ELEVATION DETAIL

SCALE: N.T.S.






500 ENTERPRISE DRIVE ROCKY HILL, CT 06067

Hudson Design Groups



1600 OSGOOD STREET BUILDING 20 NORTH, SUITE 2-101 N. ANDOVER, MA 01845

TEL: (978) 557-5553 FAX: (978) 336-5586

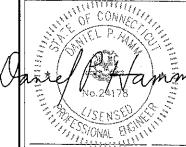

ENGINEER/LAND SÜRVEYOR

IT IS A VIOLATION OF LAW FOR MY PERSON, UNLESS THEY ARE ACTING UNDER THE DIRECTION OF A LIGENSED PROFESSIONAL ENGINEER, TO ALTER THIS DOCUMENT.

ĺ		REVISIONS			
	ļ				
	<u> </u>	0. ( /			
i	2	04/13/10	REVISE SHELTER DETAILS		
	1	03/31/10	REVISE EASEMENTS		
	0	03/09/10	ISSUED FOR REVIEW		
	REV. #	DATE	DESCRIPTION		

PROJECT NO. DESKAND BY: DC SCALE:

DRAWN BY: SB AS SHOWN
OHECK'D BY: DPH

SITE NAME:

1257-AVON

SITE ADDRESS:


224 LOVELY STREET AVON, CT 06067


DRAWING TITLE:

ELECTRICAL RISER AND DETAILS

DRAWING NO:

C-10

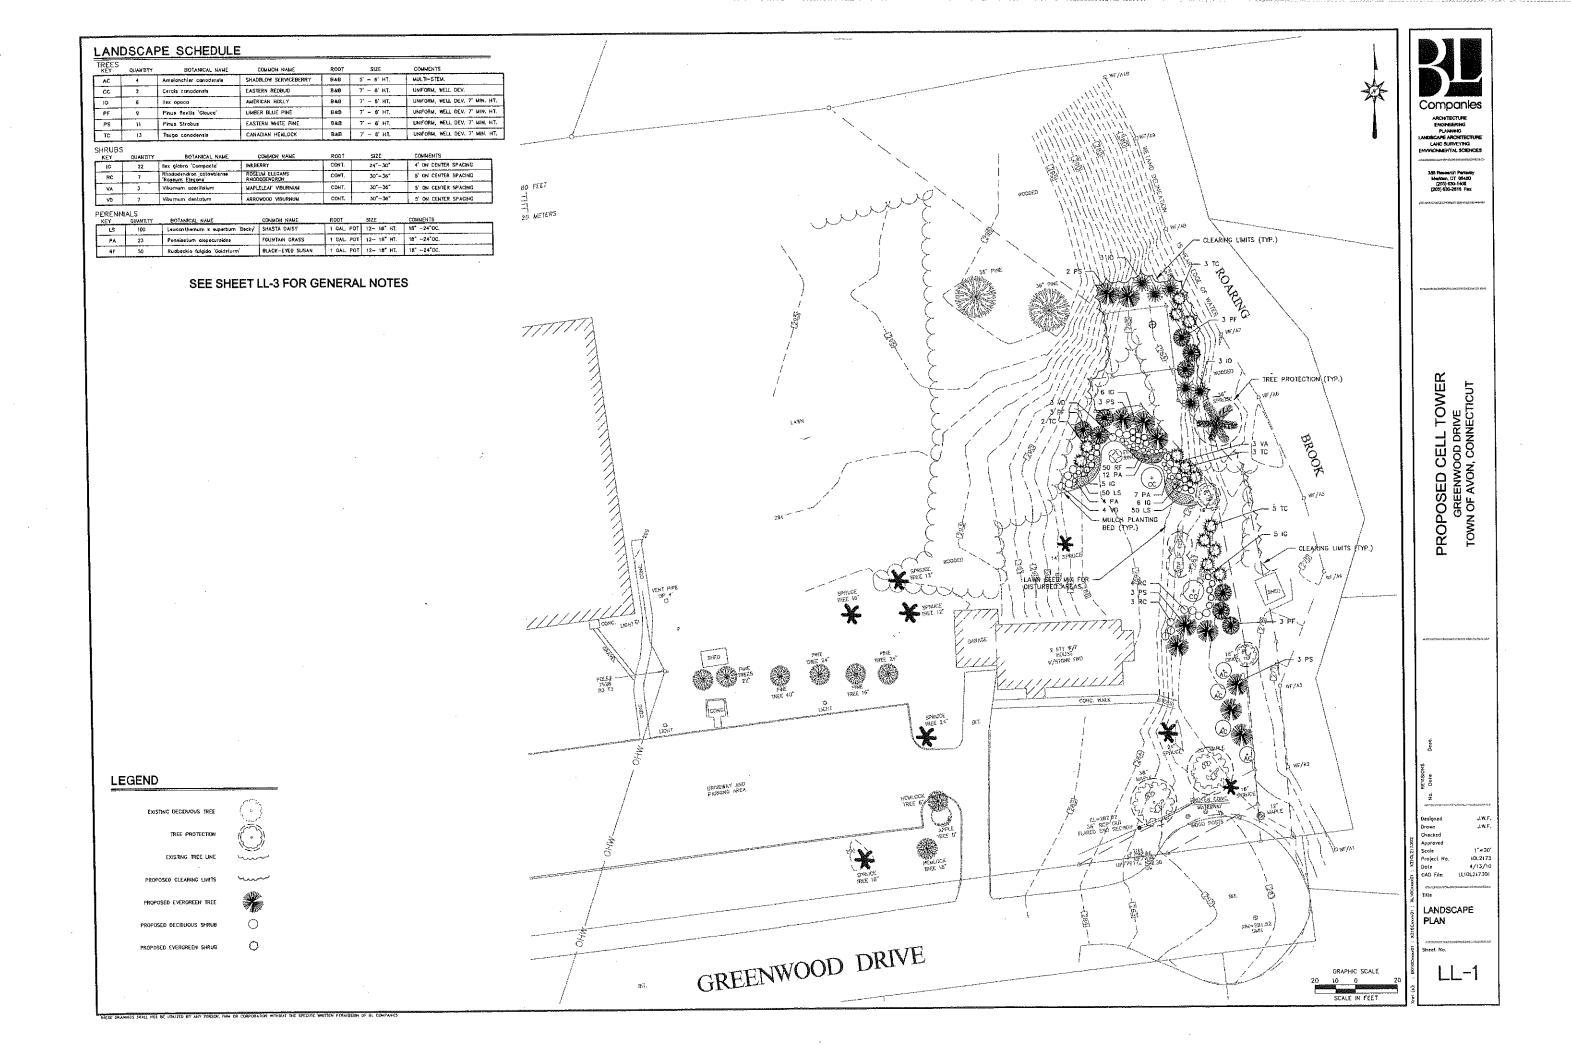

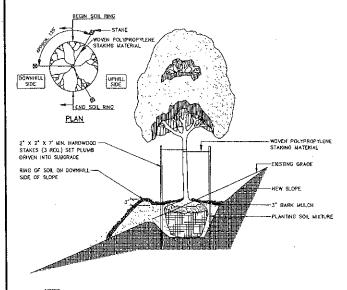


NOTES:

1. THIS DETAIL SHALL APPLY TO TREE PLANTING ON 3M:1V SLOPES OR STEEPER UNLESS
OTHERWISE DIRECTED BY OWNER OR OWNER'S REPRESENTATIVE. DECIDIOUS THEES 2 X CAL. OR
GREATER, ALL EVEROREEN TREES 6 FT. OR GREATER, AND MULTI-STEMMED TREES 6 FT. OR
GREATER AT HEIGHT SHALL BE STAKED AS SHOWN.

3. WOVEN POLYPROPHIENE STAKING MATERIAL SHALL BE DEEPROOT ARBORTIE (GREEN) OR APPROVED EQUIVALENT. INSTALL SPECIFIED MATERIAL IN ACCORDANCE WITH MANUFACTURER'S DIRECTIONS.


## TREE SLOPE PLANTING

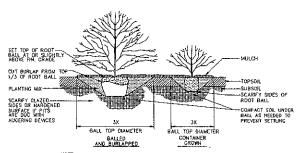

NOTE:

IN AREAS OF MASS PLANTING, CONTINUOUSLY EXCAVATE AND MULCH ENTIRE BED.

# SHRUB PLANTING

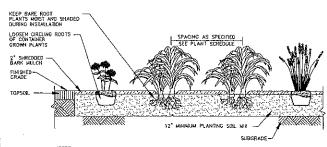

NUIES:

1. ROTOTHLE FERTILIZER, LIME, AND OTHER AMENDMENTS INTO SOIL PRIOR TO PLANTING AND IN ACCORDANCE WITH SOIL ANALYSIS RECOMMENDATIONS

- 2. THOROUGHLY WATER ALL PLANTING BEDS IMMEDIATELY AFTER PLANTING
- 3. ADJUST BULB PLANTING DEPTH AS RECOMMENDED BY BULB SUPPLIER.


## ANNUAL/PERENNIAL AND GROUNDCOVER BEDS

WHAS SHALL NOT BE WINDED BY ANY PERSON, FRIM ON CORPORATION WITHOUT THE SPECIFIC WRITTEN PERMISSION OF BE COMPANIE


#### **SEEDING MIXTURES**

- A. LAWN SEEDING MIKTURE LOFTS SEED COMPANY OR APPROVED EQUAL 15 X PERENNAL RYCEARSS (BLEND OF 3 IMPROVED HYBRIDS) 25 X FINE LEAF OR CREENIN FESCUE (BLEND OF 3 IMPROVED HYBRIDS) 60 X KENTURKY BLUCGRASS (BLEND OF 3 IMPROVED HYBRIDS) SEEDING RATE: S LIBS/1,000 S COTTOBER 1 AND APRIL 15 JUNE 15, UMALES O THEORISE APPROVED BY ORNER.
- UNLESS OTHERWISE APPROVED BY OWNER.

  8. SLOPE SEEDING MIXTURE (3:1 SLOPES OR GREATER)
  CREEPING RED FESSUE (FESTUEA RUBBA) (42X)
  EXPRESS PEREMIAL RYGERASS (LOUIUM PERENNE) (34X)
  BIRDSTOOT THEFOR. (LOUIS CORMINIOUTUS VAR. ARVENSE) (8X)
  ALSKE CLOVER (RIPFOLIUM HYBRIDUM) (8X)
  RED TOO (AROESTIS GLANTEA) (8X)
  LEGUMINOUS SEED TO BE INDOLLATED
  APPLICATION FASTES 13.85/000 SF.
  FERTILIZER TYPE: 10-20-20
  FERTILIZER TYPE: 10-20-20
  FERTILIZER TATE OF APPLICATION: 400 LBS/ACRE
  LIMING RATE: 500 LBS/ACRE (PULVERIZED AOR). LIMESTONE)
  MUICH TYPE: WOOD CELLUROSE FIBER
  MUICH RATE: 1400 LBS/ACRE
  MUICH RATE: 1400 LBS/ACRE
  ANCHOR MATERIAL ECCOOD COPOLYMER TACKHBER
  ANCHOR MATERIAL ECCOOD COPOLYMER TACKHBER
  ANCHORING RATE OF APPLICATION: 5 LBS/ACRE
  SEEDING SEASON DATES: MARCH 1-MAY 15 AND SEP1, 1-OCTOBER 15

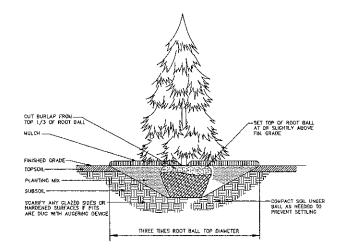

## **EVERGREEN TREE PLANTING** WITHOUT GUY WIRES

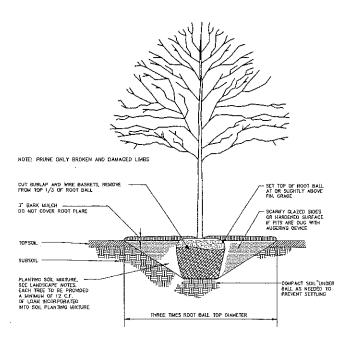

TREE PLANTING

#### LANDSCAPE NOTES

1. THE LANDSCAPE PLAN AND DETAIL SHEET ARE FOR LANDSCAPING INFORMATION ONLY. REFER TO INFORMATION PLAN, LICHTING PLAN, GRADING PLAN AND UTILITIES PLAN FOR ALL OTHER INFORMATION.

2. PLANTING LOCATIONS ARE APPROXIMATE AND ARE SUBJECT TO FIELD ADJUSTMENT DUE TO UTILITY LOCATIONS AND SITE CONDITIONS. CONTRACTOR SHALL LAY OUT THE WORK FOR THE REVIEW. ADJUSTMENT, AND APPROVAL OF OWNER OR LANGSCAPE ARCHITECT PRIOR TO PLANTING.

3. UTILITY LOCATIONS SHOWN IN THE DRAWINGS ARE APPROXIMATE, EXERCISE CARE WHEN DIGGING IN AREAS OF POTENTIAL CONFLICT WITH UNDERGROUND OR OVERREAD UTILITIES. THE CONTRACTOR IS RESPONSIBLE FOR MY DAMAGE DUE TO CONTRACTOR'S NEGLIGENCE AND SMALL REPLACE OR REPAIR ANY DAMAGE AT CONTRACTOR'S EXPENSE.

4. NO PLANT SHALL BE PLACED IN THE GROUND BEFORE ROUGH GRADING HAS BEEN COMPLETED.

4. NO PLANT SHALL BE PLACED IN THE CROUND BEFORE ROUGH GRADING HAS BEEN COMPLETED.

5. TOPSON, SHALL BE INSTALLED AT A INHUMIN DEPTH OF 4", CONTRACTOR SHALL SUBJICT SAMPLES OF TOPSON. THIS TOPSON. SHALL BLUE CONTAIN MATERIALS THAT ARE HARMFUL TO PLANT LIFE, IT MILES BE CLEAM, FERRIE, FRAMER, WILL DRAWING, NATURAL SAMPL LOAM, ALL TOPSON. SHALL BE LINFORM IN DIALLY HAD TEXTURE AND CONTAIN TORSON. SHALL BE LORDED IN DUBLITY AND TEXTURE AND CONTAIN ORGANIC MATTER AND MATERIAL ELEMENTS MECESSARY FOR SUSTAINING HEALTHY PLANT CROWTH. BECOME MATERIAL ELEMENTS MECESSARY FOR SUSTAINING HEALTHY PLANT CROWTH. BECOME MATERIAL BE ADDRESS OF PROBLEM TO PLANT CROWTH. BECOME OF THIS MATERIAL SHALL BE ADDRESS OF THIS MATERIAL SHALL BE ADDRESS OF THIS MATERIAL SHALL BE ADDRESS OF THE TOLLOWING OF THE TOPSON. TO MEET THE OFFINIAL NUTRIENT LEVELS SPECIFED IN THE TESTING LABORATORY REPORT FOR EACH CROPPLANT TO BE INSTALL USED A SHALL SETURAL LEVELS SPECIFED IN THE TESTING LABORATORY REPORT FOR EACH CROWTH OF THE SHALL WELL THE UNDER SHALL WE NOT THE SHALL WHAT AND MATERIAL OR CONDITION THAT WOULD PREVENT THE ESTABLISHMENT OF A SUTHBUT LAWN. AMEND EXISTING TOPSON, AS REQUIRED BY TOPSON. THESE SHALL SHALL WE NOT AND MATERIALS BY CHARLES SHALL SHAPOL AND MATERIALS BY CHARLES SHALL SHAPOL AND MATERIALS BY CHARLES SHAPOL AND MATERIALS BY CHARLES SHAPOL AND MATERIALS BY CHARLES SHAPOL WELL THE WARN.

6. THE CONTRACTOR SHALL SUPPLY ALL LABOR, PLANTS, AND MATERIALS IN QUANTITIES SUFFICIENT TO COMPLETE THE WORK SHOWN ON THE CRAMMOS AND USTED IN THE PLANT SCHEDULE, WHEN QUANTITIES USTED IN THE PLANT SCHEDULE DIFFER FROM THOSE REQUIRED BY THE DRAWMOS, THE LARGER QUANTITY SHALL BE USED.

7. LANDSCAPE PLANTING PITS MUST BE FREE ORAINING. PAYEMENT, COMPACTED SOIL, AND BLASTED ROCK SHALL BE REMOVED FROM PLANTING PITS AND LANDSCAPE ISLANDS TO A DEPTH OF 2' OR TO A CREATER DEPTH IF REQUIRED BY PLANTING DEFIALS OR SEPTION/CANDEN, REPLACE SOIL MYTHIN ISLANDS WITH LOAM OR SANDY LOAM FREE OF STONES AND DEBRIS 1' OR GREATER IN DIAMETER AND ALL OTHER MATERIAL MARKINE, I OPLANT DEVELOPMENT.

8. PLANTING SOIL MIXTURE FOR ALL PLANTINGS SHALL CONSIST OF: 1 PART PEAT MOSS OR COMPOST, 3 PARTS TOPSOIL, "TRANSPLANT 1-STEP" FERTILIZER / BIOSTMULANT / MYCORPHIZA INCOULATE AS MANUFACTURED BY ROOTS, INC. OR AN APPROVED EQUIVALENT, AND LIME AND OTHER AMENDMENTS AS INDICATED BY SOIL ANALYSIS.

INDICATED BY SOIL ANALYSIS.

9. PLANT REQUIREMENTS: ALL PLANTS SHALL CONFORM IN SIZE AND GRADE TO THE AMERICAN
\$TANDARD FOR MURSERY STOCK, AND ZEOL (LATEST EDITION). ALL PLANTS SHALL MEET THE
\$TANDARD FOR MURSERY STOCK, AND ZEOL (LATEST EDITION). ALL PLANTS SHALL MEET THE
\$TANDARD FOR MURSERY STOCK, AND ZEOL (LATEST EDITION).

REES AND SHRUBS SHALL HAVE BEEN GROWN AT A COMMERCIAL MURSERY WITHIN 200 MEES OF THE
PROJECT SITE UNLESS CHITEMENE APPROVED BY OWNER OR LAMOSCAPE ARCHITECT. THEY SHALL BE
PYPICAL OF THEIR SPECIES OR VARIETY, THEY SHALL BE REED AMBOSCAPE ARCHITECT, HEVENLY AND DENSELY OF THE SPECIES OF VARIETY. THEY SHALL BE REED ARRICANCE OF THE SPECIES OF VARIETY. THEY SHALL BE REED ARRICANCE OF THE SPECIES OF VARIETY. THE OWNER OF ARK MULRY, DISEASE, AND
COTHERMSE CHARACTERISTIC OF THE SPECIES OR VARIETY. THE OWNER OF A MARKET CHITECT WILL
ALLOW SUBSTITUTIONS ONLY UPON WRITTEN A PROVOVAL SIZES SHALL CONFORM TO THE MERSURE WHI
SPECIFICATION SHALL NOT MORECASE THE CONTRACT PRICE. ALL OVERSTORY PRICES PLANTED ALONG
PARKING AREAS, SIDEMAKIS AND PEDESTRIAN ACCESSES SHALL NOT BRANCH BELOW 7 FELT IF THE TREE
CAMPER IS 2172 INCRESS ON GREATER, ALL PLANT MOTERIES ARE SUBJECT TO INSPECTION AND
SHALL COORDINATE SOURCE WISTS WITH THE LANDSCAPE ARCHITECT AND SHALL ACCOUPANY THE OWNER
AND/OTAL LANDSCAPE ARCHITECT FOR ALL INSPECTION, CERTIFICATES OF COMPLIANCE WITH
SPECIFICATIONS ARE REQUIRED FOR ALL PLANTS.

11. GURANITEE: CUARANITEE ALL PLANTS AND LAWNS FOR A MINIMUM OF 1 YEAR TO BE ALIVE AND IN MOGROUS GROWING CONDITION AT THE END OF THE GURANITEE PERIOD. THE GURANITEE PERIOD FOR ALL PLANTS SHALL BEGON UPON A PROVOAL AS SPECIDED UNDER SEMI-FINAL ACCEPTANCE. PLANT MATERIALS AND LAWNS APPROVED IN THE SPRING SHALL BE ALIVE AND IN SATISFACTORY GROWTH ON JUNE 1 OF THE FOLLOWING YEAR, PLANTING DONE IN LATE CALL (AFTER NOVEMBER 1ST) SHALL BE MAINTAINED AND GURANITEED UNTIL THE SECOND SPRING'S LEATING, REPLACEMENTS: ALL PLANTS SHALL BE FREE OF DEAD OF DYING BRANCHEE THE AND SHALL BEAR FOLLOGE OF A NOVIAL DENSITY, SZE AND COCOR, PROMPTLY REMOVE DEAD, UNSIGHTLY, UNIFICATIFY, OR EXCESSIVELY PRIMITED PLANTS. THESE AND ANY LAWN'S MISSING DUE TO THE COMPACTION SOON AS CONDITIONS FERMIT, METHOD OF REPLACEMENTS SHALL BE MADEED SHALL BE SHALL BE WAS EXCESSIVED FROM THE ADMINISTRATION AND THE REPLACEMENTS SHALL BE MADEEN SHALL BE SHALL BE WASCESSIVED FROM THE SHALL BE MADEEN SHALL BE WASCESSIVED FROM THE SHALL BE MADE AT THE CONTRIBUTION AND THE SHALL BE MADE AT THE CONTRIBUTION SHALL BE MADE AT THE CONTRIBUTION AND THEY SHALL BE MAINTAINED AND GUARANITEED FOR ONE FULL TEAM FROM THE OF REPLACEMENTS SHALL BE MADE AT THE CONTRIBUTORY SERVICE OF THE SHALL BE MAINTAINED AND GUARANITEED FOR ONE FULL TEAM FROM THE OF REPLACEMENTS SHALL BE MADE AT THE CONTRIBUTORY SERVICE SAND SHALL BE GUARANITEED FOR ONE FULL TEAM FROM THE OF REPLACEMENTS.

12. ALL SLOPES STEEPER THAN 3:1 RECEIVING A GRASS SEEDING MIXTURE SHALL BE COVERED WITH AN EROSION CONTROL BLANKET OF STRAW FIBER AND BIODEGRADABLE OF PHOTOGEGRADABLE NETTING.

13. UNLESS OTHERWISE NOTED IN DRAWING SET, NEW TREELINES SHALL EQUAL CLEARING AND GRUBBING LIMITS.

14. IF SHEET IS LESS THAN 24" X 36," IT IS A REDUCED PRINT AND SHOULD BE SCALED ACCORDINGLY.

Companies

LANG SURVEYING ENVIRONMENTAL SCIENCES

TOWER PROPOSED CELL TOWE!
GREENWOOD DRIVE
TOWN OF AVON, CONNECTICUT

Designed J.W.F. Checked

Project No 10L2173 4/13/10 CAD File: LC10L217301

LANDSCAPE DETAILS AND NOTES

iheet No.

LL-3