

FARMINGTON NORTH 2

**199 Town Farm Road
Farmington, Connecticut**

Description of Proposed Cell Site

Cellco Partnership d/b/a Verizon Wireless
99 East River Drive
East Hartford, CT 06108

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SITE NAME: FARMINGTON NORTH 2 – 199 Town Farm Road, Farmington, CT

GENERAL CELL SITE DESCRIPTION

The proposed cell site would be located within a 60' x 60' fenced compound within a 100' x 100' leased area in the southeasterly portion of an approximately 9.9-acre parcel ("Property") owned by the Town of Farmington. The Property is known as the Simmons Family Farm and is located at 199 Town Farm Road in Farmington (the "Farmington North 2 Facility"). The Farmington North 2 Facility would consist of a 110-foot telecommunications tower. The Town has requested that Cellco construct a stealth tower. If deemed appropriate by the Council, Cellco would construct a stealth "monopine" tree tower with simulated branches that would extend an additional seven feet from the top of the tower for an overall structure height of 117-feet. Cellco would install a 1,000 gallon propane tank and a 12' x 30' equipment shelter located near the base of the tower. Cellco's back-up generator would be fueled by propane. Cellco antennas would be mounted at the top of the tower with their centerline at the 110-foot level. Utility and vehicular access to the site would extend from Town Farm Road over a new gravel driveway a distance of approximately 580 feet to the site compound.



2,000 1,000 0 2,000
Feet



Quadrangle Location

Vanasse Hangen Brustlin, Inc.

USGS Topographic Map
Proposed Verizon Wireless
Telecommunications Facility
The Simmons Family Farm
199 Town Farm Road
Farmington, Connecticut





Base Map Source: 2006 Color Aerial Photograph with 1 foot Resolution

400 200 0 400
Feet



Quadrangle Location

Vanasse Hangen Brustlin, Inc.

Aerial Photograph
Proposed Verizon Wireless
Telecommunications Facility
The Simmons Family Farm
199 Town Farm Road
Farmington, Connecticut

SITE EVALUATION REPORT

SITE NAME: FARMINGTON NORTH 2 – 199 Town Farm Road, Farmington, CT

I. LOCATION

- A. COORDINATES: 41°-45'-27.99" N 72°-49'-47.75" W
- B. GROUND ELEVATION: Approximately 189± feet AMSL
- C. USGS MAP: Avon, CT
- D. SITE ADDRESS: 199 Town Farm Road, Farmington, CT
- E. ZONING WITHIN 1/4 MILE OF SITE: Land within 1/4 mile of the cell site is in the Residential zone designation.

II. DESCRIPTION

- A. SITE SIZE: 100' x 100' Leased Area
- B. LESSOR'S PARCEL: Approximately 9.9-acres
- C. TOWER TYPE/HEIGHT: 110' Monopole Tower
117' overall structure height for "monopine" design
- D. SITE TOPOGRAPHY AND SURFACE: Topography in the general area of the site slopes down to the south, west and east. To the north, the topography is relatively flat before sloping down further to the north. Clearing and grading of the leased area and access driveway will be required. The site has been situated so as to minimize, to the extent possible, the clearing of substantial trees.
- E. SURROUNDING TERRAIN, VEGETATION, WETLANDS, OR WATER: The tower is located in the northerly portion of a partially wooded 9.9-acre parcel. No wetland areas exist within or near the site compound or access driveway.
- F. LAND USE WITHIN 1/4 MILE OF SITE: The Facility is located on an approximately 9.9-acre partially wooded property. The property is surrounded by farm land and residential land uses. (See Aerial Photograph at p. ii).

III. FACILITIES

- A. POWER COMPANY: The Connecticut Light and Power Company
- B. POWER PROXIMITY TO SITE: Approximately 580 feet to the east of the cell site.
- C. TELEPHONE COMPANY: AT&T
- D. PHONE SERVICE PROXIMITY: Same as power
- E. VEHICLE ACCESS TO SITE: Vehicle access to the site would extend from Town Farm Road over a new 12-foot wide gravel driveway to the site compound a total distance of approximately 580 feet.
- F. CLEARING AND FILL REQUIRED: Clearing and grading would be required for construction of the tower, site compound and for improving the access drive. Detailed construction plans would be developed after approval by the Siting Council.

IV. LEGAL

- A. PURCHASE [] LEASE [X]
- B. OWNER: Town of Farmington
- C. ADDRESS: 199 Town Farm Road, Farmington, CT 06032
- D. DEED ON FILE AT: Town of Farmington, CT Land Records

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FACILITIES AND EQUIPMENT SPECIFICATIONS
(NEW TOWER & EQUIPMENT BUILDING)

SITE NAME: FARMINGTON NORTH 2 – 199 Town Farm Road, Farmington, CT

I. **TOWER SPECIFICATIONS:**

- A. MANUFACTURER: To be determined
- B. TYPE: Self-supporting monopole
- C. TOWER HEIGHT: 110' DIMENSIONS: Approx. 48" base
"MONOPINE" HEIGHT: 117' Approx. 30" top

II. **TOWER LOADING:**

A. CELLCO EQUIPMENT:

- 1. Antennas (12)
Six (6) Model LPA-80063/4CF (47.4" x 15.2" x 13.2") Cellular
Six (6) Model LPA-185063/8CF_2 (47.2" x 6.6" x 5.8) PCS antennas
Antenna Centerline 110' AGL
- 2. GPS Antenna: Mounted on the top of the equipment shelter
- 3. Transmission Lines:
 - a. MFG/Model: Andrews LDF5-50A
 - b. Size: 1 5/8"

III. **ENGINEERING ANALYSIS AND CERTIFICATION:**

The tower will be designed in accordance with Electronic Industries Association Standard EIA/TIA-222-E "Structural Standards for Steel Antenna Towers and Antenna Support Structures." The foundation designs would be based on soil conditions at the site. Details for the towers and foundation designs will be provided as a part of the final D&M Plan.

ENVIRONMENTAL ASSESSMENT STATEMENT

SITE NAME: FARMINGTON NORTH 2 – 199 Town Farm Road, Farmington, CT

I. PHYSICAL IMPACT

A. WATER FLOW AND QUALITY

No water flow and/or water quality changes are anticipated as a result of the construction or operation of the facility. There are no lakes, ponds, rivers, streams, wetlands or other regulated bodies of water located in the area to be used for the access drive, tower or equipment shelter. The equipment used will not discharge any pollutants to area surface or groundwater systems.

B. AIR QUALITY

Under ordinary operating conditions, the equipment that would be used at the site would emit no air pollutants of any kind. For limited periods during power outages and periodically for maintenance purposes, minor levels of emissions from the on-site generator would result.

Pursuant to R.C.S.A. § 22a-174-3, the on-site emergency back-up generator proposed as a part of this application would require the issuance of a Connecticut Department of Environmental Protection Air Bureau permit for potential emissions. Cellco would obtain this permit prior to installing the generator at the approved cell site.

C. LAND

Clearing and grading of the tower compound and access drive will be required. The remaining land of the Lessor would remain unchanged by the construction and operation of the cell site.

D. NOISE

The equipment to be in operation at the site after construction would emit no noise of any kind, except for operation of the installed heating, air conditioning and ventilation systems and occasional operation of a back-up generator that would be run during power outages and periodically for maintenance purposes. Some noise is anticipated during cell site construction, which is expected to take approximately four to six weeks.

E. POWER DENSITY

The worst-case calculation of power density for Cellco's Cellular and PCS antennas at the Farmington North 2 Facility would be 14.01% of the Standard.

F. VISIBILITY

See Visual Resource Evaluation Report included as Attachment 9.

**CELLCO PARTNERSHIP
DBA**


verizon wireless

FARMINGTON NORTH 2

199 TOWN FARM ROAD FARMINGTON, CONNECTICUT 06032

PROJECT SUMMARY

SITE NAME: FARMINGTON NORTH 2
SITE ADDRESS: 199 TOWN FARM ROAD, FARMINGTON, CONNECTICUT 06032
CONTACT PERSON: CELLCO PARTNERSHIP DBA
VERIZON WIRELESS
SANDY CARTER (B60) 803-8219
COVERING CODE: CONNECTICUT STATE BUILDING AND LIFE SAFETY CODE
APPLICANT: CELLCO PARTNERSHIP DBA
VERIZON WIRELESS
99 EAST RIVER DRIVE
EAST HARTFORD, CT 06108
ARCHITECT: URS CORPORATION A.E.S.
500 ENTERPRISE DRIVE, SUITE 3B
ROCKY HILL, CT 06067
M/E/P ENGINEER: URS CORPORATION A.E.S.
500 ENTERPRISE DRIVE, SUITE 3B
ROCKY HILL, CT 06067

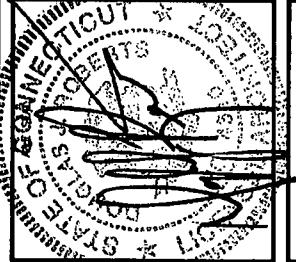

LEGEND	SYMBOL	DESCRIPTION
		SECTION OR DETAIL NUMBER SHEET WHERE DETAIL/SECTION OCCURS
		ELEVATION NUMBER SHEET WHERE ELEVATION OCCURS
		CHECKED BY:

PROJECT NO: 36931054.00002

JOB NO: VZ1 229

DRAWN BY: KAP

ISSUED FOR

0 01-03-08 SURVEY COUNCIL

1 01-03-08 REVIEW

THE INFORMATION CONTAINED
IN THIS SET OF DOCUMENTS
IS PROPRIETARY BY NATURE,
ANY USE OR DISCLOSURE
OTHER THAN THAT WHICH
RELATES TO VERIZON WIRE-
LESS IS STRICTLY PROHIBITED

FARMINGTON
NORTH 2

199 TOWN FARM ROAD
FARMINGTON, CONNECTICUT
06032

AS NOTED
TITLE SHEET-
GENERAL NOTES
AND LEGENDS

T-1

LEGEND	SYMBOL	DESCRIPTION
		SECTION OR DETAIL NUMBER SHEET WHERE DETAIL/SECTION OCCURS
		ELEVATION NUMBER SHEET WHERE ELEVATION OCCURS
		CHECKED BY:

PROJECT NO: 36931054.00002

JOB NO: VZ1 229

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ISSUED FOR

0 01-03-08 SURVEY COUNCIL


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FARMINGTON
NORTH 2

SHEET INDEX	SH. NO.	DESCRIPTION	SCALE
T-1		TITLE SHEET - GENERAL NOTES AND LEGENDS	AS NOTED
S-1		SURVEY	
AB-1		ABUTTERS MAP	
SC-1		PARTIAL SITE PLAN, NOTES AND DETAIL	
SC-2		COMPOUND PLAN, TOWER ELEVATION, AND ANTENNA ORIENTATION PLAN	
SC-3		SITE DETAILS AND NOTES	
SC-4		EQUIPMENT SHELTER FOUNDATION PLAN, ELEVATIONS, DETAILS AND NOTES	


SITE DIRECTIONS
FROM EAST HARTFORD TAKE I-84 W / US-6 W VIA THE RAMPS ON THE LEFT TOWARD WATERBURY AVE. ONTO CT-4 W / TOWNSHIP LINE TOWARD FARMINGTON. TURN RIGHT ONTO TOWN FARM ROAD.



NOTES

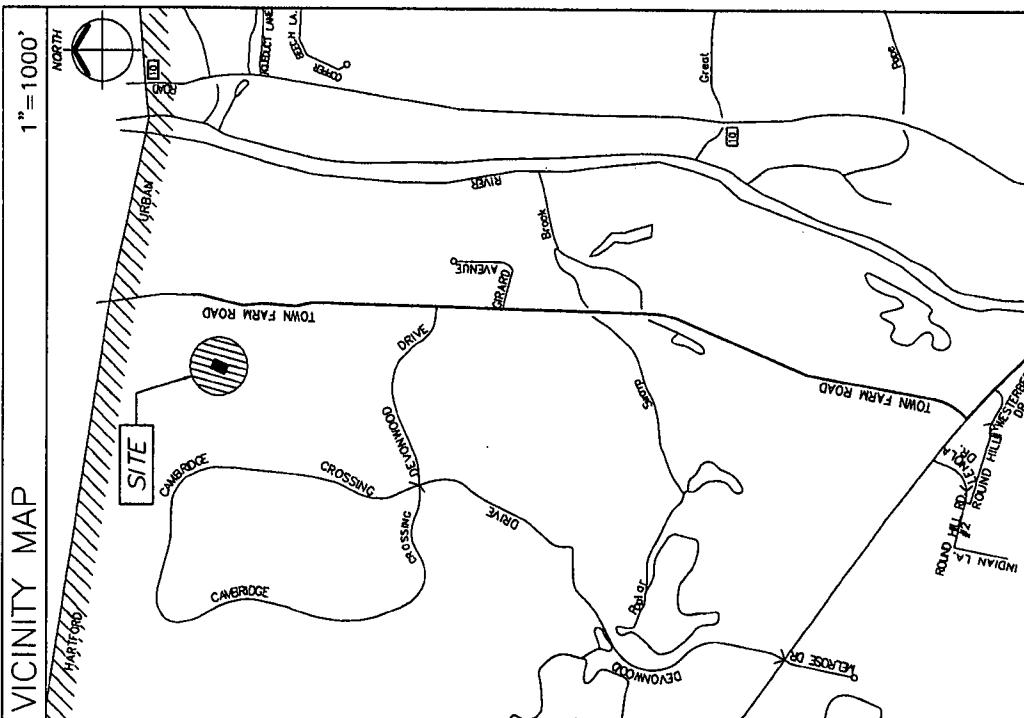1. THIS MAP HAS BEEN PREPARED IN ACCORDANCE WITH THE REGULATIONS OF CONNECTICUT STATE MARSHALS, SECTION 50-300 - RULES AND REGULATIONS FOR SURVEYS AND PLANS OF LAND. IT IS THE DUTY OF THE SURVEYOR TO MAKE A DETAILED CHECK OF THE SURVEY AND PLAN, AND TO CERTIFY THAT THE SURVEY AND PLAN ARE ACCURATE AND TRUE. AS THIS IS THE TYPE OF SURVEY, NO PROPERTY AND A F-2 REPORTING SURVEY, THE SURVEYOR CERTIFIES THAT THE SURVEY IS A PROPERTY SURVEY.
2. SEARCHES REFER TO THE CONNECTICUT COURTHOUSE SYSTEM.
3. OBLIGATIONS REFER TO THE ORIGINAL SURVEY, SPECIAL DRAWN OR RE-DRAWN BY SURVEYOR. THIS SURVEY IS NOT DRAWN TO SCALE.
4. REFERENCE IS MADE TO THE FOLLOWING MAPS:

 - A. Map of STONY OLD CHURCH OWNED BY STONER REALTY INC. ATION & FARMINGTON, CONNECTICUT, BY MELTON HODGE, SURVEYOR, SCALE 1:20,000, DATED JUNE 1995.
 - B. PROPERTY AND LAND OWNED BY FERDIE FAMILY PROPERTIES, KENY FARM AND FARMINGTON, CONNECTICUT, BY MELTON HODGE, SURVEYOR ASSOCIATES, P.C., SCALE 1:20,000, DATED AUGUST 2000.
 - C. PROPERTY IS SUBJECT TO THE EFFECTS OF ANY OF A RENT OF USE IN FAVOR OF THE AMERICAN TELEPHONE AND TELEGRAPH COMPANY AS AGREED IN A LEASE, TO PAY TO THE FARMINGTON LAND RECORDS.
 - D. PROPERTY IS SUBJECT TO ALIENATION RIGHTS IN FAVOR OF THE NEW FARMINGTON RECORDS AS RECORDED IN VOLUME 18A, PAGE 105 OF THE FARMINGTON LAND RECORDS.
 - E. PROPERTY IS SUBJECT TO POSSIBLE RIGHTS OF OWNERS IN AND TO THE OLD FARMINGTON CANAL, AS MAY APPEAR OF RECORD.

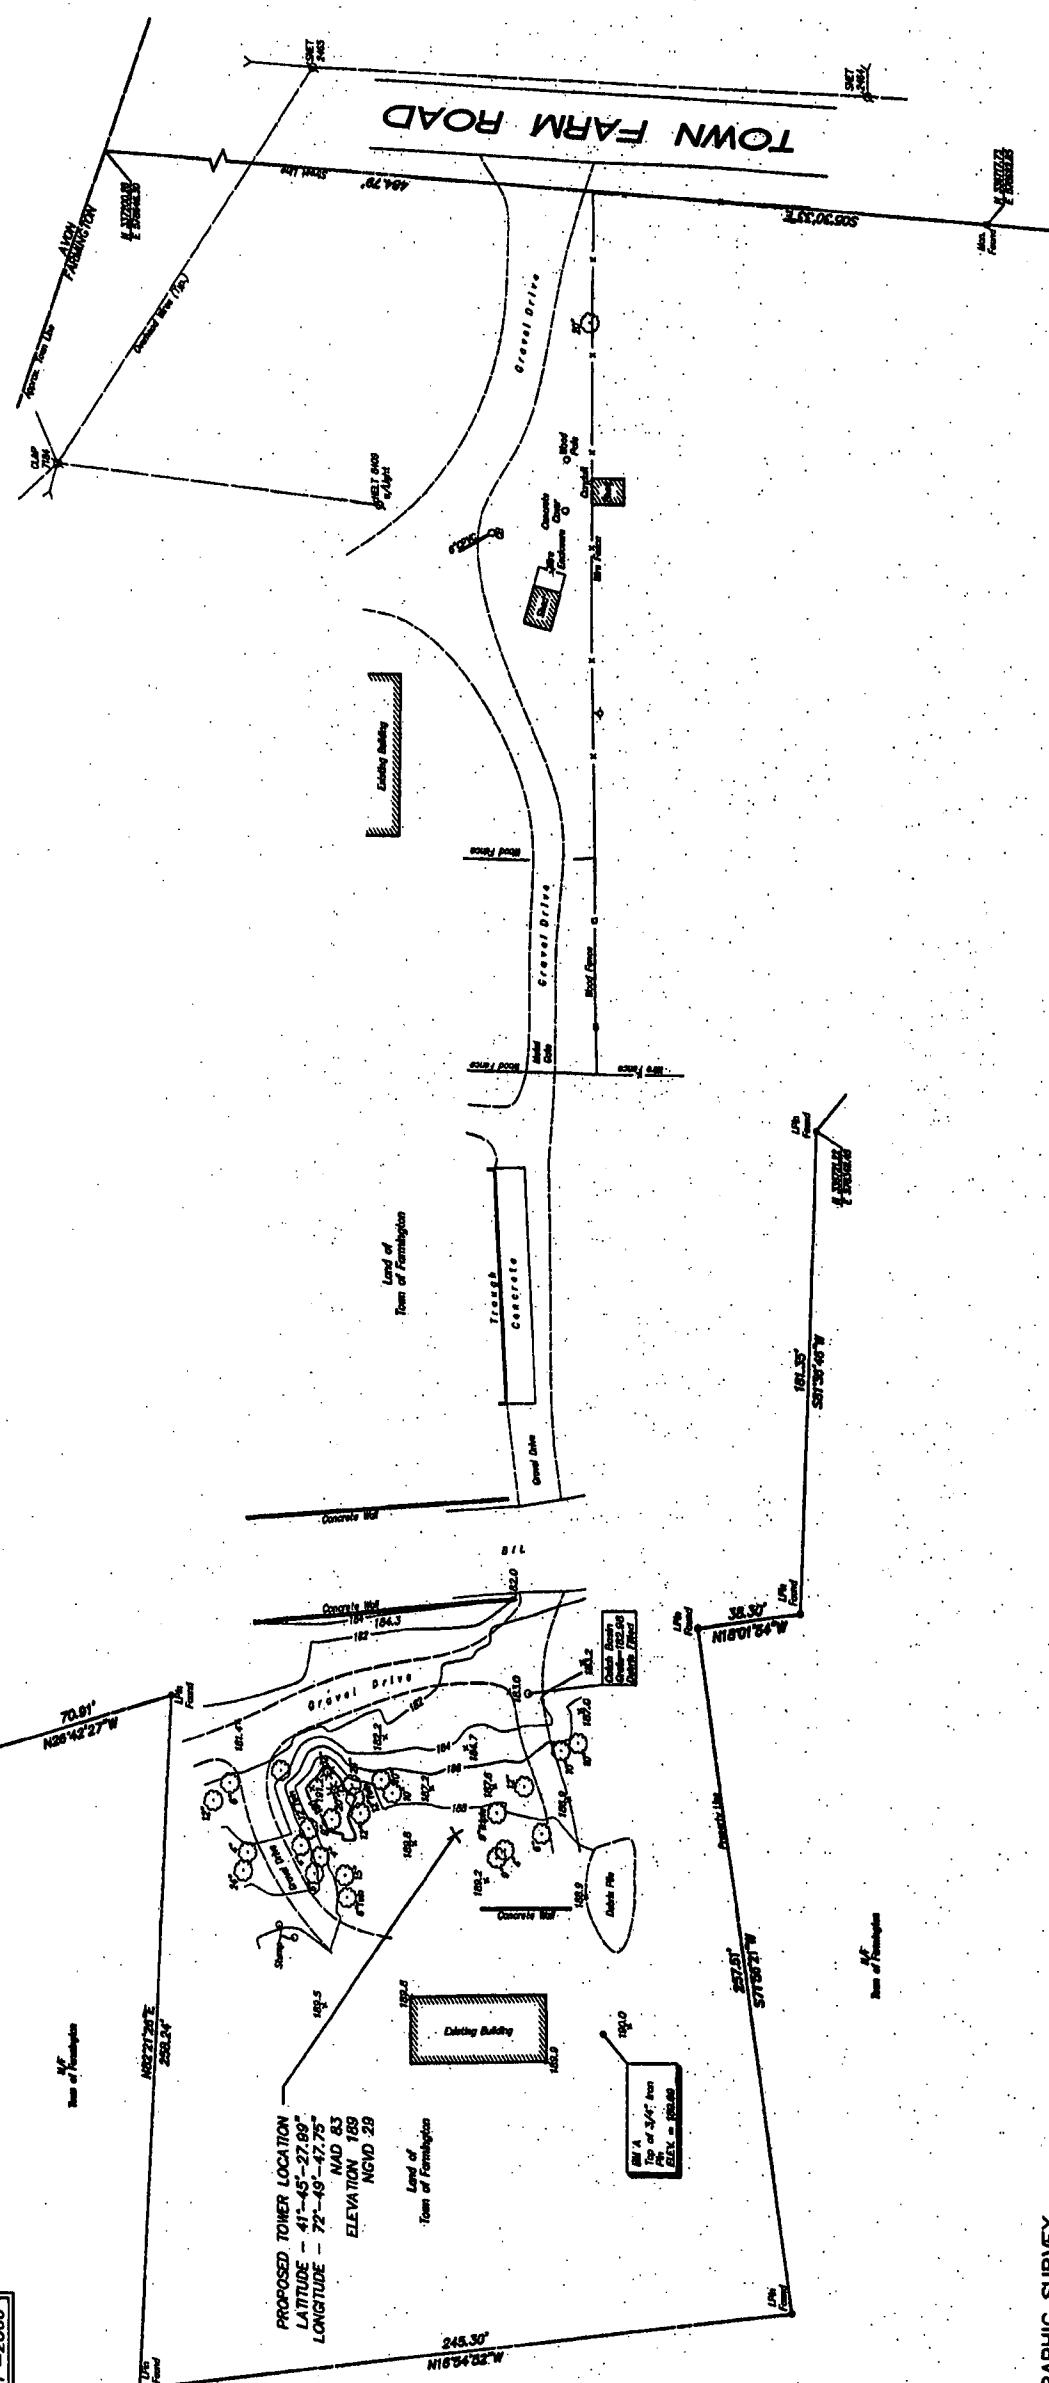

**PROPERTY & TOPOGRAPHIC SURVEY
PROPOSED LEASE PARCEL
TOWN OF FARMINGTON
#199 TOWN FARM ROAD
FARMINGTON, CONNECTICUT
PREPARED FOR
VERIZON WIRELESS**

PASURVEY\SNET\36981840\deg\36981810\deg

Surveying and Mapping by		UBS Corporation AEB	
Surveyor: T. BERNARDI		Date: April 2008	
Mark No.	Date	Mark No.	Date
1840-1	Open Comp	1840-1	Proprietary
1840-2	Soil	1840-2	Proprietary
1840-3	Soil	1840-3	Proprietary
1840-4	Soil	1840-4	Proprietary
1840-5	Soil	1840-5	Proprietary
1840-6	Soil	1840-6	Proprietary
1840-7	Soil	1840-7	Proprietary
1840-8	Soil	1840-8	Proprietary
1840-9	Soil	1840-9	Proprietary
1840-10	Soil	1840-10	Proprietary
1840-11	Soil	1840-11	Proprietary
1840-12	Soil	1840-12	Proprietary
1840-13	Soil	1840-13	Proprietary
1840-14	Soil	1840-14	Proprietary
1840-15	Soil	1840-15	Proprietary
1840-16	Soil	1840-16	Proprietary



URS CORPORATION AES
500 ENTERPRISE DRIVE, SUITE 3B
ROCKY HILL, CONNECTICUT
1-860-252-4882
AEE, FIRM

STATE OF CONNECTICUT
DOCKET NO. 14-202-11
LICENSE NO. 14-202-11
EXPIRATION DATE: 12/31/2014

ABUTTERS LIST

PROPERTY ADDRESS: 184 TOWN FARM ROAD
MAP/LOT: TOWN OF FARMINGTON
1 MONTETH DRIVE
FARMINGTON, CT 06032
17 / 11

PROPERTY ADDRESS: 184 TOWN FARM ROAD
MAP/LOT: TOWN OF FARMINGTON
1 MONTETH DRIVE
FARMINGTON, CT 06032
17 / 11A

PROPERTY ADDRESS: 184 TOWN FARM ROAD
MAP/LOT: TOWN OF FARMINGTON
1 MONTETH DRIVE
FARMINGTON, CT 06032
17 / 27

PROPERTY ADDRESS: 158 TOWN FARM ROAD
MAP/LOT: CAROL A. WHELAN
158 TOWN FARM ROAD
FARMINGTON, CT 06032
28 / 11A

PROPERTY ADDRESS: 157 TOWN FARM ROAD
MAP/LOT: WENDY M. CHASE
157 TOWN FARM ROAD
FARMINGTON, CT 06032
28 / 2

PROPERTY ADDRESS: 155 TOWN FARM ROAD
MAP/LOT: MERWOOD M. &
BONITA JONES
155 TOWN FARM ROAD
FARMINGTON, CT 06032
28 / 10

PROPERTY ADDRESS: 7 ASHFORD COURT
MAP/LOT: MERWOOD M. &
BONITA JONES
7 ASHFORD COURT
FARMINGTON, CT 06032
28 / 185

PROPERTY ADDRESS: 4 NORFOLK GARDENS
MAP/LOT: FREDERICK R. &
LEANDRA L. GAVALIS
4 NORFOLK GARDENS
FARMINGTON, CT 06032
28 / 189

PROPERTY ADDRESS: 6 EXETER PARK
MAP/LOT: PETER J. &
LEANDRA L. BAKAJ
6 EXETER PARK
FARMINGTON, CT 06032
28 / 190

PROPERTY ADDRESS: 8 EXETER PARK
MAP/LOT: ROGER S. & LINN
S. & TRUSTEES
8 EXETER PARK
FARMINGTON, CT 06032
28 / 233

PROPERTY ADDRESS: 10 CHATSWORTH PLACE
MAP/LOT: LINDA POWERS TOMASSO
10 CHATSWORTH PLACE
FARMINGTON, CT 06032
28 / 234

PROPERTY ADDRESS: 7 EXETER PARK
MAP/LOT: RICHARD F. &
JULIA D. WEBB
7 EXETER PARK
FARMINGTON, CT 06032
17 / 235


PROPERTY ADDRESS: 12 CHATSWORTH PLACE
MAP/LOT: FRANK J. &
JOHN D. ZARBA
12 CHATSWORTH PLACE
FARMINGTON, CT 06032
17 / 236

PROPERTY ADDRESS: 5 EXETER PARK
MAP/LOT: KATHINE DOANE GOLDFARE
5 EXETER PARK
FARMINGTON, CT 06032
17 / 237

PROPERTY ADDRESS: 4 CHELSEA PLACE
MAP/LOT: BRIAN H. &
KATHLEEN A. LINDROTH
4 CHELSEA PLACE
FARMINGTON, CT 06032
16 / 274


PROPERTY ADDRESS: 14 CHATSWORTH PLACE
MAP/LOT: SUSAN D. REINERT
14 CHATSWORTH PLACE
FARMINGTON, CT 06032
17 / 272

PROPERTY ADDRESS: 199 TOWN FARM ROAD
MAP/LOT: MERRILL N. &
BONITA JONES
199 TOWN FARM ROAD
FARMINGTON, CT 06032
17 / 273

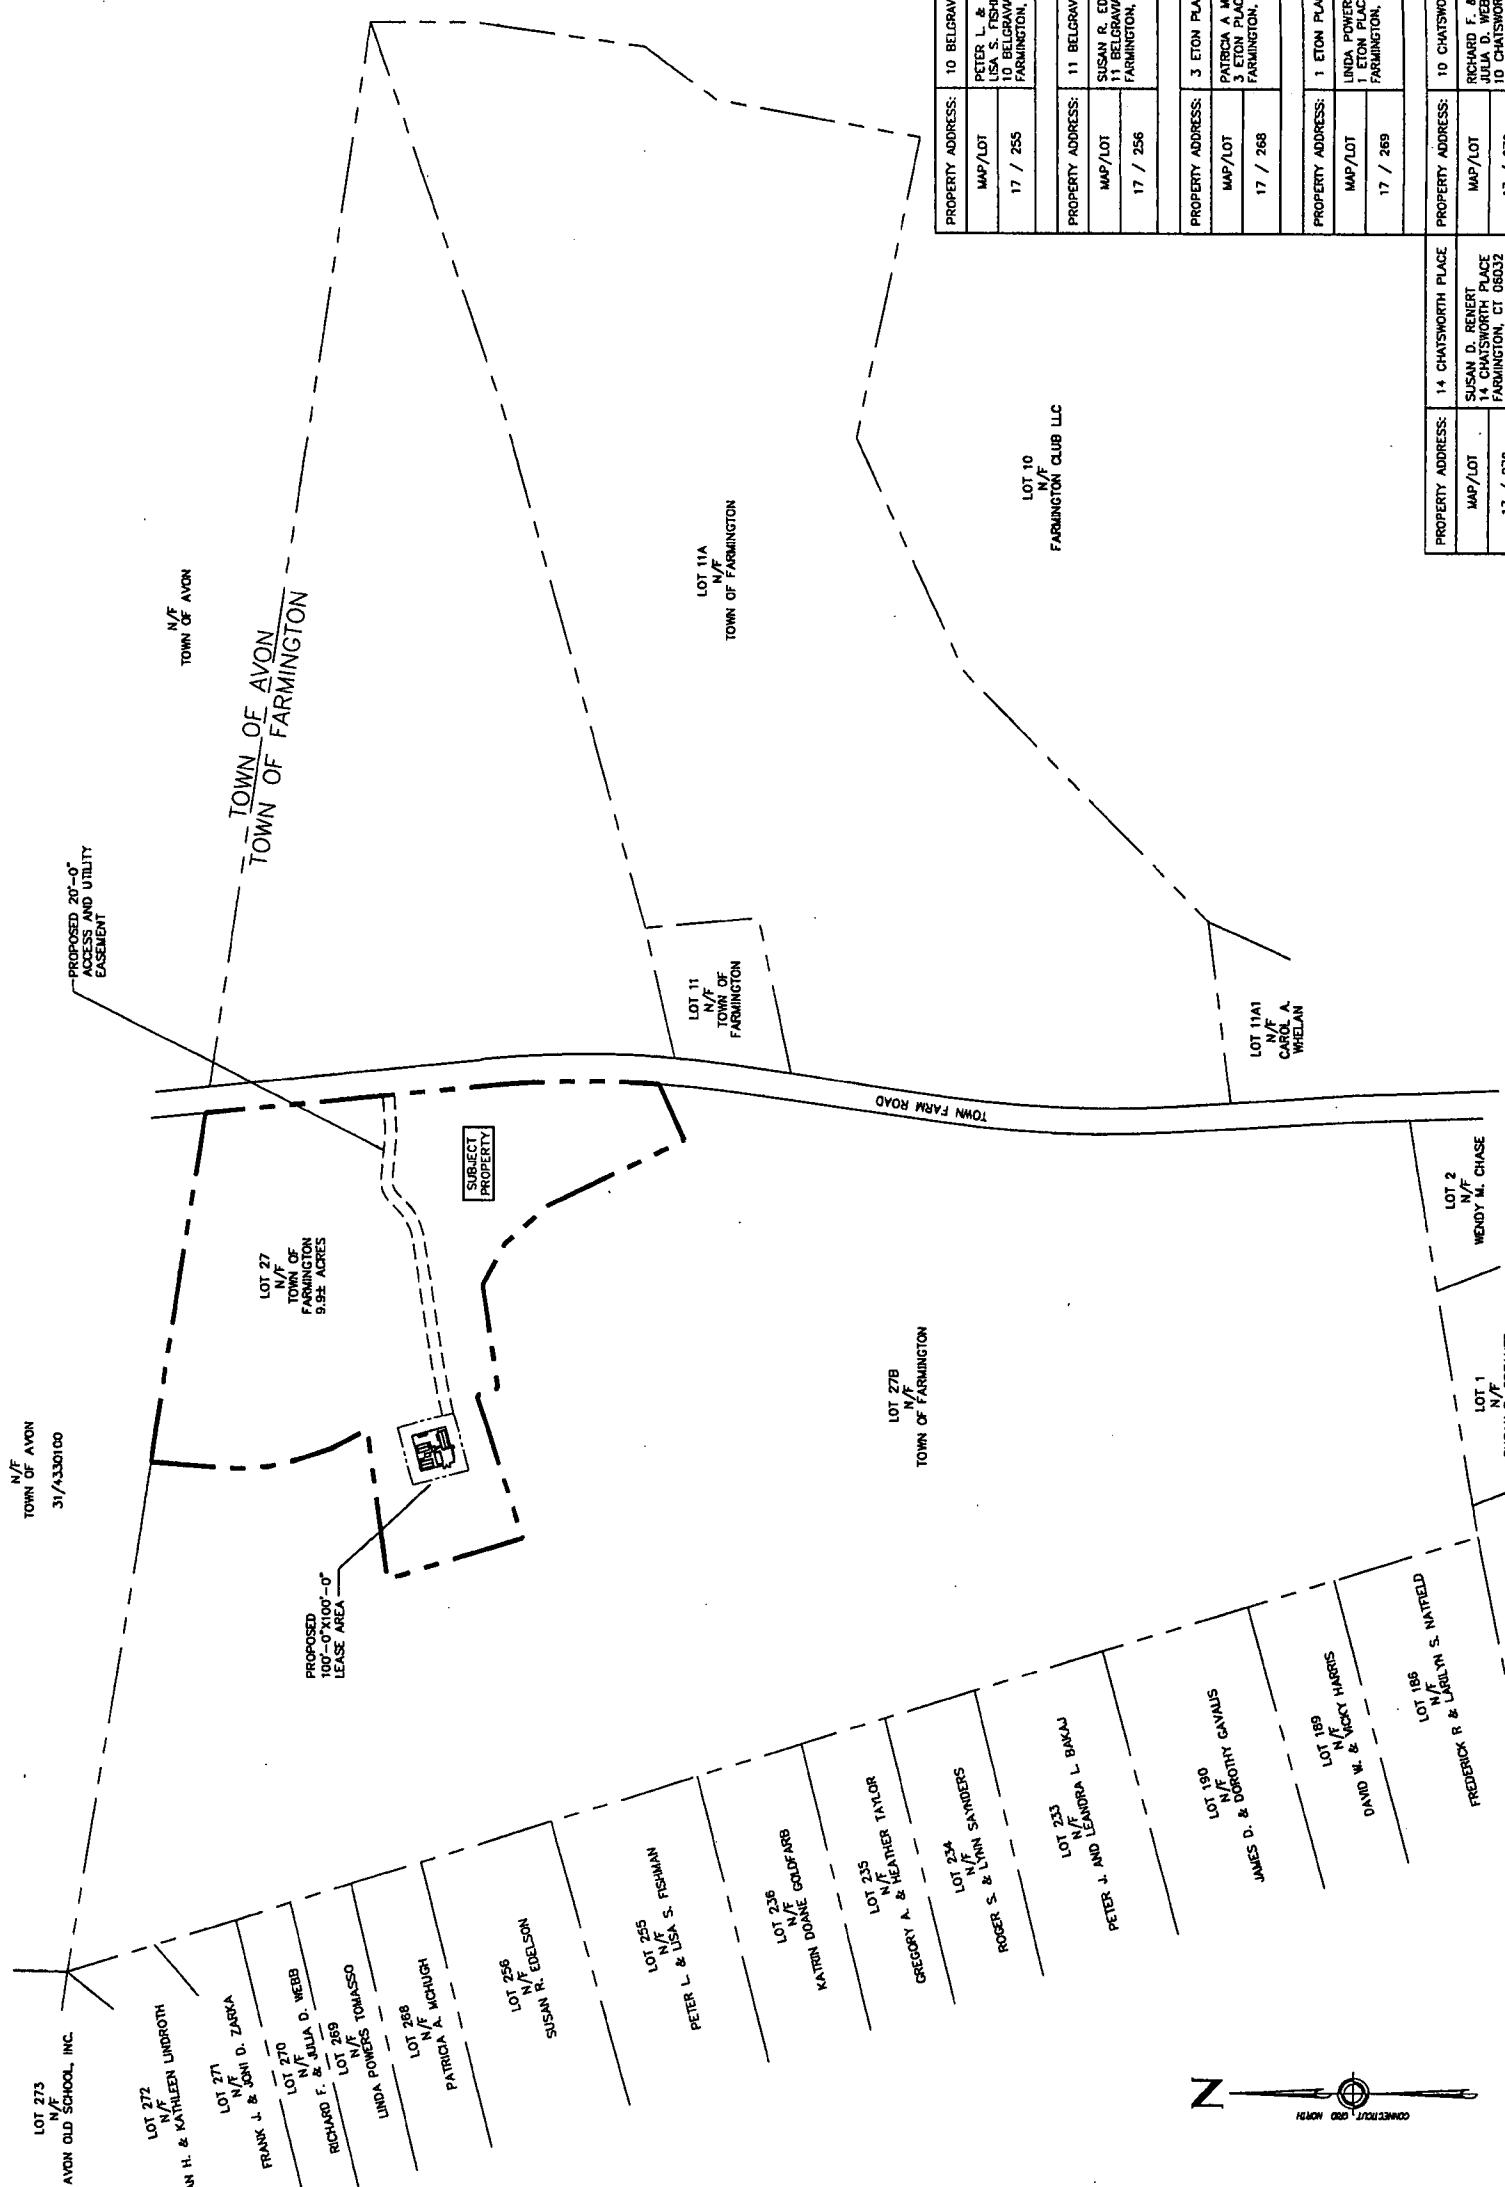



ACC. FROM
URS CORPORATION AES
500 ENTERPRISE DRIVE, SUITE 3B
ROCKY HILL, CONNECTICUT
1/16/2011 8:52

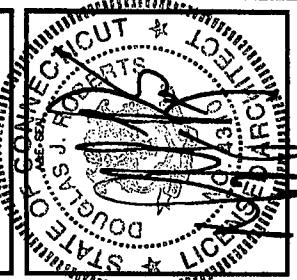

PROJECT NO: 36931054.000002

JOB NO: VZ1 229

DRAWN BY: KAP

CHECKED BY:

ISSUED FOR:

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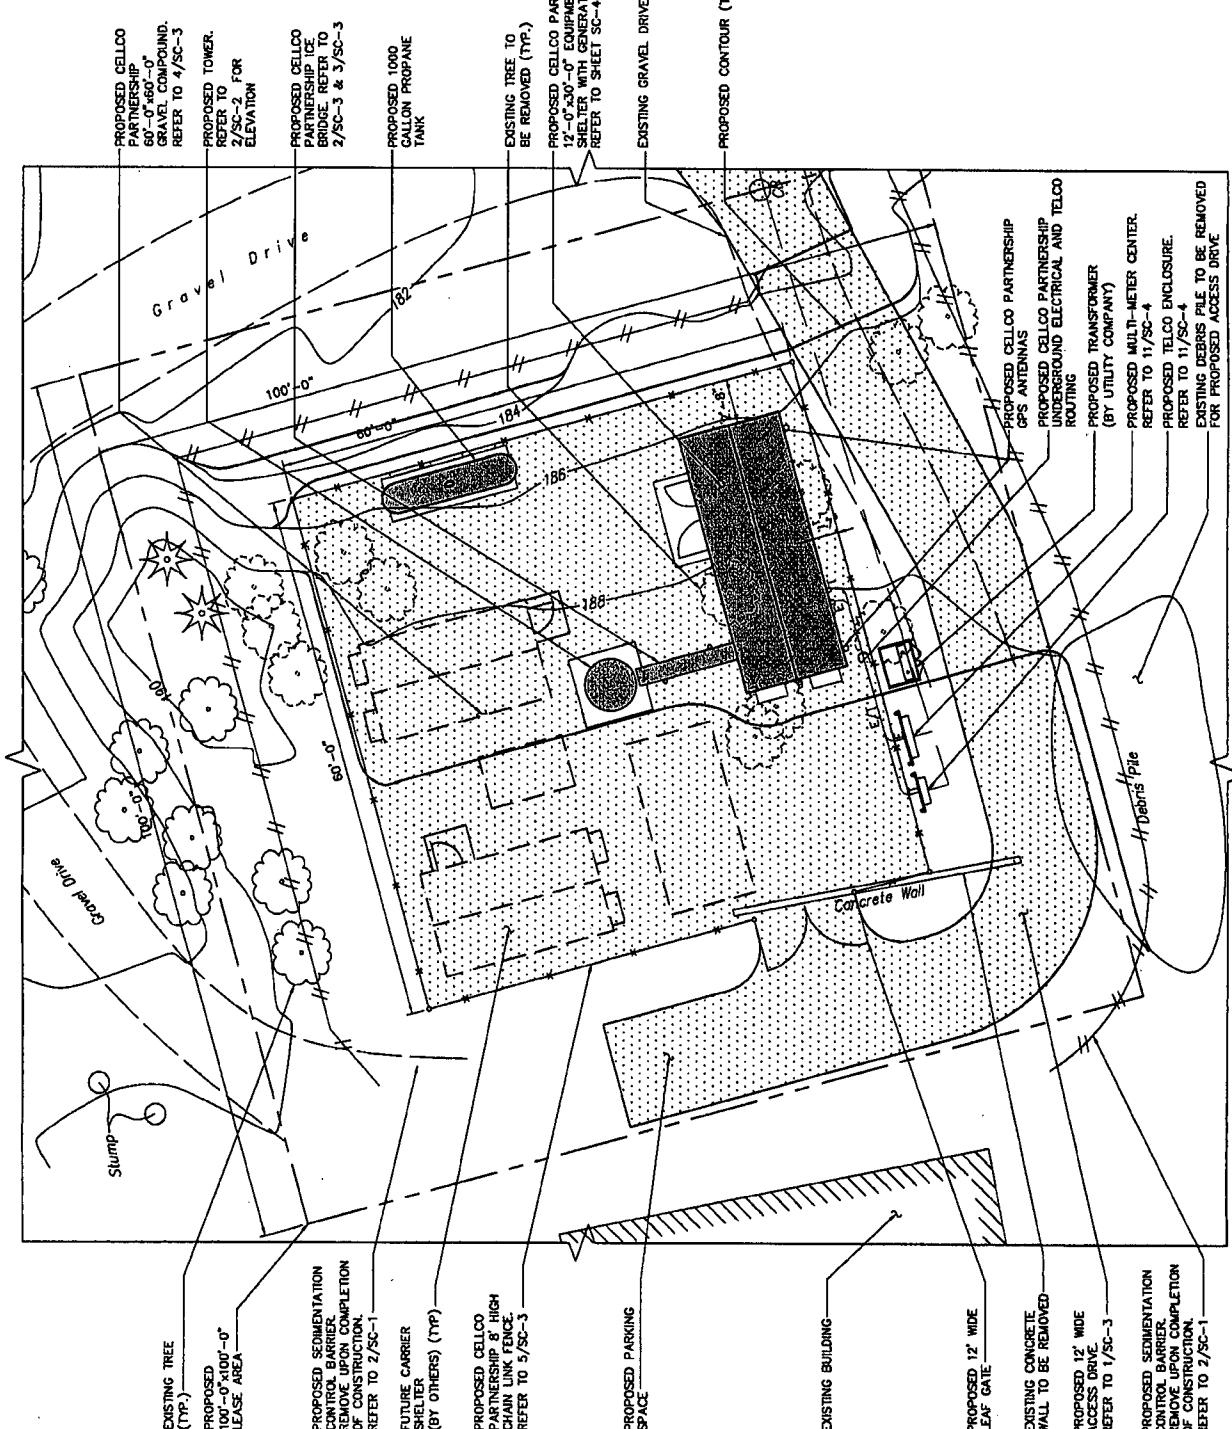
FARMINGTON
NORTH 2

199 TOWN FARM ROAD
FARMINGTON, CONNECTICUT
06032

SCALE: AS NOTED


COMPOUND PLAN,
TOWER ELEVATION,
AND ANTENNA
ORIENTATION PLAN

SC-2





URS CORPORATION AES
500 ENTERPRISE DRIVE, SUITE 3B
ROCKY HILL, CONNECTICUT
1-860-529-8882
AS OF FROM

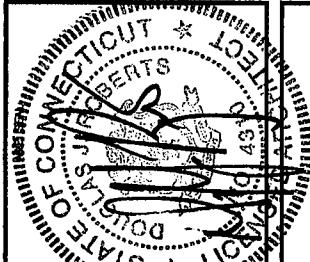

STATE OF CONNECTICUT
DEPARTMENT OF TRANSPORTATION
STANDARD SPECIFICATIONS FOR ROADS, BRIDGES AND
CIVIL CONSTRUCTION FORM 816 ENGLISH & METRIC
FOR USE IN CONNECTICUT
FORM BI - SUMMARY OF CHANGES
- SUPPLEMENT FORM 816 JANUARY 2005
- SUPPLEMENT FORM 816 JULY 2005
DEP BULLETIN J4, CONNECTICUT GUIDELINES FOR
SOIL EROSION AND SEDIMENT CONTROL DATED 2002.

CONCRETE
1. ALL CONCRETE WORK SHALL BE IN ACCORDANCE WITH THE ACI 301.
ACI 318 AND THE SPECIFICATION CAST-IN-PLACE CONCRETE.
2. ALL CONCRETE SHALL HAVE A MINIMUM COMPRESSIVE STRENGTH OF
BE AMOUNTED AT 28 DAYS (ASTM C-39) AND NOT LESS THAN 3000 psi.
3. REINFORCING STEEL SHALL CONFORM TO ASTM A 615, GRADE 60, DEFORMED
UNLESS NOTED OTHERWISE. WELDED WIRE FABRIC SHALL CONFORM TO ASTM
A 155 WELDED WIRE FABRIC UNLESS NOTED OTHERWISE. SPLICES
SHALL BE CLASS 'B' AND ALL SPLICES SHALL BE STANDARD. UND.

4. THE FOLLOWING MINIMUM CONCRETE COVER SHALL BE PROVIDED FOR
REINFORCING STEEL UNLESS SHOWN OTHERWISE ON DRAWINGS:
CONCRETE CAST AGAINST EARTH.....3 in.
CONCRETE EXPOSED TO EARTH OR WEATHER:
#6 AND LARGER.....2 in.
#5 AND SMALLER & W/W.....1 1/2 in.
CONCRETE NOT EXPOSED TO EARTH OR WEATHER OR NOT CAST
AGAINST THE GROUND:
SLAB AND WALL.....3 1/4 in.
BEAMS AND COLUMNS.....1 1/2 in.

5. A CHAFER 3/4" SHALL BE PROVIDED AT ALL EXPOSED EDGES OF
CONCRETE, UND. IN ACCORDANCE WITH ACI 301 SECTION 2.4.
6. INSTALLATION OF CONCRETE EXPANSION/MERGE ANCHOR, SHALL BE PER
MANUFACTURER'S WRITTEN RECOMMENDED PROCEDURE. THE ANCHOR BOLT,
DOWEL OR ROD SHALL CONFORM TO MANUFACTURER'S RECOMMENDATION
FOR EMBEDMENT DEPTH OR AS SHOWN ON THE DRAWINGS. NO REBAR
SHALL BE CUT WITHOUT PRIOR ENGINEERING APPROVAL WHEN DRILLING
HOLES IN CONCRETE.

7. COLD WEATHER CONCRETE PLACING SHALL BE IN ACCORDANCE WITH ACI-306.
8. NO FOOTING SHALL BE PLACED IN FROZEN GROUND. UNCURLED CONCRETE
SHALL BE PROTECTED AGAINST FROST.
9. APPLY NON-SLIP BROOM FINISH IMMEDIATELY AFTER TROWEL FINISHING.

SITE NOTES

- THE FOLLOWING STANDARD SPECIFICATIONS ARE INCORPORATED INTO THE WORK SHOWN HEREON, UNLESS SUPERSEDED BY LOCAL (FARMINGTON) REGULATIONS:
 - STATE OF CONNECTICUT DEPARTMENT OF TRANSPORTATION
STANDARD SPECIFICATIONS FOR ROADS, BRIDGES AND
CIVIL CONSTRUCTION FORM 816 ENGLISH & METRIC
FOR USE IN CONNECTICUT
FORM BI - SUMMARY OF CHANGES
- SUPPLEMENT FORM 816 JANUARY 2005
- SUPPLEMENT FORM 816 JULY 2005
 - DEP BULLETIN J4, CONNECTICUT GUIDELINES FOR
SOIL EROSION AND SEDIMENT CONTROL DATED 2002.
- THE CONTRACTOR SHALL INSTALL ALL EROSION AND SEDIMENTATION CONTROL, PRIOR TO ANY GRADING ACTIVITIES AND MAINTAIN SEDIMENTATION CONTROLS AT ALL TIMES DURING CONSTRUCTION. ALL SOIL EROSION AND SEDIMENTATION CONTROL MEASURES ARE SUBJECT TO INSPECTION AND MONITORING BY THE CONTRACTOR.
- ALL AREA DISTURBED BY THE CONSTRUCTION OF IMPROVEMENTS SHALL BE RESTORED BY THE CONTRACTOR TO EXISTING CONDITIONS.
- COORDINATION, LAYOUT AND FURNISHING OF CONDUIT, CABLE AND ALL APPURTENANCES REQUIRED FOR PROPER INSTALLATION OF ELECTRICAL AND TELECOMMUNICATION SERVICE SHALL BE SOLELY THE RESPONSIBILITY OF THE CONTRACTOR.
- THE EXACT SHELTER FOUNDATION SIZE AND SHELTER FLOOR PENETRATIONS FOR UTILITIES SHALL BE CONFIRMED WITH THE SHELTER PENETRATIONS AND PLANS PRIOR TO LAUNCH.
- ALL UTILITY WORK SHALL BE IN ACCORDANCE WITH LOCAL UTILITY COMPANY REQUIREMENTS AND SPECIFICATIONS.
- THE CONTRACTOR SHALL CONTACT "TOLL BEFORE YOU DIG" AT LEAST 48 HOURS PRIOR TO ANY EXCAVATIONS.
- IF ANY FIELD CONDITIONS PRECLUDE COMPLIANCE WITH THE DRAWINGS AND/OR CONDITIONS PRECEDE, THE CONTRACTOR SHALL IMMEDIATELY NOTIFY THIS CELLULAR CARRIER AND SHALL NOT PROCEED WITH ANY AFFECTED WORK.
- THE CONTRACTOR SHALL STABILIZE ALL UTILITY LINE TRENCHES WITHIN FIVE WORKING DAYS AFTER EXCAVATION UNLESS OTHERWISE APPROVED BY THIS CELLULAR CARRIER.

SOIL
1. SOIL BEARING CAPACITY OF 3,000 PSF USED FOR FOUNDATION DESIGN.
GENERAL CONTRACTOR RESPONSIBLE FOR VERIFYING BEARING CAPACITIES.
2. ALL SURFACES MUST BE FREE OF STANDING WATER PRIOR TO PLACING CONCRETE
3. COMPACTED GRANULAR FILM PER CONNECTICUT DOT STANDARD SPEC FORM 814A 1995, SECTION 2.14.01 THROUGH 2.14.03.
4. CONTACT THE ENGINEER IF GROUND WATER IS IN ENCOUNTERED AND DEWATERING IS REQUIRED.

PROJECT NO: 36931054.000002
JOB NO: V71 229
DRAWN BY: KAP
CHECKED BY:
ISSUED FOR: 0 01-10-08 STATE COUNCIL
1 01-18-08 REVIEW
SC-3 SCALE: NTS

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FARMINGTON
NORTH 2
199 TOWN FARM ROAD
FARMINGTON, CONNECTICUT
06032
SCALE: AS NOTED
SITE DETAILS AND NOTES


SC-3
2 ICE BRIDGE DETAIL
SC-3 SCALE: 1'-0" - 1'-0"
NOTE:
1. MAXIMUM 10' SPACING BETWEEN POST SUPPORTS
2. 3 POSTS REQUIRED

2 ICE BRIDGE DETAIL
SC-3 SCALE: 1'-0" - 1'-0"


3 ICE BRIDGE DETAIL
SC-3 SCALE: 1'-0" - 1'-0"

4 GRAVEL COMPOUND DETAIL
SC-3 SCALE: 1/2" = 1'-0"
NOTE:
1. 6" GRAVEL COMPOUND FINISH-3/4" GRAVEL THOROUGHLY COMPAKTED
2. WOVEN GEOTEXTILE FABRIC (WAGOC 2002 OR APPROVED EQUAL)

5 CHAIN LINK FENCE DETAIL
SC-3 SCALE: NTS
NOTE:
1. WHERE EXISTING UTILITIES ARE LIKELY TO BE ENCOUNTERED, CONTRACTOR SHALL HAND DIG AND PROTECT EXISTING UTILITIES.
2. WHERE EXISTING UTILITIES ARE LIKELY TO BE ENCOUNTERED, CONTRACTOR SHALL HAND DIG AND PROTECT EXISTING UTILITIES.

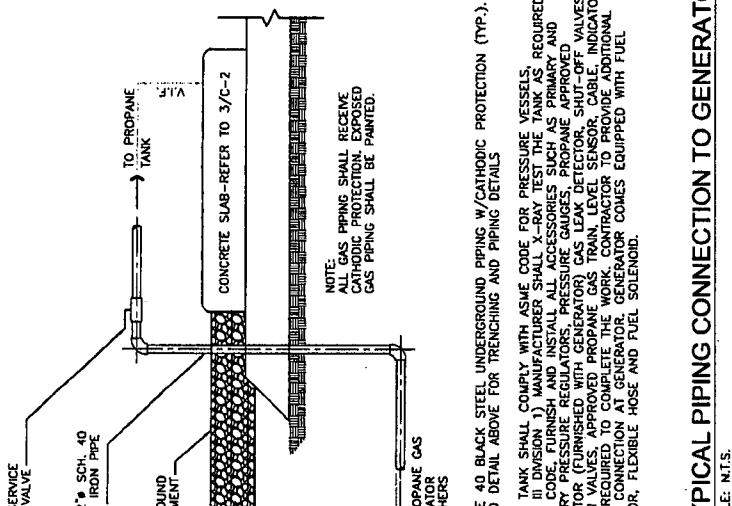


7 TYPICAL PIPING CONNECTION TO GENERATOR

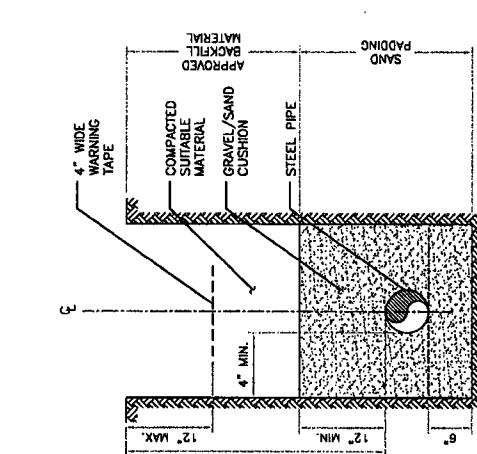


6 CONCRETE SLAB DETAIL (PROPANE TANK)

SC-3 SCALE: 3/4" = 1'-0"

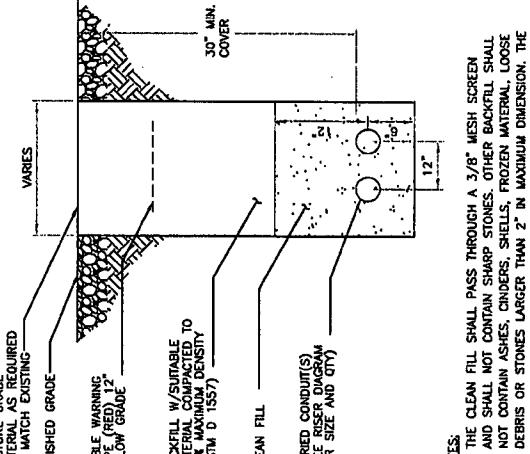


9 TYPICAL BURIED GAS LINE DETAIL

SC-3


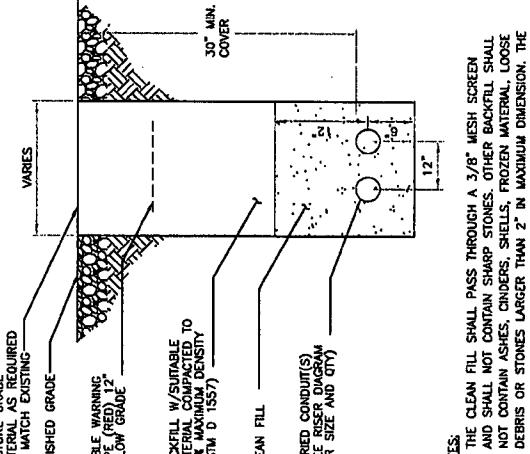


8 TYPICAL UTILITY TRENCH DETAIL

SC-3 SCALE: NTS

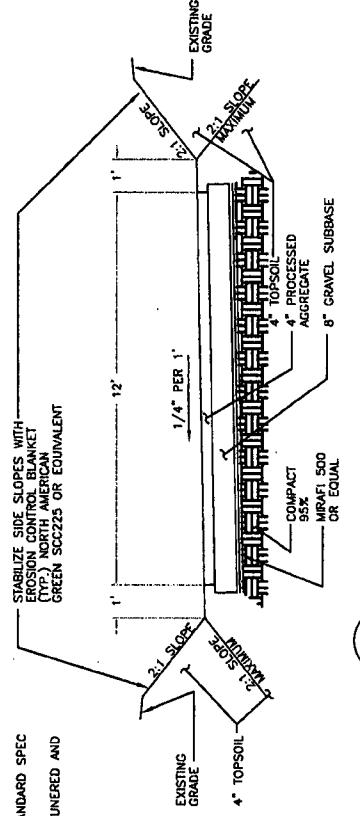

1 GRAVEL ACCESS DRIVE TYPICAL SECTION

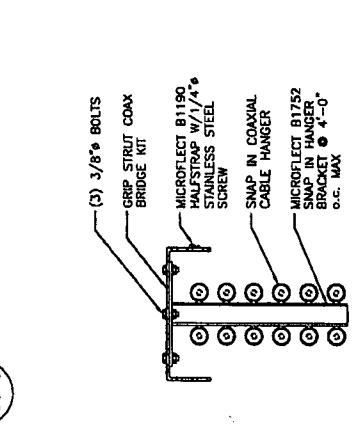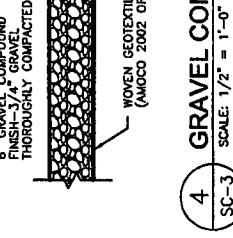

5 CHAIN LINK FENCE DETAIL

SC-3 SCALE: NTS

